ANNEXURE

TVL. SRI RAJALAKSHMI SAMAPPA ROUGH STONE & GRAVEL QUARRY

Bilichi Village, Coimbatore North Taluk, Coimbatore District, Tamil Nadu State

CLUSTER EXTENT = 7.23.0 Ha

ToR obtained vide

Lr No. SEIAA- TN/F.No.9051/SEAC/ToR-1167/2022 Dated: 06.06.2022

Project Proponent	Proposed Project	Extent
Tvl. Sri Rajalakshmi Samappa Building Materials Company, No. 677/1A, Vellamadai, Coimbatore District - 641 110.	S.F. Nos:1120/2 & 1121/2, Bilichi Village, Coimbatore North Taluk, Coimbatore District.	2.60.5 ha

LIST OF ANNEXURES

Proposed Quarry		
P1	Copy of ToR	1-20
Tvl. Sri Rajalakshmi Samappa	Copy of 500m Radius Letter	21-22
	Copy of Mining plan approval letter	23-24
	Copy of Approved Mining plan and Drawing	25-97
	Existing Quarry	
E1 Thiru.P. Sidharthamouli	Copy of Mining Plan	98-163
	Copy of Lab data	164-207
	Copy of Consultant Accreditation certificate	208



TMT. P. RAJESWARI, LF.S., MEMBER SECRETARY

STATE LEVEL ENVIRONMENT IMPACT ASSESSMENT AUTHORITY – TAMIL NADU

3rd Floor, Panagal Maaligai, No.1 Jeenis Road, Saidapet, Chennai-15. Phone No.044-24359973 Fax No. 044-24359975

TERMS OF REFERENCE (ToR)

Lr No.SEIAA-TN/F.No.9051/SEAC/ToR- 1167/2022 Dated: 06.06.2022

To

Tvl.Sri Rajalakshmi samappa Building Material Company No.677/1A, Vellamadai Coimbatore District – 641110

Sir / Madam,

Sub: SEIAA, Tamil Nadu – Terms of Reference with Public Hearing (ToR) for the Proposed Rough Stone & Gravel quarry lease over an extent of 2.60.5 Ha in, S.F.Nos. 1120/2 & 1121/2 of Bilichi Village, Coimbatore North Taluk, Coimbatore District, Tamil Nadu by Tvl. Sri Rajalakshmi Samappa Building Materials Company - under project category – "B1" and Schedule S.No. 1(a) – ToR issued along with Public Hearing- preparation of EIA report – Regarding.

Ref: 1. Online proposal No.SIA/TN/MIN/72677/2022, dated: 26.02.2022

- 2. Your application seeking Terms of Reference submitted on: 03.03.2022
- 3. Minutes of the 273rd Meeting of SEAC held on 14.05.2022
- 4. Minutes of the 518th Meeting of SEIAA held on 06.06.2022.

Kindly refer to your proposal submitted to the State Level Environment Impact Assessment Authority for Terms of Reference.

Page 1 of 20

SEIAA-TN

The project proponent, Tvl. Sri Rajalakshmi Samappa Building Materials Company has submitted application seeking ToR for B1 category project in Form-I, for the Rough Stone & Gravel quarry lease over an extent of 2.60.5 Ha in, S.F.Nos. 1120/2 & 1121/2 of Bilichi Village, Coimbatore North Taluk, Coimbatore District, Tamil Nadu and has furnished Pre-feasibility report.

The proposal was placed in 273rd SEAC meeting held on 14.5,2022. The project proponent gave detailed presentation. SEAC noted the following:

- The Project Proponent, Tvl. Sri Rajalakshmi Samappa Building Materials Company has applied for Terms for Reference for the proposed Rough stone & gravel quarry lease over an extent of 2.60.5 Ha in S.F.Nos. 1120/2 & 1121/2 of Bilichi Village, Coimbatore North Taluk, Coimbatore District, Tamil Nadu.
- The project/activity is covered under Category "B1" of Item 1(a) "Mining Projects" of the Schedule to the EIA Notification, 2006.
- 3. As per the mining plan, the lease period is 5 year. The production as per mining plan for 5 years is not to exceed 2,53,220m3 of Rough stone, 25576 m3 of gravel & 15360m3 of existing gravel dump. The Annual peak production as per mining plan is 51280 m3 of Rough Stone(4th year) & 15360m3 of gravel & gravel dump (2nd year) with ultimate depth 37m (2m Gravel + 35m Rough Stone) BGL.

Based on the presentation made by the proponent and the documents furnished, SEAC decided to recommend the proposal for the grant of Terms of Reference (TOR) with Public Hearing, subject to the following TORs, in addition to the standard terms of reference for EIA study for non-coal mining projects and details issued by the MOEF & CC to be included in EIA/EMP Report:

- The Proponent shall carry out the cumulative & comprehensive impact study due to mining operations carried out in the quarry cluster specifically with reference to the environment in terms of air pollution, water pollution & health impacts, accordingly the Environment Management plan should be prepared keeping the concerned quarry and the surrounding habitations in the mind.
- 2. The PP shall carry out controlled blasting & vibration study with the reputed institution and furnish the same along with EIA report.

MEMBER SECR

Page 2 of 20

- 3. Certified EC compliance report shall be included in the EIA report.
- If the proponent has already carried out the mining activity in the proposed mining lease area after 15.01.2016, then the proponent shall furnish the following details from AD/DD, mines,
 - a) What was the period of the operation and stoppage of the earlier mines with last work permit issued by the AD/DD mines?
 - b) Quantity of minerals mined out.
 - c) Highest production achieved in any one year
 - d) Detail of approved depth of mining.
 - e) Actual depth of the mining achieved earlier.
 - f) Name of the person already mined in that leases area.
 - g) If EC and CTO already obtained, the copy of the same shall be submitted.
 - h) Whether the mining was carried out as per the approved mine plan (or EC if issued) with stipulated benches.
- 5. All corner coordinates of the mine lease area, superimposed on a High Resolution Imagery/Topo sheet, topographic sheet, geomorphology, lithology and geology of the mining lease area should be provided. Such an Imagery of the proposed area should clearly show the land use and other ecological features of the study area (core and buffer zone).
- The PP shall carry out Drone video survey covering the cluster, Green belt, fencing etc.,
- 7. The proponent shall furnish photographs of adequate fencing, green belt along the periphery including replantation of existing trees & safety distance between the adjacent quarries & water bodies nearby provided as per the approved mining plan.
- 8. The Project Proponent shall provide the details of mineral reserves and mineable reserves, planned production capacity, proposed working methodology with justifications, the anticipated impacts of the mining operations on the surrounding environment and the remedial measures for the same.
- The Project Proponent shall provide the Organization chart indicating the appointment of various statutory officials and other competent persons to be appointed as per the provisions of Mines Act'1952 and the MMR, 1961 for carrying

- out the quarrying operations scientifically and systematically in order to ensure safety and to protect the environment.
- 10. The Project Proponent shall conduct the hydro-geological study considering the contour map of the water table detailing the number of ground water pumping & open wells, and surface water bodies such as rivers, tanks, canals, ponds etc. within 1 km (radius) along with the collected water level data for both monsoon and non-monsoon seasons from the PWD / TWAD so as to assess the impacts on the wells due to mining activity. Based on actual monitored data, it may clearly be shown whether working will intersect groundwater. Necessary data and documentation in this regard may be provided.
- 11. The proponent shall furnish the baseline data for the environmental and ecological parameters with regard to surface water/ground water quality, air quality, soil quality & flora/fauna including traffic/vehicular movement study.
- 12. A tree survey study shall be carried out (nos., name of the species, age, diameter etc.,) both within the mining lease applied area & 300m buffer zone and its management during mining activity.
- 13. A detailed mine closure plan for the proposed project shall be included in EIA/EMP report which should be site-specific.
- 14. The Public hearing advertisement shall be published in one major National daily and one most circulated vernacular daily.
- 15. The PP shall produce/display the EIA report, Executive summery and other related with respect to public hearing should in Tamil Language also.
- 16. The recommendation for the issue of "Terms of Reference" is subjected to the outcome of the Hon'ble NGT, Principal Bench, New Delhi in O.A No.186 of 2016 (M.A.No.350/2016) and O.A. No.200/2016 and O.A.No.580/2016 (M.A.No.1182/2016) and O.A.No.102/2017 and O.A.No.404/2016 (M.A.No.758/2016, M.A.No.920/2016, M.A.No.1122/2016, M.A.No.12/2017 & M.A. No. 843/2017) and O.A.No.405/2016 and O.A.No.520 of 2016 (M.A.No. 981/2016, M.A.No.982/2016 & M.A.No.384/2017).
- 17. The purpose of Green belt around the project is to capture the fugitive emissions, carbon sequestration and to attenuate the noise generated, in addition to improving

MEMBER SECRETARY SEIAA-TN the aesthetics. A wide range of indigenous plant species should be planted as given in the appendix in consultation with the DFO, State Agriculture University and local school/college authorities. The plant species with dense/moderate canopy of native origin should be chosen. Species of small/medium/tall trees alternating with shrubs should be planted in a mixed manner.

- 18. Taller/one year old Saplings raised in appropriate size of bags, preferably ecofriendly bags should be planted in proper espacement as per the advice of local forest authorities/botanist/Horticulturist with regard to site specific choices. The proponent shall earmark the greenbelt area with GPS coordinates all along the boundary of the project site with at least 3 meters wide and in between blocks in an organized manner
- 19. A Disaster management Plan shall be prepared and included in the EIA/EMP Report.
- A Risk Assessment and management Plan shall be prepared and included in the EIA/EMP Report.
- 21. The specific flora & fauna studies shall be carry out with the help of local School/College students and the same shall be included in EIA Report.
- 22. The Socio-economic studies should be carried out within a 5 km buffer zone from the mining activity. Measures of socio-economic significance and influence to the local community proposed to be provided by the Project Proponent should be indicated. As far as possible, quantitative dimensions may be given with time frames for implementation.
- 23. If any quarrying operations were carried out in the proposed quarrying site for which now the EC is sought, the Project Proponent shall furnish the detailed compliance to EC conditions given in the previous EC with the site photographs which shall duly be certified by MoEF&CC, Regional Office, Chennai (or) the concerned DEE/TNPCB.
- 24. Concealing any factual information or submission of false/fabricated data and failure to comply with any of the conditions mentioned above may result in withdrawal of this Terms of Reference besides attracting penal provisions in the Environment (Protection) Act, 1986.

Appendix -I List of Native Trees Suggested for Planting

Aeglemarmelos-Vilvam

Page 5 of 20

- 2. Adenaantherapavonina-Manjadi
- 3. Albizialebbeck-Vaagai
- 4. Albiziaamara-Usil
- 5. Bauhinia purpurea Mantharai
- 6. Bauhinia racemosa Aathi
- 7. Bauhinia tomentosa-Iruvathi
- 8. Buchananiaaillaris-Kattuma
- 9. Borassusflabellifer- Panai
- 10. Buteamonosperma Murukkamaram
- 11. Bobaxceiba- Ilavu, Sevvilavu
- 12. Calophylluminophyllum Punnai
- 13. Cassia fistula- Sarakondrai
- 14. Cassia roxburghii- Sengondrai
- 15. Chloroxylonsweitenia Purasamaram
- 16. Cochlospermumreligiosum- Kongu, Manjalllavu
- 17. Cordiadichotoma- Mookuchalimaram
- 18. Cretevaadansonii-Mavalingum
- 19. Dilleniaindica-Uva, Uzha
- 20. Dilleniapentagyna-SiruUva, Sitruzha
- 21. Diospyrosebenum- Karungali
- 22. Diospyroschloroxylon-Vaganai
- 23. Ficusamplissima-Kalltchi
- 24. Hibiscus tiliaceous-Aatrupoovarasu
- 25. Hardwickiabinata- Aacha
- 26. Holopteliaintegrifolia-Aayili
- 27. Lanneacoromandelica Odhiam
- 28. Lagerstroemia speciosa Poo Marudhu
- 29. Lepisanthustetraphylla- Neikottaimaram
- 30. Limoniaacidissima Vila maram
- 31. Litseaglutinosa-Pisinpattai
- 32. Madhucalongifolia Illuppai
- 33. Manilkarahexandra-UlakkaiPaalai
- 34. Mimusopselengi Magizhamaram
- 35. Mitragynaparvifolia Kadambu
- 36. Morindapubescens-Nuna
- 37. Morindacitrifolia- VellaiNuna
- 38. Phoenix sylvestre-Eachai
- 39. Pongamiapinnata-Pungam
- 40. Premnamollissima- Munnai
- 41. Premnaserratifolia- Narumunnai
- 42. Premnatomentosa-PurangaiNaari, PudangaNaari

MEMBER SECRETARY SEIAA-TN

Page 6 of 20

- 43. Prosopiscinerea Vannimaram
- 44. Pterocarpusmarsupium Vengai
- 45. Pterospermumcanescens-Vennangu, Tada
- 46. Pterospermumxylocarpum Polavu
- 47. Puthranjivaroxburghii-Puthranjivi
- 48. Salvadorapersica- UgaaMaram
- 49. Sapindusemarginatus- Manipungan, Soapukai
- 50. Saracaasoca Asoca
- 51. Streblusasper- Pirayamaram
- 52. Strychnosnuxvomica-Yetti
- 53. Strychnospotatorum TherthangKottai
- 54. Syzygiumcumini Naval
- 55. Terminaliabellerica- Thandri
- 56. Terminalia arjuna- Venmarudhu
- 57. Toona ciliate Sandhanavembu
- 58. Thespesiapopulnea- Puvarasu
- 59. Walsuratrifoliata-valsura
- 60. Wrightiatinctoria- Vep

Discussion by Authority and the Remarks

The proposal was placed in the 518th Authority meeting held on 06.06.2022. After detailed discussions, the Authority accepts the recommendation of SEAC and decided to grant Terms of Reference (ToR) along with Public Hearing under cluster for undertaking the combined Environment Impact Assessment Study and preparation of separate Environment Management Plan subject to the conditions as recommended by SEAC & normal condition in addition to the following conditions:

- Detailed study shall be carried out regard to impact of mining around the proposed mine lease area on the nearby Villages, Water-bodies/ Rivers, & any ecological fragile areas.
- The project proponent shall furnish VAO certificate with reference to 300m radius regard to approved habitations, schools, Archaeological structures etc.
- As per the MoEF& CC office memorandum F.No.22-65/2017-IA.III dated: 30.09.2020
 and 20.10.2020 the proponent shall address the concerns raised during the public
 consultation and all the activities proposed shall be part of the Environment Management
 Plan.
- The Environmental Impact Assessment shall study in detail on the carbon emission and also suggest the measures to mitigate carbon emission including development of carbon

MEMBER SECRETARY SEIAATT

Page 7 of 20

- sinks and temperature reduction including control of other emission and climate mitigation activities.
- The Environmental Impact Assessment should study the biodiversity, the natural ecosystem, the soil micro flora, fauna and soil seed banks and suggest measures to maintain the natural Ecosystem.
- Action should specifically suggest for sustainable management of the area and restoration of ecosystem for flow of goods and services.
- The project proponent shall study impact on fish habitats and the food WEB/ food chain in the nearby water body and Reservoir.
- The Terms of Reference should specifically study impact on soil health, soil erosion, the soil physical, chemical components and microbial components.
- The Environmental Impact Assessment should study impact on forest, vegetation, endemic, vulnerable and endangered indigenous flora and fauna.
- 10. The Environmental Impact Assessment should study impact on standing trees and the existing trees should be numbered and action suggested for protection.
- 11. The Environmental Impact Assessment should study on wetlands, water bodies, rivers streams, lakes and farmer sites.
- 12. The Environmental Impact Assessment should hold detailed study on EMP with budget for Green belt development and mine closure plan including disaster management plan.
- 13. The Environmental Impact Assessment should study impact on climate change, temperature rise, pollution and above soil & below soil carbon stock.
- 14. The Environmental Impact Assessment should study impact on protected areas, Reserve Forests, National Parks, Corridors and Wildlife pathways, near project site.
- 15. The project proponent shall study and furnish the impact of project on plantations in adjoin patta lands, Horticulture, Agriculture and livestock.
- 16. The project proponent shall study and furnish the details on potential fragmentation impact of natural environment, by the activities.
- 17. The project proponent shall study and furnish the impact on aquatic plants and animals in water bodies and possible scars on the landscape, damages to nearby caves, heritage site, and archaeological sites possible land form changes visual and aesthetic impacts.

Page 8 of 20

- 18. The project proponent shall study and furnish the possible pollution due to plastic and microplastic on the environment. The ecological risks and impacts of plastic & microplastics on aquatic environment and fresh water systems due to activities, contemplated during mining may be investigated and reported.
- The project proponent shall study on impact of mining on Reserve forests free ranging wildlife.
- 20. Detailed study shall be carried out in regard to impact of mining around the proposed mine lease area covering the entire mine lease period as per precise area communication order issued from reputed research institutions on the following
 - a) Soil health & bio-diversity.
 - b) Climate change leading to Droughts, Floods etc.
 - c) Pollution leading to release of Greenhouse gases (GHG), rise in Temperature, & Livelihood of the local people.
 - d) Possibilities of water contamination and impact on aquatic ecosystem health.
 - e) Agriculture, Forestry & Traditional practices.
 - f) Hydrothermal/Geothermal effect due to destruction in the Environment.
 - g) Bio-geochemical processes and its foot prints including environmental stress.
 - h) Sediment geochemistry in the surface streams.
- 21. Hydro-geological study considering the contour map of the water table detailing the number of ground water pumping & open wells, and surface water bodies such as rivers, tanks, canals, ponds etc. within 1 km (radius) so as to assess the impacts on the nearby waterbodies due to mining activity. Based on actual monitored data, it may clearly be shown whether working will intersect groundwater. Necessary data and documentation in this regard may be provided, covering the entire mine lease period.
- 22. To furnish disaster management plan and disaster mitigation measures in regard to all aspects to avoid/reduce vulnerability to hazards & to cope with disaster/untoward accidents in & around the proposed mine lease area due to the proposed method of mining activity & its related activities covering the entire mine lease period as per precise area communication order issued.
- 23. To furnish risk assessment and management plan including anticipated vulnerabilities during operational and post operational phases of Mining.

Page 9 of 20

- 24. Detailed Mine Closure Plan covering the entire mine lease period as per precise area communication order issued.
- 25. Detailed Environment Management Plan along with adaptation, mitigation & remedial strategies covering the entire mine lease period as per precise area communication order issued.

A. STANDARD TERMS OF REFERENCE

- Year-wise production details since 1994 should be given, clearly stating the highest production achieved in any one year prior to 1994. It may also be categorically informed whether there had been any increase in production after the EIA Notification 1994 came into force, w.r.t. the highest production achieved prior to 1994.
- A copy of the document in support of the fact that the Proponent is the rightful lessee of the mine should be given.
- 3) All documents including approved mine plan, EIA and Public Hearing should be compatible with one another in terms of the mine lease area, production levels, waste generation and its management, mining technology etc. and should be in the name of the lessee.
- 4) All corner coordinates of the mine lease area, superimposed on a High Resolution Imagery/ topo sheet, topographic sheet, geomorphology and geology of the area should be provided. Such an Imagery of the proposed area should clearly show the land use and other ecological features of the study area (core and buffer zone).
- 5) Information should be provided in Survey of India Topo sheet in 1:50,000 scale indicating geological map of the area, geomorphology of land forms of the area, existing minerals and mining history of the area, important water bodies, streams and rivers and soil characteristics.
- 6) Details about the land proposed for mining activities should be given with information as to whether mining conforms to the land use policy of the State; land diversion for mining should have approval from State land use board or the concerned authority.
- 7) It should be clearly stated whether the proponent Company has a well laid down Environment Policy approved by its Board of Directors? If so, it may be spelt out in the EIA Report with description of the prescribed operating process/procedures to bring into focus any infringement/deviation/ violation of the environmental or forest norms/

Page 10 of 20

conditions? The hierarchical system or administrative order of the Company to deal with the environmental issues and for ensuring compliance with the EC conditions may also be given. The system of reporting of non-compliances / violations of environmental norms to the Board of Directors of the Company and/or shareholders or stakeholders at large, may also be detailed in the EIA Report.

- 8) Issues relating to Mine Safety, including subsidence study in case of underground mining and slope study in case of open cast mining, blasting study etc. should be detailed. The proposed safeguard measures in each case should also be provided.
- 9) The study area will comprise of 10 km zone around the mine lease from lease periphery and the data contained in the EIA such as waste generation etc. should be for the life of the mine / lease period.
- 10) Land use of the study area delineating forest area, agricultural land, grazing land, wildlife sanctuary, national park, migratory routes of fauna, water bodies, human settlements and other ecological features should be indicated. Land use plan of the mine lease area should be prepared to encompass preoperational, operational and post operational phases and submitted. Impact, if any, of change of land use should be given.
- 11) Details of the land for any Over Burden Dumps outside the mine lease, such as extent of land area, distance from mine lease, its land use, R&R issues, if any, should be given.
- 12) Certificate from the Competent Authority in the State Forest Department should be provided, confirming the involvement of forest land, if any, in the project area. In the event of any contrary claim by the Project Proponent regarding the status of forests, the site may be inspected by the State Forest Department along with the Regional Office of the Ministry to ascertain the status of forests, based on which, the Certificate in this regard as mentioned above be issued. In all such cases, it would be desirable for representative of the State Forest Department to assist the Expert Appraisal Committees.
- 13) Status of forestry clearance for the broken up area and virgin forestland involved in the Project including deposition of Net Present Value (NPV) and Compensatory Afforestation (CA) should be indicated. A copy of the forestry clearance should also be

941

Page 11 of 20

furnished.

- 14) Implementation status of recognition of forest rights under the Scheduled Tribes and other Traditional Forest Dwellers (Recognition of Forest Rights) Act, 2006 should be indicated.
- 15) The vegetation in the RF / PF areas in the study area, with necessary details, should be given.
- 16) A study shall be got done to ascertain the impact of the Mining Project on wildlife of the study area and details furnished. Impact of the project on the wildlife in the surrounding and any other protected area and accordingly, detailed mitigative measures required, should be worked out with cost implications and submitted.
- 17) Location of National Parks, Sanctuaries, Biosphere Reserves, Wildlife Corridors, Ramsar site Tiger/ Elephant Reserves/(existing as well as proposed), if any, within 10 km of the mine lease should be clearly indicated, supported by a location map duly authenticated by Chief Wildlife Warden. Necessary clearance, as may be applicable to such projects due to proximity of the ecologically sensitive areas as mentioned above, should be obtained from the Standing Committee of National Board of Wildlife and copy furnished.
- 18) A detailed biological study of the study area [core zone and buffer zone (10 km radius of the periphery of the mine lease)] shall be carried out. Details of flora and fauna, endangered, endemic and RET Species duly authenticated, separately for core and buffer zone should be furnished based on such primary field survey, clearly indicating the Schedule of the fauna present. In case of any scheduled-I fauna found in the study area, the necessary plan along with budgetary provisions for their conservation should be prepared in consultation with State Forest and Wildlife Department and details furnished. Necessary allocation of funds for implementing the same should be made as part of the project cost.
- 19) Proximity to Areas declared as 'Critically Polluted' or the Project areas likely to come under the 'Aravali Range', (attracting court restrictions for mining operations), should also be indicated and where so required, clearance certifications from the prescribed Authorities, such as the SPCB or State Mining Department should be secured and furnished to the effect that the proposed mining activities could be considered.

Page 12 of 20

MEMBER SECRETAR

SEIAA-TN

- 20) Similarly, for Coastal Projects, a CRZ map duly authenticated by one of the authorized agencies demarcating LTL. HTL, CRZ area, location of the mine lease with respect to CRZ, coastal features such as mangroves, if any, should be furnished. (Note: The Mining Projects falling under CRZ would also need to obtain approval of the concerned Coastal Zone Management Authority).
- 21) R&R Plan/compensation details for the Project Affected People (PAP) should be furnished. While preparing the R&R Plan, the relevant State/National Rehabilitation & Resettlement Policy should be kept in view. In respect of SCs /STs and other weaker sections of the society in the study area, a need based sample survey, family-wise, should

be undertaken to assess their requirements, and action programmes prepared and submitted accordingly, integrating the sectoral programmes of line departments of the State Government. It may be clearly brought out whether the village(s) located in the mine lease area will be shifted or not. The issues relating to shifting of village(s) including their R&R and socio-economic aspects should be discussed in the Report.

- One season (non-monsoon) [i.e. March-May (Summer Season); October-December (post monsoon season); December-February (winter season)]primary baseline data on ambient air quality as per CPCB Notification of 2009, water quality, noise level, soil and flora and fauna shall be collected and the AAQ and other data so compiled presented date-wise in the EIA and EMP Report. Site-specific meteorological data should also be collected. The location of the monitoring stations should be such as to represent whole of the study area and justified keeping in view the pre-dominant downwind direction and location of sensitive receptors. There should be at least one monitoring station within 500 m of the mine lease in the pre-dominant downwind direction. The mineralogical composition of PM10, particularly for free silica, should be given.
- 23) Air quality modeling should be carried out for prediction of impact of the project on the air quality of the area. It should also take into account the impact of movement of Vehicles for transportation of mineral. The details of the model used and input parameters used for modeling should be provided. The air quality contours may be shown on a location map clearly indicating the location of the site, location of sensitive

- receptors, if any, and the habitation. The wind roses showing pre-dominant wind direction may also be indicated on the map.
- 24) The water requirement for the Project, its availability and source should be furnished. A detailed water balance should also be provided. Fresh water requirement for the Project should be indicated.
- 25) Necessary clearance from the Competent Authority for drawl of requisite quantity of water for the Project should be provided.
- 26) Description of water conservation measures proposed to be adopted in the Project should be given. Details of rainwater harvesting proposed in the Project, if any, should be provided.
- 27) Impact of the Project on the water quality, both surface and groundwater, should be assessed and necessary safeguard measures, if any required, should be provided.
- 28) Based on actual monitored data, it may clearly be shown whether working will intersect groundwater. Necessary data and documentation in this regard may be provided. In case the working will intersect groundwater table, a detailed Hydro Geological Study should be undertaken and Report furnished. The Report inter-alia, shall include details of the aquifers present and impact of mining activities on these aquifers. Necessary permission from Central Ground Water Authority for working below ground water and for pumping of ground water should also be obtained and copy furnished.
- 29) Details of any stream, seasonal or otherwise, passing through the lease area and modification / diversion proposed, if any, and the impact of the same on the hydrology should be brought out.
- 30) Information on site elevation, working depth, groundwater table etc. Should be provided both in AMSL and bgl. A schematic diagram may also be provided for the same.
- 31) A time bound Progressive Greenbelt Development Plan shall be prepared in a tabular form (indicating the linear and quantitative coverage, plant species and time frame) and submitted, keeping in mind, the same will have to be executed up front on commencement of the Project. Phase-wise plan of plantation and compensatory afforestation should be charted clearly indicating the area to be covered under plantation and the species to be planted. The details of plantation already done should

Page 14 of 20

- be given. The plant species selected for green belt should have greater ecological value and should be of good utility value to the local population with emphasis on local and native species and the species which are tolerant to pollution.
- 32) Impact on local transport infrastructure due to the Project should be indicated. Projected increase in truck traffic as a result of the Project in the present road network (including those outside the Project area) should be worked out, indicating whether it is capable of handling the incremental load. Arrangement for improving the infrastructure, if contemplated (including action to be taken by other agencies such as State Government) should be covered. Project Proponent shall conduct Impact of Transportation study as per Indian Road Congress Guidelines.
- 33) Details of the onsite shelter and facilities to be provided to the mine workers should be included in the EIA Report.
- 34) Conceptual post mining land use and Reclamation and Restoration of mined out areas (with plans and with adequate number of sections) should be given in the EIA report.
- 35) Occupational Health impacts of the Project should be anticipated and the proposed preventive measures spelt out in detail. Details of pre-placement medical examination and periodical medical examination schedules should be incorporated in the EMP. The project specific occupational health mitigation measures with required facilities proposed in the mining area may be detailed.
- 36) Public health implications of the Project and related activities for the population in the impact zone should be systematically evaluated and the proposed remedial measures should be detailed along with budgetary allocations.
- 37) Measures of socio economic significance and influence to the local community proposed to be provided by the Project Proponent should be indicated. As far as possible, quantitative dimensions may be given with time frames for implementation.
- 38) Detailed Environmental Management Plan (EMP) to mitigate the environmental impacts which, should inter-alia include the impacts of change of land use, loss of agricultural and grazing land, if any, occupational health impacts besides other impacts specific to the proposed Project.
- 39) Public Hearing points raised and commitment of the Project Proponent on the same along with time bound Action Plan with budgetary provisions to implement the same

Page 15 of 20

- should be provided and also incorporated in the final EIA/EMP Report of the Project.
- 40) Details of litigation pending against the project, if any, with direction /order passed by any Court of Law against the Project should be given.
- 41) The cost of the Project (capital cost and recurring cost) as well as the cost towards implementation of EMP should be clearly spelt out.
- 42) A Disaster management Plan shall be prepared and included in the EIA/EMP Report.
- 43) Benefits of the Project if the Project is implemented should be spelt out. The benefits of the Project shall clearly indicate environmental, social, economic, employment potential, etc.
- 44) Besides the above, the below mentioned general points are also to be followed:
 - a) Executive Summary of the EIA/EMP Report
 - All documents to be properly referenced with index and continuous page numbering,
 - c) Where data are presented in the Report especially in Tables, the period in which the data were collected and the sources should be indicated.
 - d) Project Proponent shall enclose all the analysis/testing reports of water, air, soil, noise etc. using the MoEF&CC/NABL accredited laboratories. All the original analysis/testing reports should be available during appraisal of the Project.
 - Where the documents provided are in a language other than English, an English translation should be provided.
 - f) The Questionnaire for environmental appraisal of mining projects as devised earlier by the Ministry shall also be filled and submitted.
 - g) While preparing the EIA report, the instructions for the Proponents and instructions for the Consultants issued by MoEF&CC vide O.M. No. J-11013/41/2006-IA.II(I) dated 4th August, 2009, which are available on the website of this Ministry, should be followed.
 - h) Changes, if any made in the basic scope and project parameters (as submitted in Form-I and the PFR for securing the TOR) should be brought to the attention of MoEF&CC with reasons for such changes and permission should be sought, as the ToR may also have to be altered. Post Public Hearing changes in structure and content of the draft EIA/EMP (other than modifications arising out of the

Page 16 of 20

P.H. process) will entail conducting the PH again with the revised documentation.

- i) As per the circular no. J-11011/618/2010-IA.II(I) dated 30.5.2012, certified report of the status of compliance of the conditions stipulated in the Environment Clearance for the existing operations of the project, should be obtained from the Regional Office of Ministry of Environment, Forest and Climate Change, as may be applicable.
- j) The EIA report should also include (i) surface plan of the area indicating contours of main topographic features, drainage and mining area, (ii) geological maps and sections and (iii) sections of the mine pit and external dumps, if any, clearly showing the land features of the adjoining area.

In addition to the above, the following shall be furnished:-

The Executive summary of the EIA/EMP report in about 8-10 pages should be prepared incorporating the information on following points:

- 1. Project name and location (Village, District, State, Industrial Estate (if applicable).
- Process description in brief, specifically indicating the gaseous emission, liquid effluent and solid and hazardous wastes.
- Measures for mitigating the impact on the environment and mode of discharge or disposal.
- 4. Capital cost of the project, estimated time of completion.
- The proponent shall furnish the contour map of the water table detailing the number of wells located around the site and impacts on the wells due to mining activity.
- 6. A detailed study of the lithology of the mining lease area shall be furnished.
- 7. Details of village map, "A" register and FMB sketch shall be furnished.
- Detailed mining closure plan for the proposed project approved by the Geology of Mining department shall be shall be submitted along with EIA report.
- Obtain a letter /certificate from the Assistant Director of Geology and Mining standing
 that there is no other Minerals/resources like sand in the quarrying area within the
 approved depth of mining and below depth of mining and the same shall be furnished in
 the EIA report.
- EIA report should strictly follow the Environmental Impact Assessment Guidance Manual for Mining of Minerals published February 2010.

- Detail plan on rehabilitation and reclamation carried out for the stabilization and restoration of the mined areas.
- 12. The EIA study report shall include the surrounding mining activity, if any.
- 13. Modeling study for Air, Water and noise shall be carried out in this field and incremental increase in the above study shall be substantiated with mitigation measures.
- 14. A study on the geological resources available shall be carried out and reported.
- 15. A specific study on agriculture & livelihood shall be carried out and reported.
- Impact of soil erosion, soil physical chemical and biological property changes may be assumed.
- 17. Site selected for the project Nature of land Agricultural (single/double crop), barren, Govt./ private land, status of is acquisition, nearby (in 2-3 km.) water body, population, with in 10km other industries, forest, eco-sensitive zones, accessibility, (note in case of industrial estate this information may not be necessary)
- 18. Baseline environmental data air quality, surface and ground water quality, soil characteristic, flora and fauna, socio-economic condition of the nearby population
- Identification of hazards in handling, processing and storage of hazardous material and safety system provided to mitigate the risk.
- 20. Likely impact of the project on air, water, land, flora-fauna and nearby population
- 21. Emergency preparedness plan in case of natural or in plant emergencies
- 22. Issues raised during public hearing (if applicable) and response given
- 23. CER plan with proposed expenditure.
- 24. Occupational Health Measures
- 25. Post project monitoring plan
- 26. The project proponent shall carry out detailed hydro geological study through intuitions/NABET Accredited agencies.
- 27. A detailed report on the green belt development already undertaken is to be furnished and also submit the proposal for green belt activities.
- 28. The proponent shall propose the suitable control measure to control the fugitive emissions during the operations of the mines.
- 29. A specific study should include impact on flora & fauna, disturbance to migratory pattern of animals.

Page 18 of 20

- 30. Reserve funds should be earmarked for proper closure plan.
- 31. A detailed plan on plastic waste management shall be furnished. Further, the proponent should strictly comply with, Tamil Nadu Government Order (Ms) No.84 Environment and forests (EC.2) Department dated 25.06.2018 regarding ban on one time use and throw away plastics irrespective of thickness with effect from 01.01.2019 under Environment (Protection) Act, 1986. In this connection, the project proponent has to furnish the action plan.

Besides the above, the below mentioned general points should also be followed:-

- a. A note confirming compliance of the TOR, with cross referencing of the relevant sections / pages of the EIA report should be provided.
- All documents may be properly referenced with index, page numbers and continuous page numbering.
- c. Where data are presented in the report especially in tables, the period in which the data were collected and the sources should be indicated.
- d. While preparing the EIA report, the instructions for the proponents and instructions for the consultants issued by MoEF & CC vide O.M. No. J-11013/41/2006-IA.II (I) dated 4th August, 2009, which are available on the website of this Ministry should also be followed.
- e. The consultants involved in the preparation of EIA/EMP report after accreditation with Quality Council of India (QCI)/National Accreditation Board of Education and Training (NABET) would need to include a certificate in this regard in the EIA/EMP reports prepared by them and data provided by other organization/Laboratories including their status of approvals etc. In this regard circular no F. No.J 11013/77/2004-IA-II(I) dated 2nd December, 2009, 18th March 2010, 28th May 2010, 28th June 2010, 31st December 2010 & 30th September 2011 posted on the Ministry's website http://www.moef.nic.in/ may be referred.
 - After preparing the EIA (as per the generic structure prescribed in Appendix-III of the EIA Notification, 2006) covering the above mentioned points, the proponent will take further necessary action for obtaining environmental clearance in accordance with the procedure prescribed under the EIA Notification, 2006.

Page 19 of 20

- The final EIA report shall be submitted to the SEIAA, Tamil Nadu for obtaining Environmental Clearance.
- The TORs with public hearing prescribed shall be valid for a period of three years from the date of issue, for submission of the EIA/EMP report as per OMNo.J-11013/41/2006-IA-II(I)(part) dated 29th August, 2017.

MEMBER SE

Copy to:

- 1. The Additional Chief Secretary to Government, Environment & Forests Department, Govt. of Tamil Nadu, Fort St. George, Chennai - 9
- 2. The Chairman, Central Pollution Control Board, Parivesh Bhavan, CBD Cum-Office Complex, East Arjun Nagar, New Delhi 110032.
- 3. The Member Secretary, Tamil Nadu Pollution Control Board, 76, Mount Salai, Guindy, Chennai-600 032.
- 4. The APCCF (C), Regional Office, MoEF & CC (SZ), 34, Chennai -34.
- 5. Monitoring Cell, IA Division, Ministry of Environment, Forests & CC, Paryavaran Bhavan, CGO Complex, New Delhi 110003
- oteets if She is Pro 6. The District Collector, Coimbatore District.
- 7. Stock File.

From
Thiru.S.Rameshkumar, M.Sc.,
Assistant Director,
Dept. of Geology and Mining,
Coimbatore.

To Tvl.Sri Rajalakshmi Samappa Building Materials Company, No.677/1A, Vellamadai, Coimbatore District.

Rc.No.875/Mines/2021 Dated: 31.12.2021

Sir,

Sub: Mines & Minerals - Minor Mineral - Coimbatore
District - Coimbatore North Taluk - Bilichi Village Survey Nos.1120/2 (1.52.50 Hec) and 1121/2 (1.08.00
Hec) - over an extent of 2.60.50 hectares of patta land
- Application preferred by Tvl.Sri Rajalakshmi
Samappa Building Materials Company for quarrying
Roughstone and Gravel - Precise area communicated Details of quarries situated within 500 meter radial
distance - Requested - furnished - reg.

- Ref. 1. Assistant Director, Dept. of Geology and Mining, Coimbatore Letter Rc.No.875/Mines/2021, Dated: 02.12.2021
 - Tvl.Sri Rajalakshmi Samappa Building Materials Company, Coimbatore letter dated 29.12.2021.

I invite kind attention to the reference cited wherein Tvl.Sri Rajalakshmi Samappa Building Materials Company has been issued precise area for the grant of Rough Stone and Gravel quarry lease over an extent of 2.60.50 hectares of patta land in Survey Nos.1120/2 (1.52.50 Hec) and 1121/2 (1.08.00 Hec) of Bilichi Village, Coimbatore North Taluk, Coimbatore District.

In the reference 2nd cited of Tvl.Sri Rajalakshmi Samappa Building Materials Company has requested to furnish details of quarries situated within 500 meter radial distance from the proposed area.

In this connection the details of abandoned, expired, existing and proposed quarries situated within 500 meter radial distance from the proposed area is furnished below.

Existing Quarries

Sl. No	Name of the Owner	Village &S.F.Nos.	Extent in Hect.	Lease period	Remarks
1.	Thiru.P.Siddharthamouli	Bilichi 1119, 1120, 1121	4.62.50	10.11.2020 to 09.11.2025	

ii) Expired Quarries

SI. No	Name of the Owner	Village &S.F.Nos.	Extent in Hect.	Lease period	Remar ks
		Nil			

iii) Abandoned quarries

	Sl. No.	Name of the Owner	Village &S.F.Nos.	Extent in Hect.	Lease period	Remarks
Nil			Nil			

iv) Proposed quarries

Sl. No	Name of the Owner	Village & S.F.Nos.	Extent in Hect.	Remarks
1	Tvl.Sri Rajalakshmi Samappa Building Materials Company	Billichi 1120/2, 1121/2	2.60.50	Subject area Precise area communicated

v) Future Proposed quarries

Sl. No.	Name of the Owner	Village &S.F.Nos.	Extent in Hect.	Remarks
		NII		

Assistant Director, Dept. of Geology and Mining, Coimbatore.

MARKETY

Battel 21

From
Thiru.S.Rameshkumar, M.Sc.,
Assistant Director,
Dept. of Geology and Mining,
Coimbatore.

To Tvl.Sri Rajalakshmi Samappa Building Materials Company, No.677/1A, Vellamadai, Coimbatore District.

Rc.No.875/Mines/2021 Dated: 31.12.2021

Sir,

Sub: Mines & Minerals - Minor Mineral - Coimbatore District Coimbatore North Taluk - Bilichi Village - Survey
Nos.1120/2 (1.52.50 Hec) and 1121/2 (1.08.00 Hec) over an extent of 2.60.50 hectares of patta land Application preferred by Tvl.Sri Rajalakshmi Samappa
Building Materials Company for quarrying Roughstone
and Gravel- Submission of mining plan for approval approved - regarding.

Ref: 1. Quarry lease application dated 12.07.2021 preferred by Tvl.Sri Rajalakshmi Samappa Building Materials Company, Coimbatore District.

 Assistant Director, Dept. of Geology and Mining, Coimbatore Letter Rc.No.875/Mines/2021, Dated: 02.12.2021.

 Tvl.Sri Rajalakshmi Samappa Building Materials Company letter dated 29.12.2021

In response to the precise area communicated by the Assistant Director of Geology and Mining, Coimbatore the applicant Tvl.Sri Rajalakshmi Samappa Building Materials Company vide reference 3rd cited has submitted three copies of mining plan for the grant of Roughstone and Gravel quarry lease over an extent of 2.60.50 hectares of patta land in Survey Nos.1120/2 (1.52.50 Hec) and 1121/2 (1.08.00 Hec) of Bilichi Village, Coimbatore Taluk, Coimbatore District.

- 2. The mining plan submitted for the grant of Rough stone and gravel quarry lease over an extent of 2.60.50 hectares of patta land in Survey Nos.1120/2 (1.52.50 Hec) and 1121/2 (1.08.00 Hec) of Bilichi Village, Coimbatore Taluk, Coimbatore District has been verified in detail.
- As per the guidelines/instructions issued by the Commissioner of Geology and Mining, Chennai vide letter Rc.No.3868/LC/2012, dated

19.11.2012, the mining plan is hereby approved, subject to the following conditions:

- (i) The mining plan is approved without prejudice to any other Law applicable to the quarry lease from time to time whether such laws are made by the Central Government, State Government or any other authority.
- (ii) This approval of the mining plan does not in any way imply the approval of the Government in terms or any other provisions of the Mines and Minerals (Development and Regulation) Amended Act, 2015, or any other connected laws including Forest (Conservation) Act, 1980, Forest Conservation Rules, 1981, Environment Protection Act, 1980, Explosives Act, 1884 (Central Act IV of 1884) and the Rules made there under and the Tamil Nadu Minor Mineral Concession Rules, 1959.
- (iii) The mining plan is approved without prejudice to any other order or direction from any court of competent jurisdiction.
- (iv) As per the Assistant Director, Dept. of Geology and Mining, Coimbatore letter Rc.No.875/Mines/2021, Dated: 02.12.2021 the following conditions have been incorporated in the Mining Plan.
 - a) A safety distance of 7.5 meters should be provided for the adjacent patta lands from the lease applied area.
 - v) Quarrying shall be done as per the approved Mining Plan and that the mining plan is approved without prejudice to any other law applicable to the quarry lease from time to time whether such laws are made by the Central Government, State Government or any other authority.

Encl: Two copies of Approved Mining Plan.

Assistant Director, Dept. of Geology and Mining, Coimbatore.

Copy submitted to: The Director of Geology and Mining, Chennai-32.





MINING PLAN AND PROGRESSIVE QUARRY CLOSURE PLAN FOR BILICHI ROUGH STONE AND GRAVEL QUARRY

(PREPARED UNDER RULES 41 & 42 AS PER THE AMENDED UNDER TAMIL NADU MINOR MINERAL CONCESSION RULES, 1959)

Lease period = Five years

IN

LOCATION OF THE QUARRY LEASE APPLIED AREA

EXTENT :

2.60.5Ha

S.F.Nos.

1120/2 & 1121/2

VILLAGE :

BILICHI

TALUK :

COIMBATORE NORTH

DISTRICT :

COIMBATORE

STATE

TAMIL NADU

FOR

APPLICANT

Tvl. Sri Rajalakshmi Samappa Building Materials Company,

No. 677/1A, Vellamadai, Coimbatore District, Tamil Nadu State – 641 110.

PREPARED BY

P. VISWANATHAN, M.Sc.,

Qualified Person

No.17, Advaitha Ashram Road, Alagapuram, Salem - 636 004. Cell: +91 94422 78601 & 94433 56539. E-Mail: infogeoexploration@gmail.com



Tvl. Sri Rajalakshmi Samappa Building Materials Company,

No. 677/1A, Vellamadai,

Coimbatore District,

Tamil Nadu State - 641 110.

CONSENT LETTER FROM THE APPLICANT

The Mining Plan and Progressive Quarry Closure plan in respect of Rough stone and Gravel Quarry lease applied area over an extent of 2.60.5 Hectares of patta lands in S.F.Nos. 1120/2 & 1121/2 of Bilichi Village, Coimbatore North Taluk, Coimbatore District, Tamil Nadu State has been prepared by

P. Viswanathan, M.Sc.,

Qualified Person

I request to the Assistant Director, Department of Geology and Mining, Coimbatore to make further correspondence regarding the modification of the Mining Plan with the said Qualified Person at his following address.

P. Viswanathan, M.Sc.,

No. 17, Advaitha Ashram Road,

Alagapuram, Salem - 636 004.

Cell: 94433 56539.

I hereby undertake that all the modifications, if any made in the Mining Plan by the Qualified Person may be deemed to have been made with my knowledge and consent and shall be acceptable to me and binding on me in all respects.

> Signature of the Applicant For Tvl. Sri Rajalakshmi Samappa Building Materials Company

> > S.Gnanasekaran

(Managing Partner & Authorized person)

Place: Coimbatore Date: 06.12.2021



Tvl. Sri Rajalakshmi Samappa Building Materials Company,

No. 677/1A, Vellamadai,

Coimbatore District,

Tamil Nadu State - 641 110.

DECLARATION OF THE APPLICANT

The Mining Plan and Progressive Quarry Closure plan in respect of Rough stone and Gravel Quarry lease applied area over an extent of 2.60.5 Hectares of patta lands in S.F.Nos. 1120/2 & 1121/2 of Bilichi Village, Coimbatore North Taluk, Coimbatore District, Tamil Nadu State has been prepared in full consultation with me.

I have understood its contents and agree to implement the same in accordance with Laws, Rules and Act applicable to Quarry.

Signature of the Applicant For Tvl. Sri Rajalakshmi Samappa Building Materials Company

S.Gnanasekaran

(Managing Partner & Authorized person)

Place: Coimbatore

Date: 06.12.2021



CERTIFICATE

Certified that I am, P. VISWANATHAN, M.Sc., having an office at Regd. Off. No. 17, Advaitha Ashram Road, Alagapuram, Salem – 636 004, holding a Post Graduate Degree in Applied Geology (M.Sc., Applied Geology) from Periyar University, Salem and I worked in the field of Geology in a role of Geologist.

Rule 15(I)(a) and (b) of Minerals (Other than Atomic and Hydro Carbons Energy Minerals) Concession Rules, 2016 stipulates the eligibility for preparing Mining plans as "(I)(a) a post graduate degree in Geology granted by a university established" and (I)(b) "Professional experience of five years of working in a supervisory capacity in the field of mining after obtaining the degree". Since my qualification and experience are satisfied the Rule (I)(a) and (I)(b) of 15 of the said Rules, I am eligible to prepare Mining Plans for both Major and Minor Minerals.

Accordingly, I am prepare this Mining Plan and Progressive Quarry Closure Plan in respect of Rough stone and Gravel Quarry for over an extent of 2.60.5 Hectares of patta lands in S.F.Nos. 1120/2 & 1121/2 of Bilichi Village, Coimbatore North Taluk, Coimbatore District, Tamil Nadu State for Tvl. Sri Rajalakshmi Samappa Building Materials Company, No. 677/1A, Vellamadai, Coimbatore District, Tamil Nadu State – 641 110. Since the Mining Plan is prepared as per the provisions contained in Rule 15(I)(a) and (I)(b) of Minerals (Other than Atomic and Hydro Carbons Energy Minerals) Concession Rules, 2016.

Signature of the Qualified Person

P. Viswanathan, M.Sc.,

) (() worthware

Place: Salem

Date: 10.12.2021



P. Viswanathan, M.Sc.,

No.17, Advaitha Ashram Road,

Alagapuram, Salem - 636 004.

Cell: +91 94422 78601 & 94433 56539.

CERTIFICATE FROM THE QUALIFIED PERSON

This is to certify that the Provisions of under Rules 41 & 42 as per the Amended under Tamil Nadu Minor Mineral Concession Rules, 1959 have been observed in the preparation of Mining Plan and Progressive Quarry Closure plan for Rough stone and Gravel Quarry lease applied area over an extent of 2.60.5 Hectares of patta lands in S.F.Nos. 1120/2 & 1121/2 of Bilichi Village, Coimbatore North Taluk, Coimbatore District, Tamil Nadu State has been prepared for

Tvl. Sri Rajalakshmi Samappa Building Materials Company,

No. 677/1A, Vellamadai,

Coimbatore District,

Tamil Nadu State - 641 110.

Whenever specific permissions / exemptions / relaxations and approvals are required, the Applicant will approach the concerned authorities of the Assistant Director, Department of Geology and Mining, Coimbatore, Tamil Nadu for such permissions/exemptions / relaxations and approvals.

It is also certified that information furnished in the above Mining plan are true and correct to the best of my knowledge.

Signature of the Qualified Person

P. Viswanathan, M.Sc.,

P. (mysters

Place: Salem

Date: 10.12.2021



P. Viswanathan, M.Sc.,

No.17, Advaitha Ashram Road,

Alagapuram, Salem-636 004.

Cell: +91 94422 78601 & 94433 56539.

CERTIFICATE FROM THE QUALIFIED PERSON

Certified that the Provisions of Mines Act, Rules and Regulations and Orders made there under have been observed in the preparation of Mining Plan and Progressive Quarry Closure plan for Rough stone and Gravel Quarry lease applied area for over an extent of 2.60.5 Hectares of patta lands in S.F.Nos. 1120/2 & 1121/2 of Bilichi Village, Coimbatore North Taluk, Coimbatore District, Tamil Nadu State has been prepared for Tvl. Sri Rajalakshmi Samappa Building Materials Company.

No. 677/1A, Vellamadai,

Coimbatore District.

Tamil Nadu State - 641 110.

Whenever specific permissions/ exemptions/ relaxations and approvals are required, the Applicant will approach the concerned authorities of Director General of Mines Safety (DGMS), No. 5, IInd Street, Block – AA, Anna Nagar, Chennai-40, Tamil Nadu for such permissions/exemptions/relaxations and approvals.

It is also certified that information furnished in the mining plan are true and correct to the best of my knowledge.

Signature of the Qualified Person

P. Viswanathan, M.Sc.,

Engrand de

Place: Salem

Date: 10.12.2021



LIST OF CONTENTS

31 DEC 2021

S. No.	Description	Page No.
1.0	Introduction and Executive Summary	1
2.0	General Information	5
3.0	Location	6
	PART-A	
4.0	Geology and Mineral Reserves	7
5.0	Mining	11
6.0	Blasting	16
7.0	Mine Drainage	17
8.0	Other Permanent Structures	18 .
9.0	Employment Potential & Welfare Measures	20
	PART-B	
10.0	Environment Management Plan	22
11.0	Progressive Quarry Closure Plan	29
12.0	Any Other Details Intend to Furnish by the Applicant	35





31 DEC 2021

LIST OF ANNEXURES

S. No.	Description	Annexure No.
1.	Copy of Precise Area Communication	1
2.	Copy of FMB	II
3.	Copy of Combined map	Ш
4.	Copy of Patta	IV
5.	Copy of A-Register	v
6.	Copy of Adangal	VI
7.	Copy of Consent letter from the pattadars	VII
8.	Copy of Partnership Deed	VIII
9.	Copy of Authorization Letter	IX
10.	Copy of ID Proof	X
11.	Copy of Educational Certificate of Qualified Person	XI
12.	Copy of Experience Certificate of Qualified Person	XII

LIST OF PLATES

S. No	Description	Plate No.
1.	LOCATION PLAN	1
2.	TOPOSKETCH OF QUARRY LEASE APPLIED AREA FOR 10KM RADIUS	IA
3.	ENVIRONMENTAL & LANDUSE PLAN FOR 1km RADIUS	IB
4.	ROUTE MAP	IC
5.	QUARRY LEASE & SURFACE PLAN	П
6.	TOPOGRAPHY, GEOLOGICAL PLAN YEARWISE DEVELOPMENT & PRODUCTION PLAN & SECTIONS	Ш
7.	PROGRESSIVE QUARRY CLOSURE PLAN & SECTIONS	IV
8.	CONCEPTUAL PLAN & SECTIONS	v

ட்டும்க்குந்ர் விறு

MINING PLAN ALONG WITH PROGRESSIVE QUARRY CLOSURE PLAN FOR BILICHI ROUGH STONE AND GRAVEL QUARRY

(PREPARED UNDER RULES 41 & 42 AS PER THE AMENDED UNDER TAMIL NADU MINOR MINERAL CONCESSION RULES, 1959)

1.0 INTRODUCTION AND EXECUTIVE SUMMARY

The Mining Plan and Environmental Management plan is prepared for Tvl. Sri Rajalakshmi Samappa Building Materials Company, having an office at No. 677/1A, Vellamadai, Coimbatore District, Tamil Nadu State – 641 110.

The applicant applied Rough stone and Gravel quarry over an extent of 2.60.5 Hectares of patta lands in S.F.Nos. 1120/2 and 1121/2 of Bilichi Village, Coimbatore North Taluk, Coimbatore District, Tamil Nadu State under Rules 19 (1) and 20 of Tamil Nadu Minor Mineral Concession Rules, 1959.

The application was processed by the Assistant Director, Department of Geology and Mining, Coimbatore and passed a Precise area Communication letter vide R.C.No.875/Mines/2021, Dated: 02.12.2021 to submit Draft Mining Plan for approval and obtain Environmental Clearance from the State Level Environment Impact Assessment Authority, Tamil Nadu with following conditions to provide (Please refer Annexure No – I).

- No hindrance shall be caused to the adjacent patta lands and Public while Rough Stone and Gravel quarry operation.
- 2. A safety distance of 7.5 meters should be provided to the adjacent Patta lands.
- 3. Child labour should not be engaged for any quarry works.

In order to ensure compliance of the order of the Honourable Supreme Court Dated: 27.02.2012 in I.A.No.12.13.2011 in Special Leave Petition SLP (C) No 19628-19629/2009, it has been now decided that all mining projects of minor minerals including their renewal irrespective of sizes of the lease would hence forth require prior environmental clearance mining project within the lease applied area up to less than 100Ha including projects or minor mineral with lease applied area less then 5Ha would be treated as category B as defined in the EIA notification 2006 and will be considered by the state Competent Authority notified by MoEF as prescribed procedure under EIA notification 2006.

In the above circumstances the applicant through his consultant is hereby preparing the mining plan along with Progressive Quarry Closure Plan for approval and subsequent submission of Form-I, Form-1M and Pre feasibility report to obtain environmental clearance from the State Level Environment Impact Assessment Authority, Tamil Nadu, Rough stone and Gravel quarry. This mining plan is prepared by considering the Rules 41 & 42 as Amended in Tamil Nadu Minor Mineral Concession Rules, 1959 and as per the EIA Notification 2006 and its subsequent Amendment and judgments till 24.01.2019.

Short Notes of Mining plan:

- a. Village Panchayat Bilichi
- b. Panchayat Union Periyanayakkanpalayam
- c. The Geological Resources are 9,15,950m³ of Rough stone and 51,136m³ of Gravel (35,776m³ of Gravel + 15,360m³ of existing Gravel dump) in the entire area.
- d. The Total Mineable Reserves are 3,22,380m³ of Rough stone and 40,936m³ of Gravel (25,576m³ of Gravel + 15,360m³ of existing Gravel dump) in the entire area.
- e. The proposed quantity of reserves/ (level of production) to be excavate are 2,53,220m³ of Rough stone for five years and 40,936m³ of Gravel (25,576m³ of Gravel + 15,360m³ of existing Gravel dump) for first three years in the entire area.
- Total extent of the lease applied area is about 2.60.5Ha.
- g. Topography of the area = The area is flat topography
- h. Proposed Depth of mining = 37m (2m Gravel + 35m Rough Stone) below ground level.
- i. Lease Period = Five Years
- j. It is a fresh lease applied area but, the applied area having existing pit upto 1m depth. The land owners was removed the gravel and the same has been dumped on the Southern side within the applied are due to levelling and Agriculture (Rain fed crops) purpose. The maximum dimensions of the existing pit and existing gravel dump is given table below (Refer Plate No. II and III).

Table - 1

	31	DEC 305,			
Length(m)	Width(m)	Depth(m)	Volume (m ³)		
192	80	1	15,360	1 .	

Table - 2

Exist	ting Gravel Dump	Dimension (Max	imum)
Length(m)	Width(m)	Height(m)	Volume(m ³)
64	40	6	15,360

Method of mining / level of mechanization.

Opencast mechanized method, the quarry operation involves shallow jack hammer drilling and slurry blasting.

Type of machineries proposed in the quarrying operation is given below.

Excavators attached with rock breaker (Rental Basis).

Jack hammer, Compressor (Diesel drive) (4 Jack Hammer capacity) (Rental Basis).

- m. No trees will be uprooted due to this quarry operation.
- n. The approach road from the main road to quarry area is already existence and same will be maintained in a good condition for the haulage of quarry materials.
- There is No Export of this Rough stone and Gravel.
- p. Topo sketch covering 10Km and 1Km radius around the proposed area with markings of habitations, water bodies including streams, rivers, roads, major structure like bridges, wells, archeological importance, place of worship is marked and enclosed as Plate No. IA and IB.
- q. The lease applied area is about 2.60.5Ha bounded by six corners; the corners are designated as 1-6 clock-wise from the Southwest corner and the Co-ordinates for all the corners are clearly marked in the Quarry Lease Plan and Surface Plan enclosed as Plate No. – II.

2021

- r. The plans of proposed quarrying area showing the dimensions of the pit, their proposed depth and maximum area of proposed quarrying are and marked in the Topingraphy, Geological, Yearwise Development and Production Plan and sections enclosed as Plate No. III.
- No. III.

 s. General conditions will not applicable for the proposed area. The area applied for lease
 - i) Interstate Boundary,

is 10Km away from the,

- ii) Protected area under wild life protection ACT 1972,
- iii) Critically polluted areas as identified by CPCB,
- iv) Notified Eco sensitive areas.
- There is no wastage anticipated during this quarry operation, hence waste dump is not proposed in the lease applied area.
- Around 29 employees are deploying in the quarrying operation.
- v. Total Cost of the project is about Rs.84,64,000/-.
- w. Infrastructures are bounded by the quarry lease applied area is given below table:

Table - 3

Particulars	Location	Approximate aerial distance from lease applied area.	
Nearest Post Office	Vellamadai	3km – SW	
Nearest School	Onnipalayam	1km – NE	
Nearest Dispensary	Vellamadai	3km – SW	
Nearest Hospital	Periyanayakkanpalayam	7km – SW	
Nearest Police Station	Karamadai	6km – NW	
Nearest Town	Periyanayakkanpalayam	7km – SW	
Nearest D.S.P. Office	Periyanayakkanpalayam	7km – SW	
Nearest Railway Station	Karamadai	6km – NW	
Nearest Airport	Coimbatore	20km - South	
Nearest Seaport	Kochi	160km – SW	
District Head quarters	Coimbatore	20km - South	

4

2.0 GENERAL INFORMATION

2.1 a) Name of the Applicant

Tvl. Sri Rajalakshmi Samappa Building 3 1 DEC 2021

Materials Company,

b) Address of the Applicant (With Phone No and Aadhaar No.)

.

:

Address

No. 677/1A, Vellamadai,

District

Coimbatore

Pin Code

Commonion

641 110

Mobile No

+91 99763 64777 and 86673 84540

Aadhaar No

4171 8521 8213 (Refer Annexure No. X)

Email ID

srsbc2019@gmail.com

c) Status of the Applicant (Individual / Company / Firm):

The applicant is a Partnership firm, the partnership deed executed on 22.04.2019 with four partners under the Indian Partnership act, 1932 (Refer Annexure No. VIII). Thiru.S.Gnanasekaran is an Authorized person for signing the documents on behalf of the firm (Refer Annexure No. IX and X).

2.2 a) Mineral which the Applicant intends to mine:

The Applicant intends to quarry Rough stone and Gravel.

b) Precise area communication letter details received from the Competent Authority of the Government:

The precise area communication letter was received from the Assistant Director, Department of Geology and Mining, Coimbatore vide R.C.No. 875/Mines/2021, Dated: 02.12.2021.

c) Period of permission / lease to be granted:

Five years.

d) Name and address of the Qualified Person who preparing the mining plan:

Name

P. Viswanathan, M.Sc.,

Qualified Person

Address

No.17, Advaitha Ashram Road,

Alagapuram,

Salem - 636 004.

Mobile

.....

.

+91 94422 78601 & 94433 56539

Telephone No.

0427-2431989

Email

infogeoexploration@gmail.com

(Refer Annexure No. XI and XII)


3.0 LOCATION

31 DEC 2021

a) Details of the area with location map:

The lease applied area is located about 20km Northern side of Coimbatore town and 4km Eastern side of Bilichi Village.

Location Map of the Lease Applied area

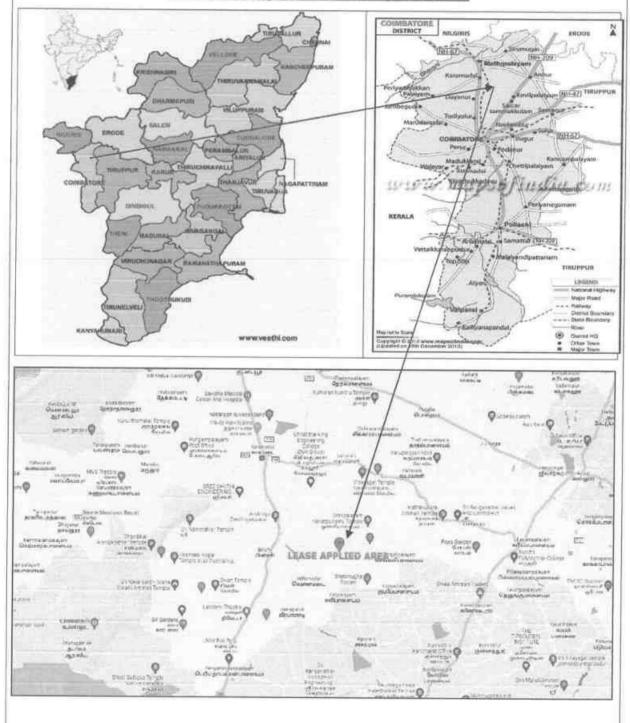

்குநர் சிலு

DEC 2021

		Table – 4			9.4
District	Taluk	Village	S.F. No.	Area in Ha.	Patta No.
			1120/2	1.52.5	
Coimbatore	Coimbatore North	Bilichi	1121/2	1.08.0	3450
			Total	2.60.5	

b) Classification of the area (Ryotwari/ Poramboke / others):

It is a Patta land (Barren land).

c) Ownership / Occupancy of the applied area (surface right):

It is a Patta land, jointly registered in the name of Thiru. P. Siddharthamouli and Thiru. G. Srikanth vide Patta No. 3450 (Refer Annexure Nos. IV to VI). The applicant company has obtained consent from the pattadars for the period of ten years from the date of execution of lease deed (Refer Annexure No. VII).

d) Toposheet No. with latitude and longitude:

The lease applied area falls in the Toposheet No: 58-A/16 Latitude between: 11°11'51.42"N to 11°12'01.24"N and Longitude between: 76°59'38.35"E to 76°59'41.55"E on WGS datum-1984. Please refer the Plate Nos. I to II.

e) Existence of public road / Railway line, if any nearby and approximate distance:

The approach road is situated on the Southeast side which is connects to the Onnipalayam - Kalipalayam Village road situated at 770m on the Eastern side of the area. Multiple road access is available from the quarry to state highways and National Highway, no towns are enrooted hence the traffic density is not much more due to the transportation of Rough stone and Gravel.

The road from the quarry area is already in existence, the same will be maintained and utilized for haulage of Rough stone and Gravel.

The Nearest Railway line is Coimbatore - Mettupalayam which is located about 3km on the Western side of the area.

PART - A

4.0 GEOLOGY AND MINERAL RESERVES

4.1 Brief description of the Topography and general Geology of the area (with plans):


The lease applied area is flat terrain. The gradient is gentle towards Northern side and altitude of the area is 426m above from Mean Sea level. The area is covered by 2m thickness of Gravel and followed by Massive Charnockite which is clearly inferred from the outcrop.

The Water level in the surrounding area is 64m in summer and at 59m in rainy seasons below general ground profile which is observed from the nearby bore wells. Average annual rainfall is about 689mm.

Images of Bilichi Rough Stone and Gravel Quarry lease applied area Fencing

Peninsular gneiss forms the oldest rock formations, in which the massive formation of Charnockite lies over with rich accumulation of recent quaternary formation. On regional scale the Charnockite body N45°E – S45°W with dipping towards SE80°.

The general geological sequences of the rocks in this area are given below:

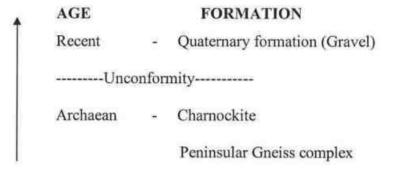

4.2 Details of exploration already carried out if any:

State Geology and Mining Deptartment, Govt. of Tamil Nadu, has carried out the Regional prospecting and exploration in these areas during 1992 to 1993.

Geological Survey of India has carried out detailed mapping in Coimbatore District.

Besides, the Qualified Person and his team members made a detailed geological study of the proposed area. The Rough stone formation is clearly inferred from the outcrop.

4.3 Estimation of Reserves:

a) Geological reserves with geological sections on a scale of 1:1000 / 1:2000

As far as Rough stone (Charnockite) is concerned, the only practical method is the systematic geological mapping and delineation of Rough stone within the field and careful evaluation of body luster, physical properties, engineering properties, commercial aspects etc.,

Totally three sections have been drawn, one section drawn vertically as (X-Y) Length wise and other two cross sections are drawn perpendicular to strike as (A-B and C-D) Width wise to cover the maximum area considered for calculation upto 37m depth.

The Topographical, Geological plan and sections demarcated the commercial marketable Rough stone (Charnockite) deposit has been prepared in the scale of 1:1000 (please refer the Geological plan and sections Plate No- III). As the sale of Rough stone are in terms of cubic metres (Volume) only and not in terms of tonnage.

Geological Resources (Plate No. III):

31 DEC 2021

The Geological Resources of Rough Stone and Gravel Quarry are calculated upto a maximum depth of 37m (2m Gravel + 35m Rough Stone) below from the general ground level. The total available geological resources are given below (Refer Plate No. III).

Table - 5

Section	Bench	Length (m)	Width (m)	Depth (m)	Geological Resources of Rough stone in (m ³)100%	Gravel (m³)
	I	202	8	1	(6)	1616
	I	202	90	1	-	18180
	II	202	90	5	90900	
	III	202	90	5	90900	38
	IV	202	90	5	90900	-
XY-AB	V	202	90	5	90900	
	VI	202	90	5	90900	145
	VII	202	90	5	90900	-
	VIII	202	90	5	90900	: (
			636300	19796		
	Dump	64	40	6	-	15360
	I	94	85	2		15980
	II	94	85	5	39950	
	III	94	85	5	39950	(=)
	IV	94	85	5	39950	•
XY-CD	V	94	85	5	39950	3 €0
	VI	94	85	5	39950	40
	VII	94	85	5	39950	•
	VIII	94	85	5	39950	140
		7	Total		279650	31340
		Grand To	otal		915950	51136

The Available Geological Resources and Existing dump of Gravel :

51,136m³

The Available Geological Resources of Rough Stone

9,15,950m³

Mineable Reserves:

The mineable reserves are calculated after leaving the safety distance and Benchadss. DEC 2021

Table - 6

Section	Bench	Length (m)	Width (m)	Depth (m)	Mineable Reserves of Rough stone in (m³)100%	Gravel (m³)
	I	192	73	1	-	14016
	II	190	68	5	64600	2
	Ш	185	58	5	53650	
	IV	180	48	5	43200	
XY-AB	V	175	38	5	33250	
	VI	170	28	5	23800	-
	VII	165	18	5	14850	T.
	VIII	160	8	5	6400	14
		To	tal	239750	14016	
	Dump	64	40	6		15360
	I	85	68	2	17	11560
	II	83	62	5	25730	H
	III	78	52	5	20280	-
XY-CD	IV	73	42	5	15330	L.
	V	68	32	5	10880	i.e.
	VI	63	22	5	6930	-
	VII	58	12	5	3480	225
		Tot	al		82630	26920
	G	rand Tota	l		322380	40936

Total Mineable Recoverable Reserves of Rough stone @ 100%

3,22,380m3

Total Mineable Reserves of Gravel and existing dump

40,936m³

The mineable reserves have been computed as 3,22,380m³ of Rough stone at the rate of 100% recovery and 40,936m³ of Gravel upto a depth of 37m (2m Gravel + 35m Rough Stone) below from the general ground level for a period of five years.

5.0 MINING

5.1. Method of mining (opencast / underground):

Open cast Mechanized Mining is being carried out with 5.0 meter vertical bench with a bench width is not less than the bench height.

However, as far as the quarrying of Rough stone is concerned, observance of the provisions of Regulation 106 (2) (b) as above is seldom possible due to various inherent petro genetic factors coupled with mining difficulties. Hence it is proposed to obtain relaxation to the provisions of the above regulation from the Director of Mines Safety for which necessary provision is available with the Regulation 106 (2) (b) of MMR-1961, under Mine Act - 1952.

5.2. Mode of working (mechanized, semi mechanized, manual):

1 DEC 2021

The Rough Stone is proposed to quarry at 5m bench height & width with conventional Opencast Mechanized Method.

The quarry operation involves shallow jack hammer drilling, slurry explosives in blasting, excavation, Loading and transportation of Rough stone to the needy crusher.

The production of Rough stone in this quarry involves the following method which is typical for Rough Stone quarrying in contrast to other major mineral mining.

Splitting of rock mass of considerable volume from the parent rock mass by jackhammer drilling and slurry explosives blasting, hydraulic excavators are used for loading the Rough Stone from pithead to the needy crushers.

Occasionally hydraulic excavators are attached with rock breakers for fragmentation to avoid secondary blasting. The primary boulders thus splitted are removed from the pits by excavators and further made to smaller sizes by rock breakers attached in excavators. It is a conventional opencast mechanized method of mining.

5.3. Proposed Bench Height and Width:

The bench height is proposed 5.0 meter in Rough stone as vertical bench and 3m in Gravel with 45° slope the width of the bench is not less than the Height.

5.4. Indicate the overburden / mineral production expected pit wise as detailed below (composite plan and section showing pit layout, dumps, disposal of waste if any etc.):

The overburden is Gravel formation. The Gravel will be directly loaded into tippers for the filling and levelling of low lying areas, this will be done only after obtaining permission and paying necessary seigniorage fee to the Government. The excavated rough stone will be directly loaded into tippers to the needy customers. The Composite year wise Development and production plan and sections indicating the Pit lay out, Green belt development are shown in Plate No-III.

		Year	wise De	velopme Tal	nt and l ble – 7	Production Table	DEC 2
Section	Year	Bench	Length (m)	Width (m)		Recoverable Reserves of Rough stone in (m ³)100%	Grave (m ³)
		I	192	73	1	<u> </u>	14016
XY-AB	1	II	138	68	5	46920	-
A1-AD		III	12	58	5	3480	ĕ
			Tota	al		50400	14016
XY-CD		DUMP	64	40	6	-	15360
	П	III	116	58	5	33640	H
	11	IV	70	48	5	16800	#1
XY-AB			Tota	al		50440	15360
		III	5	58	5	1450	-
		IV	58	48	5	13920	le le
		Ī	85	68	2	12	11560
	ш	II	50	62	5	15500	-
		III	45	52	5	11700	-
		IV	40	42	5	8400	-
		Total				50970	11560
XY-CD		П	33	62	5	10230	36
		III	33	52	5	8580	
		IV	33	42	5	6930	250
		V	68	32	5	10880	Tys.
	IV	VI	63	22	5	6930	
		VII	58	12	5	3480	72
		V	15	38	5	2850	- 2
		VI	10	28	5	1400	
			Tota	ıl		51280	
XY-AB		V	108	38	5	20520	199
AI-AB		VI	108	28	5	15120	870
	V	VII	113	18	5	10170	
		VIII	108	8	5	4320	
			Tota	ıl		50130	
		Grand	Total			253220	40936

Total proposed Reserves of Rough stone @ 100% : 2,53,220m³

Total proposed Reserves of Gravel & Existing gravel dump : 40,936m³

The Recoverable reserves have been computed as 2,53,220m³ of Rough stone at the rate of 100% recovery for the period of five years and 40,936m³ of Gravel for a period of first three years upto a depth of 37m (2m Gravel + 35m Rough Stone) below ground level.

The applicant ensures the total quantity proposed in the benches will not exceed during the quarrying operation. Besides the rough stone locked up in benches will be exploited after obtaining necessary permission from the office of Director General of Mine Safety, Chennai region by submitting relevant documents, appropriate safety plans and its Mitigation measures.

and and a	Louis Italia	aga stone and shaver spanish
One lorry load	-	6m³ (approx.)
Total No of Working days	=	300 Days per y al DEC 2021
Total Rough Stone to be removed during plan period		2,53,220m ³
Hence total Lorry loads per day	1	2,53,220m ³ /6m ³
	i=i	42,203 Lorry loads
	===	42,203/5 years
		8,441/300 days
Rough Stone	=	28 Lorry loads per day
Total gravel to be removed during first three years	=	40,936m ³
Hence total Lorry loads per day	=	40,936m ³ /6m ³
	=	6,823 Lorry loads
	=	6,823/3 years
	=	2,274/300 days
Gravel load per day	=	8 Lorry load per day
Working hours = 8.45 am to 5.45 nm (with	h 12 45-1 45	P.M. lunch break)

Working hours = 8.45 am to 5.45 pm (with 12.45-1.45 P.M. lunch break)

5.5. Machineries to be used:

For Mining:

The following machineries are utilized on rental basis for the development and production work at this quarry.

Table - 8

I. DRILLING MACHINE

S.No.	Type	Nos	Dia Hole mm	Size Capacity	Motive power
1	Jack hammer	6	30-35	1.2m to 2.0m	Compressed air
2	Compressor	2	-	400 psi	Diesel Drive

II. EXCAVATION & LOADING EQUIPMENT:

S.No.	Туре	Nos	Capacity	Motive Power
1	Excavator with Bucket and Rock Breaker	2	300	Diesel Drive

III. HAULAGE WITHIN THE MINE & TRANSPORT EQUIPMENT:

S.No.	Type	Nos	Capacity	Motive Power
1	Tippers	4	20 tonnes	Diesel Drive

5.6. Disposal of Overburden/Waste:

The overburden in the form of Gravel, the Gravel will be directly loaded and the tippers for the filling and levelling of low lying areas. The excavated Rough stone (100%) will be directly loaded into tippers to the needy customers. There is no Waste anticipated during this plan period hence, disposal of overburden/waste does not arise.

5.7. Brief note on conceptual mining plan for the entire lease period base on the geological, mining and environmental considerations:

Conceptual mining plan is prepared with an object of long term systematic development of benches, layouts, selection of permanent structures, depth of quarrying and ultimate pit dimensions, selection of sites for construction of infrastructure, etc.,

The ultimate pit size is designed based on certain practical parameters such as economical depth of mining, safety zones, permissible area, etc.,

As the applicant has applied quarry lease for Five years, the ultimate pit limit (dimension) at the end of this mining plan period is given below:

Length	Table - Width	
(Max) (m)	(Max) (m)	Depth (Max) (m)
280	83	37m Below ground level

Greenbelt has proposed on the safety zone and Panchayat roads by planting Neem, Pongamia pinnata, Casuarina, etc., trees of native species. All the base line information studies like Air quality monitoring, Noise and vibration monitoring, Water analysis studies will be carried out every year as per the MoEF&CC Norms. Please refer Plate No. III & IV.

It is propose to engage any local institution to monitor the EIA and EMP during the course of quarrying operation after the grant of quarry lease.

There is no waste anticipated during the entire life of quarry. Hence, backfilling is not possible in this quarry. After completion of quarry operation, the quarried out pit will be utilized for collect the seepage rainwater and the water storage will be kept as reservoir for charging the nearby wells also utilized for green belt development. The quarry area already fenced with barbed wire fencing, safety bund will be constructed around the quarry to prevent inadvertent entry of public and cattle (Refer plate no. IV).

6.0 BLASTING

6.1 Blasting pattern:

31 DEC 2021

The quarrying operation is proposed to carried out by Mechanized Opencast Method in conjunction with conventional method of mining using Jack hammer drilling and blasting of shattering effect for loosen the Rough stone.

Drilling and blasting parameters are as follows:

Depth of Each hole : 1.5m

Diameter of hole : 30-32mm

Spacing between holes : 1.2m

Burden for hole : 1.0m


Pattern of hole : Zigzag - Multi-rows

Inclination of holes : 80° from horizontal

Use of delay detonators : 25millisecond relays

Detonating fuse : "Detonating" Cord

BLASTING PATTERN DRAWING

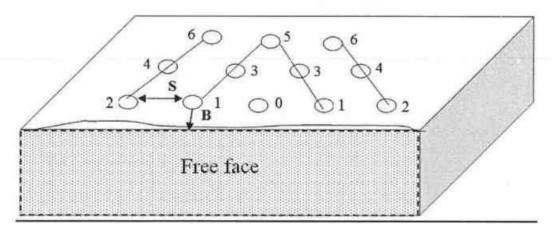

Staggered "V" Pattern of Blasting Design

Spacing = 1.2m

Burden = 1.0m

Depth of the hole = 1.5m

No of holes proposed per day = 146 Holes

6.2 Type of explosives to be used:

Small Dia. 25mm Slurry explosives are proposed to be used for shattering and heaving effect for removal and winning of Rough stone. No deep hole drilling or secondary blasting is proposed.

Measures proposed to minimize ground vibration due to blasting: 6.3

The quarry is situated more than 300m from the nearby villages, Controlled blasting measures is being adopt for minimizing ground vibration and fly rock.

Shallow depths jackhammer drilling & blasting is proposed to be carried out with minimum use of explosive mainly to give hearing effect in rough stone for easy excavation and to control fly rock.

Delay detonators:

Delay blasting (millisecond delays) permits to divide the shot in to smaller charges, which are detonated in a predetermined millisecond sequence at specific time intervals.

The major advantages of delay blasting are:

- Reduction of ground vibration.
- Reduction in air blast.
- Reduction in over break.
- Improved fragmentation.
- Better control of fly-rock.

Blasting program for the production per day:

No of Holes = 146 Holes

Yield = 438 Tons

Powder factor = 6 Tons/Kg of explosives

Total explosive required = 73 Kg-Slurry explosives

Charge/hole = 0.5 Kg

= 12.30 - 1.00p.m (whenever required) Blasting at day time only

Storage and safety measures to be taken while blasting: 6.4

The applicant will engage authorized explosive agency to carry out the small amount of blasting and it will be supervised by competent and statutory foreman/Permit Mines Manager. The explosives agencies should be have the valid Blaster certificate. He will blast holes in the quarry site. After the completion of Blasting the explosives Agencies will take it out back the remaining quantity of Explosives. The magazine is available at the quarry site to temporarily store the explosives.

7.0 MINE DRAINAGE

7.1 Depth of water table (based on nearby wells and water bodies):

The water table in the area is about 64m BGL in summer season and 59m in Rainy season which is observed from the nearby bore well the data obtained from existing private boreholes. The lease applied area is fully covered by Massive Charnockite formation and it is revealed from the outcrop. Hence the Ground Water problem will not arise. If water seepage may occur due to the fracture, the same will be used for Greenbelt.

	<u>Table - 10</u>		a 4 pro 2004
Туре	Distance & Direction	Location	31 DEC 2021
Bore Well	200m – Northeast side	11°12'05.56"N 76°59'46.39"E	

7.2 Arrangements and places where the mine water is finally proposed to be discharged:

The quarry operations are confined to well above the water table during the entire lease period. If water is encountered at quarry due to rain water and seepage, the same will be pumped out by 5HP water pump and discharge to the Green belt development areas. Besides, the water will also be used for dust suppression on haul roads during mineral transportation.

8.0 OTHER PERMANENT STRUCTURES (also shown in the map)

8.1 Habitations/ Villages natham:

There is no approved habitation within 300m radius from the lease applied area.

8.2 Power Lines (HT/LT):

There is no EB(LT/HT) line or Housing area situated within 50m radius of the area.

8.3 Water bodies (river, pond, lake, odai, canal, etc.,):

There is no River, Pond, Lake, Canal, Reservoir located within 50m radius of the area.

8.4 Archaeological / historical monuments:

There is no Archaeological / historical monument within 500m radius of the area.

8.5 Road (NH, SH others):

The Nearest National Highway (NH - 181) Coimbatore – Mettupalayam is situated about 3km on the Western side of the lease applied area.

The State Highway (SH-168) Karamadai – Kariampalayam Road is about 4km on the Northern side of the applied area.

8.6 Places of worships:

There is no place of worships within the radius of 500m from the lease applied area.

8.7 Reserved forest / forest / social forest / wild life sanctuary etc.:

There is no reserved forest / social forest / wild life sanctuary etc., situated within 1km radius of the lease applied area.



SALIENT FEATURES

Table - 11

3 1 DEC 2021

S. No.	Salient Features Present around the site	Prescribe d safety distance			nin Prescribed of direction from		
1.	Railways, Highways, Reservoirs or Canal	50m	None of the above situated within 50m radius.				
2.	Village Road	10m	There is no village Road located within 10m Radius of the area.				
3.	Habitation / Village	300m	There is no approved habitation located with 300m radius of the lease applied area (Refer Pl. No I-B).				
4.	Adjacent Patta/Govt. Land	7.5m/10 m	Direction	. Sections are	Classification	Safety Distance	
			North	1121/1	Patta land	7.5m	
			East	1120/3 and 1121/3	Patta land	7.5m	
			South	Vellamadai village	Patta land	7.5m	
			West	1120/1 and 1121/1	Patta land	7.5m	
			(Refer Plate No. II).				
5.	Power House, EB line (HT & LT Line)	50m			IT) line or Houdius of the area.		
6.	Boundaries of the permitted area	7.5m	follows: North - East - South - West -	- S.F.No. 1121 - S.F.Nos. 112 - S.F.No. Vella	permitted areas /1 0/3 and 1121/3 amadai Village 0/1 and 1121/1.	as	
7.	Reserve forest	1km	There is no reserved forest located within the radius of 1km from the lease applied area.				
8.	Protected area / ECO sensitive area/ Wild Life Sanctuary/ Interstate Border	10km	There is Sanctuar	s no ECO se y/ Interstate E ACA/ CRZ lo	ensitive Zone/ Norder/ Critically cated within 10	Wild Life y Polluted	

9.0 EMPLOYMENT POTENTIAL & WELFARE MEASURES

31 DEC 2021

9.1 Employment potential (skilled, semi-skilled, un skilled):

The following manpower's are proposed in the mining plan to carry out the day-to-day quarrying activities, the same employment is maintaining aimed at the proposed production target and also to comply with the statutory provisions of the Metalliferous mines regulations, 1961.

a. Mine official & Competent Persons

Mines Manager/Mines Foreman : 1
Mate/Blaster : 1

b. Machinery Operators

c.

Jack hammer operator : 12
Excavator Operator : 2
Tipper Driver : 4
Ordinary Employee

Helper : 2
Cleaner & Co-Operator : 6
Security : 1
Total : 29

The above manpower is adequate to meet out the production schedule and the machinery strength envisaged in the mining plan and to comply with the statutory provisions of the Mines Safety Regulations. It is been ensured that the labour will not be employed less than 18 years, No

child labour will engaged or entertained for any kind of quarrying operations. All the labours engaged for quarrying operations will be insured during the quarry lease period.


9.2 Welfare Measures:

a) Drinking Water:

Packaged drinking water is available from the nearby water vendors in Pariyanayakkanpalayam town which is located about 7km on the Southwest side of the lease applied area.

b) Sanitary Facilities:

Hygienic modern Sanitary Facilities will be constructed as semi permanent structure and it will be maintained periodically as hygienic.

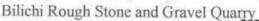

c) First aid facility:


3 1 DEC 2021

First aid kits are kept in Mines office room, in case of such eventuality is the victim will be given first aid immediately at the site by the competent and statutory permit manager/mate will be in charge of first aid and injured person will be taken to the hospital by the applicant's vehicle. Hospital is available in Pariyanayakkanpalayam town which is located about 7km on the Southwest side.

d) Labour Health:

Periodically medical check-up related to occupational health safety will be conducted to all the workers in applicant own cost.

e) Precautionary safety measures to the labourers:

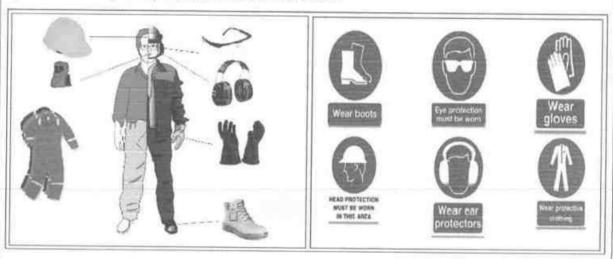

- > Helmets.
- Mine Goggles,
- Ear plugs,
- Ear muffs,
- Dust mask,
- Reflector jackets
- Safety Shoes

All personnel protective devices will be provided as per the specification approved by Director of mines safety. Periodically medical check-up will be conducted for all workers for any mine health related problems. Proper training and vocational education will be given by qualified and experienced safety officer to all the employees about the safety and systematic Rough stone quarrying operations. The workers will be sent for vocational training periodically, to carry out the quarrying operations scientifically and to safe guard the workers and to create awareness about conventional opencast quarrying operations.

PART - B

10.0 ENVIRONMENT MANAGEMENT PLAN

3 1 DEC 2021

10.1 Existing Land use pattern:

The quarry lease applied area is flat terrain. The area is a dry barren land devoid of Agriculture and Habitations. The lease applied area has utilized for Sorghum and Pearl millet (Rain fed) crops purpose in earlier.

Land Use Pattern Table – 12

Description	Present area in (ha)	Area utilized (%		
Area under quarry	1.46.5	56.2		
Dump	0.25.6	9.8		
Infrastructure	Nil			
Roads	0.02.0	0.8		
Green Belt	Nil	*		
Unutilized	0.86.4	33.2		
Grand Total	3.62.0	100		

10.2 Water Regime:

It is a simple opencast quarry operation. The quality of water will not be affected due to this quarrying operation. However, mitigation measures will be carried out like Garland drains constructed on all sides of quarry pit to avoid surface run-off rain water entering into the pit.

The waste water discharged to water bodies will be met the standard prescribed under the Environment (Protection) Act – 1986 by The Ministry of Environment, Forest and Climate change.

Bilichi Rough Stone and Gravel Quarry

10.3 Flora and Fauna:

3 1 DEC 2021

		Та	ble – 13		3 . 500 -
S.No	Name of the plant (Scientific)	Family Name	Common Name	Habit	Picture
1.	Prosopis juliflora	Fabaceae	Seemai karuvelam	Tree	
2.	Azadirachta indica	Meliaceae	Neem, Vembu	Tree	
3.	Cocos nucifera	Arecaceae	Thennai	Tree	
4.	Opuntia ficus-indica Cactaceae		Cactus, kalli	Shrub	
5.	Borassus flabellifer	Arecaceae	Panai	Tree	-
6.	Eucalyptus obliqua	Myrtaceae	Eucalyptus, Thailamaram	Tree	
7.	Sorghum bicolor	Poaceae	Solam	Crop	TO THE
8.	Cenchrus americanus	Poaceae	Kambu, Pearl/Grain Millet	Crop	

	*	List of Fauna	
S.No.	Scientific Name	Common Name	Picture
1.	Capra aegagrus hircus	Goat	A
2.	Funambulus palmarum	Squirrel	3
3.	Bos taurus	Cow	
4.	Danaus plexipppus	Striped tiger	M
5.	Corvus levaillantii	Crow	'se
6.	Indian cobra	Snake	

10.4 Climatic Conditions:

The area receives rainfall of about 689mm/annum and the rainy season is mainly from Oct - Dec during monsoon. The summer is hot with maximum temperature of 42°C and winter encounters a minimum temperature of 21°C.

10.5 Human settlement:

There are few villages located within 5km radius of the area; the approximate distance, direction and populations are given below:

Table - 14

S. No Name of the Village		Approximate distance & Direction from lease applied area	Approximate population	
1,	Bilichi	4km – West	10,500	
2.	Onnipalayam	1km – NE	1,200	
3.	Vellamadai	3km – SW	7,000	
4.	Sengalipalayam	3km – East	1,000	

Basic human welfare Amenities such as Health Centre, Schools, Communication Facilities, and Commercial Centres etc., are available at Periyanayakkanpalayam located at a distance of 7km on the Southwest side of the area.

10.6 Plan for air, dust suppression:

The air quality will be affected by the Suspended Particulate Matter (SPM) generated by the blasting, jack hammer drilling, Loading and unloading during the Rough stone quarry operation.

The following Mitigations measures will be carried out:

- Mist Water spraying will be carried out by means of water sprinklers to suppress the dust emission in the Haul roads.
- Vegetations will be formed on the non quarrying area.
- Avoiding spillages during the transportation.

Air quality will be monitored periodically as per Norms and Mitigate measures carried out to prevent dust and Air propagation in to air. The estimated budget for dust suppression would be around Rs.52,000/year.

10.7 Plan for Noise level control:

The noise level increased due to the Excavation, Drilling, Blasting and Transport for 2021

Engineering Noise control:

Noise will be created due to the usage of Machineries and Vehicles. The Noise will be controlled in the following manner.

- Selection of new low noise equipments for the Rough stone quarry operation.
- Modifications of older equipments.
- Implementation of effective preventive maintenance which reduces noise more than 50%.
- Developing Green belts which act as Acoustic barrier, pollution absorbent and noise controller.
- The drivers will be strictly instructed to move the vehicle during the transportation not exceed 40km per hour.
- Sentries with flags & whistle will posted in village road junction and populated area to control and regulate traffic.

Shallow holes of 32mm diameter and maximum depth of 1.5m will be drilled and conventional low power explosives such as Slurry Explosives, ordinary safety fuse will be used for rough stone. Hence, ground vibration and noise pollution i.e., minimal and restricted within the quarry working area.

Noise level monitoring and other Mitigation measures will be carried out to reduce Noise and Vibration. The estimated budget for Noise level monitoring would be around Rs.2,000/Year.

10.8 Environmental impact assessment statement describing impact of mining on the next five years:

In the mining plan proposed for a production of Rough stone does not involve deep hole drilling and heavy blasting. Such limited mining activity is not likely to cause any impact adversely on the environment. As far as pollution of air, water and noise concerned, the environmental impact studies will be conducted as per EIA notification issued by MoEF& CC. It is B2 Category mine. The estimated budget would be around Rs.3,80,000/-.

10.9 Proposal for waste management:

There is no waste anticipated in this Rough stone and Gravel quarrying operation. The entire quarried out materials will be utilized (100%).

10.10 Proposal for reclamation of land affected during mining activities and at the end of mining (refilling / fencing etc.):

In the mining plan only to a maximum depth of 37m [2m Gravel + 35m Rough stone] has been envisaged as workable depth for safe & economic quarry operation during entire lease period. The quarry area fenced with Barbed wire fencing also safety bund will be constructed around the quarry to prevent inadvertent entry of public and cattle. There is no waste hence, no proposal for backfilling. The barbed wire fencing cost would be around Rs. 2,25,000/-.

10.11 Programme of Greenbelt development (indicate extend, number, name of species to be afforested):

The safety zone along the Western side boundary barrier has been identified to be utilized for Greenbelt development. Appropriate native species of Neem, Pongamia pinnata, Casuarina, etc., trees will be planted in a phased manner as described below.

Table - 15

Year	No. of tress proposed to be planted	Survival %	Area to be covered sq.m.	Name of the species	No. of trees expected to be grown
1	40	80%	320		32
П	40	80%	320	Neem, Pongamia	32
Ш	40	80%	320	pinnata, Casuarina,	32
IV	40	80%	320	etc.,	32
V	40	80%	320	33391	32

Nearly 1,600m² area is proposed to use under Greenbelt by planting 200 Numbers of trees during mining plan period with an anticipated survival rate of 80% (Please refer Plate No.III). The estimated budget for plantation and maintenance of Green belt development would be around Rs. 20,000/- for the period of five years.

The Greenbelt Development will be formed along the quarried out top bench and approach. The cost would be around Rs. 30,000/-

10.12 Proposed financial estimate / budget for (EMP) environment management:

Budget Provision for the Mining Plan period:

Table - 16

S. No	Monitory and Analysis Description	Rate per location	No. of location	Total Charges/ six months	Total Charges/ year
1	Ambient air quality monitoring	6500	4	26000	52000
2	Noise level monitoring	250	4	1000	2000
3	Ground vibration monitoring	1000	2	2000	4000
4	Water sampling and analysis	9000	1	9000	18000
	Total	EMP Cost/	year		76,000

The EMP cost would be around Rs. 3,80,000/- for the period of five years.

077	ost / investment	31 DEC 2
i) Land cost	The Land value as per the Government Guideline land cost is calculated as follows. Total Extent = 2.60.5Ha Cost per Hectare = Rs. 14,90,500/- 2.60.5 x 14,90,500/- = Rs. 38,82,753/- (source: https://tnreginet.gov.in/portal/)	Rs.38,83,000
ii) Machinery to be used	The following machineries are proposed to meet out the productions. Excavator attached with rock breaker Tipper, Tractor mounted compressor with Jack Hammer and loose tools (Rental Basis)	Rs.30,00,000
iii) Refilling/ Fencing	Fencing will be constructed around the quarry pit to prevent the inadvertent entry of public and cattle cost would be around	Rs.2,25,000/-
iv) Labourers shed	Labour sheds constructed as semi permanent structure. The cost is around	Rs. 2,00,000/-
v) Sanitary facility	Adequate latrine and urinal accommodation has provided at conveniently accessible places the cost would be around	Rs. 80,000/-
vi) Others items	First aid room & accessories	Rs. 40,000/-
vii) Drinking water facility for the labourers	Packaged drinking water will be provided for all the Labours. Drinking water will be readily available at conveniently accessible points during the whole of the working shift the cost would be around	Rs.1,00,000/-
viii) Sanitary arrangement	The latrine and urinal will keep clean and sanitary condition. The maintenance cost would be around	Rs. 50,000/-
ix) Safety kit	All the Safety kit such as Helmet, Earmuffs, Goggles, Reflector Jackets, Safety shoes etc., will be provided to the workers by the applicant own cost which would be around	Rs.40,000/-
x) Water sprinkling	Water will be sprinkled in the haul roads by water sprinklers the cost would be around	Rs.1,00,000/-
xi) Garland drain	Construction of Garland drain with check dam to prevent surface run-off rain water in to the quarry pit, the construction cost is around	Rs. 1,50,000/-
xii) Greenbelt etc.	Greenbelt development and maintenance will be carried out in the boundary barriers the cost would be around	Rs.20,000/-
	Greenbelt development and maintenance will be carried out in the quarried out top bench and approach Road	Rs.30,000/-
	Total Project Cost	Rs.79,18,000/-

B. EMP Cost :- (Per year)

Air Quality monitoring = Rs. 52,000/- 11 DEC 2021

Water Quality Sampling = Rs. 18,000/-

Noise Monitoring = Rs. 2,000/-

Ground vibration test = Rs. 4,000/-

Total Cost = Rs. 76,000/-

Total EMP Cost for the five years period is Rs. 3,80,000/-

A+B =

A. Project cost = Rs. 79,18,000/-

B. EMP Cost = Rs. 3.80,000/-

Total Project Cost (A+B) = Rs. 82,98,000/-

The applicant Indents to involve corporate Environment responsibilities (CER) activity like Water purifier Cot and Bed facility to the Palathurai Dispensary at 2.0% from the total project cost, the cost would be around Rs.1,66,000/-

Total Project cost = Rs. 82,98,000/-

CER Cost (2%) = Rs. 1,66,000/-

Total cost = Rs. 84,64,000/-

(The Total cost of the project including EMP Cost is Rupees eighty four lakh and sixty four thousand only).

11.0 PROGRESSIVE QUARRY CLOSURE PLAN

11.1 Introduction:

31 DEC 2021

The Progressive Quarry Closure Plan for Rough stone and Gravel quarry lease applied area over an extent of 2.60.5 Hectares of patta lands in S.F.Nos. 1120/2 & 1121/2 of Bilichi Village, Coimbatore North Taluk, Coimbatore District, Tamil Nadu State has been prepared for Tvl. Sri Rajalakshmi Samappa Building Materials Company, having an office at No. 677/1A, Vellamadai, Coimbatore District, Tamil Nadu State – 641 110.

11.2 Present Land use pattern:

Land Use Table - 17

Description	Present area in (ha)		
Quarrying Pit	1.46.5		
Dump	0.25.6		
Infrastructure	Nil		
Roads	0.02.0		
Green Belt	Nil		
Unutilized Area	0.86.4		
Grand Total	2.60.5		

11.3 Method of Mining:

Open cast Mechanized Mining is being carried out with 5.0 meter vertical bench with a bench width is not less than the bench height for Rough stone.

However, as far as the quarrying of Rough stone is concerned, observance of the provisions of Regulation 106 (2) (b) as above is seldom possible due to various inherent petro genetic factors coupled with mining difficulties. Hence it is proposed to obtain relaxation to the provisions of the above regulation from the Director of Mines Safety for which necessary provision is available with the Regulation 106 (2) (b) of MMR-1961, under Mine Act – 1952.

11.4 Mineral Processing Operations:

The quarried out Rough stone will be transported by the 10/20tons capacity Tippers to the needy Customer. Splitting of rock mass of considerable volume from the parent rock mass by jackhammer drilling, mild blasting and loading the Rough Stone by manually from pithead to the needy customers. Hence, no mineral processing involved within the area.

11.5 Reasons for closure:

As the mineral is not going to be exhausted during the proposed plan period no immediate closure is planned due to sufficient reserves are available to carry on the activities. Hence, the reason for closure will be discussed in the ensuing mining plan.

11.6 Statutory obligations:

The applicant ensures to comply all the conditions were imposed before grant of quarry lease or before execution of lease deed and same will be maintained during the course of quarry operations.

11.7 Progressive quarry closure plan preparation:

Name and address of the Qualified Person who prepared the progressive closure plan and name and address of the executing agency who is involved in the Preparation of progressive quarry closure plan.

P. VISWANATHAN, M.Sc.,

Qualified Person

New No.17,

Advaitha Ashram Road.

Alagapuram, Salem-636 004.

Cell: 94433 56539, 94422 78601

The applicant will himself implement the closure plan; no outside agency will be involved.

Review of Implementation of Mining Plan including Progressive Closure Plan upto the Final Closure Plan:

The lease applied area having enormous potential of Rough stone and Gravel. The Rough stone mineral reserves are available for the entire life of quarry. The entire quarry area is an active. Hence, progressive quarry closure does not proposed at present. However, if any work done for progressive quarry closure plan during this plan period, it will be discuss in the next mining plan.

11.9 Closure Plan:

Mined Out Land: (i)

At the end of mining plan period, about 2.55.5Ha of area will be quarried out. Land use at various stages is given in the table below.

Land Use Table – 18

Description	Present area in (ha)	Area at the end of Lease period (ha)		
Quarrying Pit	1.46.5	2.12.0		
Dump	0.25.6	Nil		
Infrastructure	Nil	0.01.0		
Roads	0.02.0	0.02.0		
Green Belt	Nil	0.16.0		
Unutilized Area	0.86.4	0.29.5		
Grand Total	2.60.5	2.60.5		

(ii) Water quality management:

31 DEC 202

Following control measures will be adopted for controlling water pollution:-

- Construction of Garland drain with check dams / gully plugs at strategic places to arrest silt wash off from broken up area.
- Collection of surface run-off from broken up area in mine pits for settling and only
 properly settled excess water from mine pit will be discharged to nearby users. The
 storm water/ mine water will be used for dust suppression, greenbelt development, etc.
- Periodic analysis of mine pit water and ground water quality in nearby villages.
- The quarried out pit will be allowed to collect rain and seepage water which will act as
 a reservoir for storage. This water storage will enhance the static level and ground water
 recharge of nearby wells and it will be used for agriculture purpose to the nearby
 agriculture lands.
- Domestic sewage from site office & urinals/latrines provided in QL is discharged in septic tank followed by soak pits.

(iii) Air Quality Management:

The proposed mining method is not likely to produce much of dust and fugitive emissions to cause damage to ambient air quality of the area. Workers will be provided with personnel protective equipment like face-mask, earplug/ muffs.

For air pollution management at the progressive quarry closure plan, greenbelt will be developed to prevent and control air pollution.

(iv) Top Soil and Waste Management:

There is no topsoil and waste generated during the proposed plan period. The entire quarried out Rough stone and Gravel will be utilized (100%). Hence, waste management does not arise.

(v) Disposal of mining machinery:

All the Machineries will be engaged on rental basis. Hence, disposal or decommissioning of mining machinery does not arise.

(vi) Safety & Security:

31 DEC 202

Safety measures will be implemented to prevent access in the excavation area an unauthorized persons as per Mine Act 1952, MMR 1961.

- Safety measures will be implemented as per Mine Act 1952, MMR 1961, and Mines Rules 1955.
- Provisions of MMR 1961 shall be strictly followed and all roads shall be wider than the height of the bench or equal to the height of the bench and have a gradient of not more than 1 in 16.
- The bench height will be 5.0m.
- Width of working bench will be kept about 5.0 m for ease of operations and provide sufficient room for the movement of equipments.
- Protective equipment like dust masks, ear-plugs/ muffs and other equipments shall be provided for use by the work persons.
- Notices giving warning to prevent inadvertent entry of persons shall be displayed at all conspicuous places and in particular near mine entries.
- Danger signs shall be displayed near the excavations and proper signal by siren alarm will be given to the public before blasting time to prevent accident.
- > Security guards will be posted.
- > In the event of temporary closer, approaches will be fenced off and notice displayed.

(vii) Disaster Management and Risk Assessment:

This should deal with action plan for high risk accidents like landslides, subsidence, flood, fire, seismic activities, tailing dam failures etc. and emergency plan proposed for quick evacuation, ameliorative measures to be taken etc. The capability of applicant to meet such eventualities and the assistance to be required from the local authorities should be described.

- The complete quarry operation will be carried out under the Management and control of experienced and qualified Mines Manager having Certificate of Competency to manage the mines granted by DGMS.
- All the provisions of Mines Act 1952, MMR 1961 and Mines Rules 1955, TNMMCR 1959 and other laws applicable to mine will be strictly complied with.
- During heavy rainfall the mining activities will be suspended.
- All persons in supervisory capacity will be provided with proper communication facilities.
- > Competent persons will be provided FIRST AID kits which they will always carry.
- The quarried out benches, Greenbelt Development will be formed in all around the benches of the lease applied area.

(viii) Care and Maintenance during Temporary Discontinuance:

In case of any temporary discontinuance due to court order or due to statutory requirement or any other unforeseen circumstance following measures shall be taken for care, maintenance and monitoring of conditions.

- Notice of temporary discontinuance of work in mine shall be given to the DGMS as per the MMR 1961.
- All the mining machinery shall be shifted to a safe place.
- Entrance to the mine or part of the mine, to be discontinued shall be fenced off. Fencing shall be as per the circular 11/1959 from DGMS.
- Security Guards shall be posted for the safety and to prevent any unauthorized entry to the area.
- Carry out regular maintenance of the facilities/area detailed below in such a way as would have been done as if the mines were operation:

Mine roads and approach roads,

Fencing on approach roads,

Checking and maintenance of machines and equipment,

Drinking water arrangements,


Mine office, first aid stations etc.

- Competent persons shall inspect the area regularly.
- Air, water and other environmental monitoring shall be carried out as per CPCB and IBM Guideline.
- Care and upkeep of plantation shall be carried out on regular basis.
- Status of the working and status monitoring for re-opening of the mines shall be discussed daily.

In case of discontinuance due to any natural calamities/abnormal conditions, mining operation will be restarted as early as possible after completing rescue work, restoring safety and security, repairs of roads etc.

(ix) Economic Repercussion of Closure of Quarry and manpower Retrenchments:

The quarry lease is granted for a period of five years only. As per the production Programme envisaged, there will be no effect on the man power as the majority of persons belong to nearby villages and will have an option either to be available for employment for the next contract/ lease or do the agriculture in their fields.

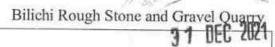

(x) Time Scheduling For Abandonment:

The lease applied area has enormous potential for continuance of operations even after the expiry of the lease period. The details of time schedule of all abandonment will be given at the time of final closure plan.

(xi) Abandonment Cost:

As at present mining is not going to be closed so abandonment cost could not be assessed. However based on the progressive quarry closure activities during the plan period, cost is assessed as given below:

Land Use Table - 19

ACTIVITY		1	D . mr	AMOUNT					
ACTIVITY	1	П	Ш	IV	V	RATE	(INR)		
Plantation under safety zone (In Nos.)	40	40	40	40	40		Rs.20,000/-		
Plantation Cost	4,000	4,000	4,000	4,000	4,000	@100	110.20,000/		
Plantation in quarried out bench and approach road (In Nos.)	60	60	60	60	60	Rs Per sapling	Per	Per	Rs.30,000/-
Plantation Cost	6,000	6,000	6,000	6,000	6,000				
Wire Fencing (In Mtrs) 750 Mtrs	2,25,000	*	*	*	*	@300 Rs Per Meter	Rs.2,25,000/-		
Garland drain (In Mtrs) 500 Mtrs	1,50,000	21	-	•	8	@300 Rs Per Meter	Rs.1,50,000/-		
	TO	TAL					Rs. 4,25,000/-		



12 ANY OTHER DETAILS INTEND TO FURNISH BY THE APPLICANT DEC 2021

This Mining plan for Rough stone (Charnockite) and Gravel is under Rules 41 & 42 as per the Amended under Tamil Nadu Minor Mineral Concession Rules, 1959. The provisions of the Mines Act, Rules and Regulations and orders made there under shall be complied within the quarrying operation, so that the safety of the mine, machinery and person will be well protected. Permission, relaxation or exemption wherever required for the safe and scientific quarrying of the deposit will be obtained from the Department of Mines Safety. Any violation pointed out by the inspecting authorities shall be rectified as per the guidelines of the Concerned Department.

Prepared by

P. Viswanathan, M.Sc.,

Qualified person

Place: Salem

Date: 10.12.2021

SPREAD GREEN
SAVE BLUE

This Mining Plan is Approved subject to the conditions / stipulation & indicated in the Mining Plan Approval Letter No: ミナビ | Minus | 21 はっこいのでは、 office of the A.D. Geology & Mining Coimbatore

This Mining Plan is Approved based on the incorporation of the particulars specified in the letter of the commissioner of Geology and Mining. Chennal ref No: 3863/LC/2012 Dated 19.11.2012 and subjected to further fulfillment of the condition laid down under Tamilnadu Minor Mineral Concession Rules 19*

ASSISTANT DIRECTOR
DEPARTMENT OF GEOLOGY & MINING
COMBATORE DISTRICT.



உதவி இயக்குநர் அலுவலகம், புவியியல் மற்றும் சுரங்கத்துறை, மாவட்ட ஆட்சியர் அலுவலக வளாகம், கோயம்புத்தூர் - 18.

ந.க.எண்.875/கனிமம்/2021

நாள்: 02.12.2021

குறிப்பாணை

பொருள்: கனிமங்களும் குவாரிகளும் - கோயம்புத்தூர் மாவட்டம் -கோயம்புத்தூர் வடக்கு வட்டம் - பினிச்சி கிராமம் - புல எண்கள். 1120/2-ல் 1.52.50 ஹெக்டேர் மற்றும் 1121/2-ல் 1.08.00 ஹெக்டேர் ஆக மொத்தம் 2.60.50 ஹெக்டேர் பரப்பளவுள்ள பட்டா பூமியில் சாதாரணகற்கள் மற்றும் கிராவல் மண் வெட்டியெடுக்க தி/வா.ஸ்ரீ ராஜ லட்சுமி சாமப்பா பில்டிங் மெட்டீரியல்ஸ் என்ற நிறுவனத்திற்கு -குவாரி குத்தகை அனுமதி வழங்குவது - தொடர்பாக.

- பார்வை: 1. தி/வா.ஸ்ரீ ராஜ லட்சுமி சாமப்பா பில்டிங் மெட்டீரியல்ஸ் கம்பெனி, 677/1A, வெள்ளமடை, கோயம்புத்தூர் மாவட்டம் என்ற நிறுவனத்தின் விண்ணப்பம் நாள் 12.07.2021.
 - 2. இவ்வலுவலக கடிதம் இதே எண். நாள்: 13.07.2021.
 - வருவாய் கோட்டாட்சியர், கோயம்புத்தூர் வடக்கு அவர்களின் கடித ந.க.எண். 1784/2021/அ3 நாள் 08.10.2021.
 - உதவி புவியியலாளர், புவியியல் மற்றும் சுரங்கத்துறை, கோயம்புத்தூர் அவர்களின் தணிக்கை அறிக்கை நாள்: 25.11.2021
 - இயக்குநர், புவியியல் மற்றும் சுரங்கத்துறை, சென்னை கடிதம் எண். 1870/எம்.எம்-1/2020 நாள்: 12.08.2020.

பார்வை 1-ல் கோயம்புத்தூர் மாவட்டம், கோயம்புத்தூர் வடக்கு வட்டம், வெள்ளமடை, 677/1A என்ற முகவரியில் இயங்கி வரும் தி/வா.ஸ்ரீ ராஜ லட்சுமி சாமப்பா பில்டிங் மெட்டீரியல்ஸ் என்ற நிறுவனத்தினர் கோயம்புத்தூர் மாவட்டம், கோயம்புத்தூர் வடக்கு வட்டம், பிளிச்சி கிராமம், புல எண்கள். 1120/2-ல் 1.52.50 ஹெக்டேர் மற்றும் 1121/2-ல் 1.08.00 ஹெக்டேர் ஆக மொத்தம் 2.60.50 ஹெக்டேர் பரப்பளவுள்ள பட்டா பூமியில் சாதாரணகற்கள் மற்றும் கிராவல் மண் வெட்டியெடுக்க குவாரி குத்தகை உரிமம் கோரி உரிய ஆவணங்களுடன் விண்ணப்பித்துள்ளார்.

மேற்படி மனு தொடர்பாக, கோயம்புத்தூர் வடக்கு வருவாய் கோட்டாட்சியர் மற்றும் கோயம்புத்தூர் புவியியல் மற்றும் சுரங்கத்துறை உதவி



புவியியலாளர் ஆகியோர் புலத்தணிக்கை மேற்கொண்டு கோயம்புத்தூர் மாவட்டம், கோயம்புத்தூர் வடக்கு வட்டம், வெள்ளமடை, 677/1A என்ற முகவரியில் இயங்கி வரும் தி/வா.ஸ்ரீ ராஜ லட்சுமி சாமப்பா பில்டிங் மெட்டீரியல்ஸ் என்ற நிறுவனத்திற்கு கோயம்புத்தூர் மாவட்டம், கோயம்புத்தூர் வடக்கு வட்டம், பிளிச்சி கிராமம், புல எண்கள். 1120/2-ல் 1.52.50 ஹெக்டேர் மற்றும் 1121/2-ல் 1.08.00 ஹெக்டேர் ஆக மொத்தம் 2.60.50 ஹெக்டேர் பரப்பளவுள்ள பட்டா பூமியில் சாதாரணகற்கள் மற்றும் கிராவல் மண் வெட்டியெடுக்க சில நிபந்தனைகளுடன் பரிந்துரை செய்துள்ளார்கள்.

அனுமதி கோரும் புல எண்கள். 1120/2 மற்றும் 1121/2 ஆகியவை பட்டா எண் 3450-ன் படி திரு.பழனிசாமி மகன் திரு.சித்தார்த்தாமெனலி மற்றும் திரு.ஞானசேகரன் மகன் ஸ்ரீகாந்த் ஆகியோர்கள் பெயரில் கூட்டுப்பட்டாவாக கிராம கணக்கில் தாக்கலாகியுள்ளது. மேற்படி புலங்களில் தி/வா.ஸ்ரீ ராஜ லட்சுமி சாமப்பா பில்டிங் மெட்டீரியல்ஸ் என்ற நிறுவனத்திற்கு குவாரி குத்தகை அனுமதி வழங்கும் நாளிலிருந்து பத்து ஆண்டுகளுக்கு சாதாரண கற்கள் மற்றும் கிராவல் மண் வெட்டியெடுக்க தங்களுக்கு எவ்வித ஆட்சேபணையும் இல்லை என பட்டாதாரர்கள் மேற்படி நிறுவனத்திற்கு சம்மத கடிதம் அளித்துள்ளார்கள். எனவே மேற்படி பூமியில் தி/வா.ஸ்ரீ ராஜ லட்சுமி சாமப்பா பில்டிங் மெட்டீரியல்ஸ் என்ற நிறுவனம் குவாரி குத்தகை உரிமம் பெற தகுதியுடையது ஆகும்.

எனவே, வருவாய் கோட்டாட்சியர், கோயம்புத்தூர் வடக்கு மற்றும் உதவி புவியியலாளர், புவியியல் மற்றும் சுரங்கத்துறை, கோயம்புத்தூர் ஆகியோரின் பரிந்துரைகளின் அடிப்படையில் கோயம்புத்தூர் மாவட்டம், கோயம்புக்கூர் வடக்கு வட்டம், வெள்ளமடை, 677/1A என்ற முகவரியில் இயங்கி வரும் தி/வா.ஸ்ரீ ராஜ லட்சுமி சாமப்பா பில்டிங் மெட்டீரியல்ஸ் என்ற நிறுவனத்திற்கு கோயம்புத்தூர் மாவட்டம், கோயம்புத்தூர் வடக்கு வட்டம், பிளிச்சி கிராமம், புல எண்கள். 1120/2-ல் 1.52.50 ஹெக்டேர் மற்றும் 1121/2-ல் 1.08.00 ஹெக்டேர் ஆக மொத்தம் 2.60.50 ஹெக்டேர் பரப்பளவுள்ள பட்டா பூமியில் 1959-ஆம் ஆண்டு தமிழ்நாடு சிறுகனிம சலுகை விதிகளில் விதி 19(1) மற்றும் 20-ன் படி குத்தகை ஒப்பந்த பத்திரம் நிறைவேற்றும் நாளிலிருந்து 5 (ஐந்து) ஆண்டுகளுக்கு சாதாரண கற்கள் மற்றும் கிராவல் மண் வெட்டியெடுக்க கீழ்கண்ட நிபந்தனைகளுக்குட்பட்டு குவாரி குத்தகை நிலப்பரப்பாக (Precise வழங்குவதற்குரிய Area Communication) கருதப்படுகிறது.

நிபந்தனைகள்

 அருகிலுள்ள பட்டா நிலங்களுக்கும் மற்றும் பொது மக்களுக்கும், எவ்வித இடையூரும் இன்றி சாதாரண கல் மற்றும் கிராவல் குவாரி மேற்கொள்ள வேண்டும்.


2 அருகில் உள்ள பட்டா நிலத்திற்கு 7.5 மீட்டர் பாதுகாப்பு இடைவெளி விட்டு குவாரிப்பணி மேற்கொள்ள வேண்டும்.

3. குழந்தை தொழிலாளர்களை வேலைக்கு அமர்த்தல் கூடாது.

மேலும், தமிழ்நாடு சிறுகனிம சலுகை விதிகள்-1959 விதி எண். 41 மற்றும் 42-ன் படி குவாரிப்பணி மேற்கொள்வது தொடர்பாக வரைவு சுரங்க திட்டத்தினை 90 தினங்களுக்குள் சமர்ப்பிக்குமாறும், மாநில சுற்றுச்சூழல் தாக்க மதிப்பீட்டு அதிகார அமைப்பின் அனுமதியினை பெற்று சமர்ப்பிக்கவும் மனுதாரரை கேட்டுக் கொள்ளப்படுகிறது.

> உதவி இயக்குநர், புவியியல் மற்றும் சுரங்கத்துறை கோயம்புத்தூர்.


பெறுநர்: தி/வா.ஸ்ரீ ராஜ லட்சுமி சாமப்பா பில்டிங் மெட்டீரியல்ஸ் கம்பெனி, 677/1A, வெள்ளமடை, கோயம்புத்தூர் மாலட்டம்

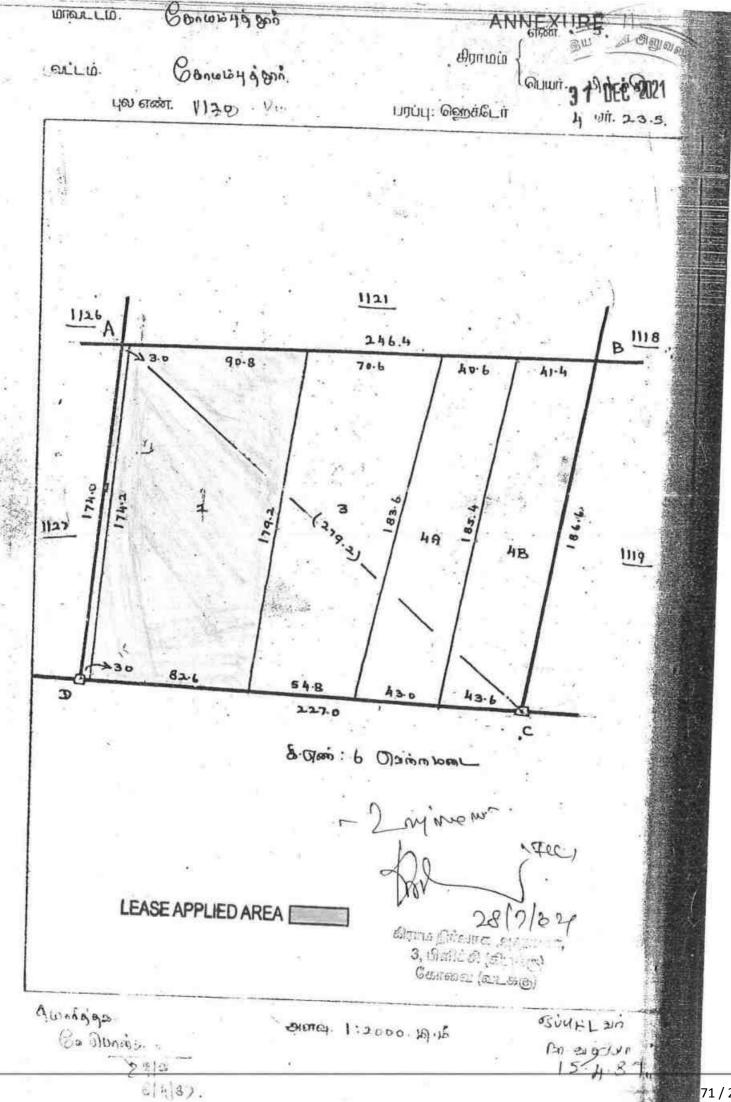

71 / 208

Maria. Commo ya son சிராமம் மம் **31 DEC 2021** டையா். அக்ஃகி (Bows 48 800) LLUI. ଧ୍ୟ ଗଙ୍ଗ, (12) பரப்பு: ஹெக்டேர் 2 ஏர். 85-5 1125 1122 233.6 92.4 (231.6) 39.8 A2-6 0 (25).0) 1126 63.0 246-4 1127 1120 a kirosa di pure propiesal. (257.0) 4.8 &wakiga: (318164. 1: 2000. 16.16. SUULLAN Con alla co

72 / 208

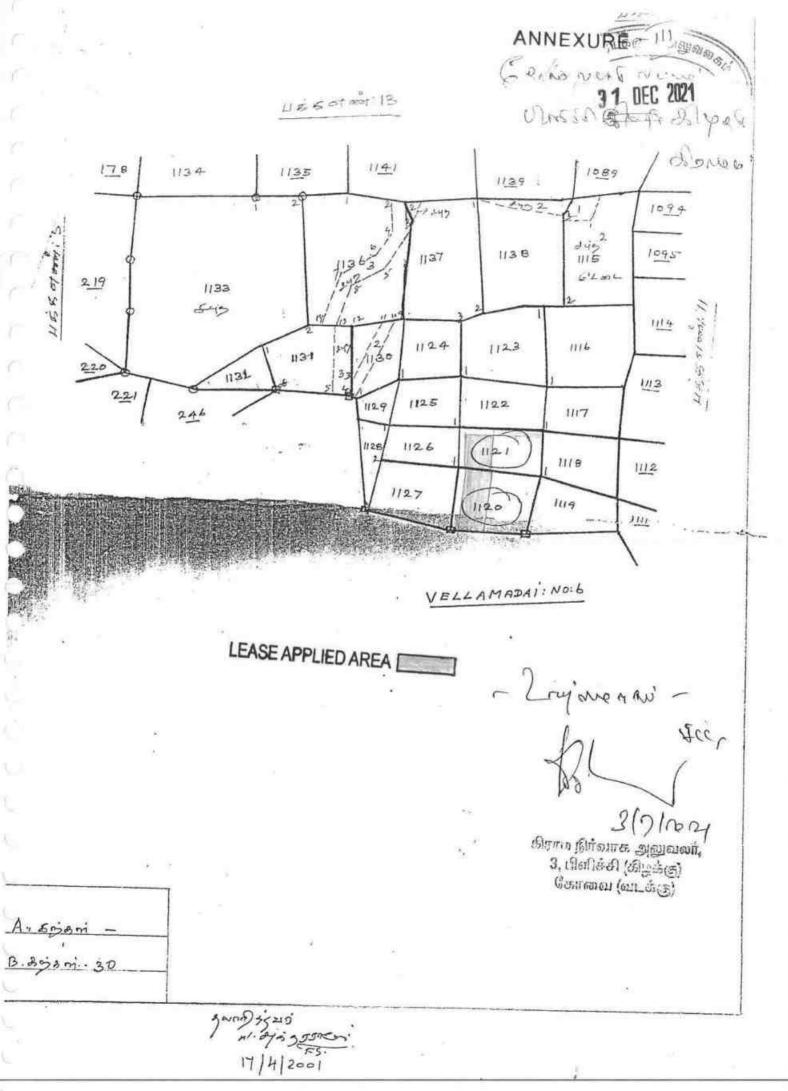

https://eservices.tn.gov.in/eservicesnew/fand/chit@faxtract_ta.html?...

11-5



தமிழக அரசு

வருவாய்த் துறை

நில உரிமை விபரங்கள் : இ. எண் 10(1) பிரிவு

மாவட்டம் : கோயம்புத்தூர்

வட்டம் : கோயம்புத்தூர் வடக்கு

வருவாய் திராமம் : பிளிச்சி (கி-மே)

பட்டா எண் : 3450

உரிமையாளர்கள் பெயர்

1. பழனிசாமி

மகன்

சித்தார்த்தாமௌலி

ஞானசேகரன் மகன் முகாந்த் புல எண் உட்பிரிவு புன்செய் நன்செய் மற்றவை குறிப்புரைகள் பரப்பு தீர்வை பரப்பு தீர்வை பரப்பு **தீர்வை** ஹெக் - ஏர் ரூ - பை ஹெக் - ஏர் ரு - பை ஹெக் - ஏர் CT5 - 600LI 2019/0103 1120 2 1 - 52.501.88 /12/182036---- 14-07-2019 2019/0103 1121 1 - 8.00 1.34 /12/182036--- 14-07-2019 2 - 60.50 3.22

தறிப்பு2 :



- 1. மேற்கண்ட தகவல் / சான்றிதழ் நகல் விவரங்கள் மின் பதிவேட்டிலிருந்து பெறப்பட்டவை. இவற்றை தாங்கள் https://eservices.tn.gov.in என்ற இணைய தளத்தில் 12/02/005/03450/30522 என்ற குறிப்பு எண்ணை உள்ளீடு செய்து உறுதி செய்துகொள்ளவும்.
- 2. இத் தகவல்கள் 21-06-2021 அன்று 09:16:00 AM நேரத்தில் அச்சடிக்கப்பட்டது.
- 3. கைப்பேசி கேமராவின்2D barcode படிப்பான் மூலம் படித்து 3G/GPRS வழி இணையதளத்தில் சரிபார்க்கவும்

JENET DI BURNING

1 2 3 4 5 6 7 8 9 10 11 13 1116 2 1116-117 0 14 8-4 6 1 24 0 56.5 0 70 1625 a. grate and sequent			To the same	in the same	March	-	-			0 1				Jane Gray Man
1116 2 1116-UN 0 U 8-4 6 1 24 0 56.5 0 70 1625 a. grass		296		Pfinds			11 (14 (14 (14 (14 (14 (14 (14 (14 (14 (i i	10.50	B	. e7	188v. 5.	பிளிச்தி	31 DEC 2021
1116 2 1116-Lin \(\sigma \) \(\square\) \(_	1	2	3	4	5	6	, 7	-	8		9	10	11 .
3 -LIT F LI 8-4 6 1 24 0 67-5 0 84 435 a. Gravity and (2) a. assa or grave (3). 4 -LIT D LI 8-4 6 1 24 0 08-0 0 10 1711 a. grave and subgisted or grave (3). 5 -LIT D LI 8-4 6 1 24 0 75-0 0 93 1625 a. grave and grave (3). 6 -LIT D LI 8-4 6 1 24 0 71-0 0 88 435 a. Gravity and subgisted or grave (3). 6 -LIT D LI 8-4 6 1 24 0 71-0 0 88 435 a. Gravity and subgisted or grave (3). 1117 1117 D LI 8-4 6 1 24 2 35-5 2 91 895 a. grave and any substitution of the control of t	1116	5 2	ادا-1116				8.4		1		1		1	
4	11						0			24		0 56.5	0 70	சாமி (1). கை பழவச் சாமி (2) கே கணக
5 -பா ஏ பு 8-4 6 1 24 0 08.0 0 10 1711 க. ராமசாம் மற்றும் முறை தி இரை பி மற்றும் முறை தி இரை பி மற்றும் முறை தி விடியில் கிறும் முறை தி கிறும் முறை தி கிறும் முறை தி விடியில் கிறும் முறை தி கிறும் முறை தி கிறும் முறை தி விடியில் கிறும் முறை கிறும் கிறும் முறை கிறும் கிறும் முறைப் கிறும் முறைப் கிறும் முறைப் கிறும் முறைப் கிறும் முறைப் கிறும் கிறும் கிறும் முறைப் கிறும் கிறும் முறைப் கிறும் கிறும் கிறும் முறைப் கிறும் கிறும் கிறும் முறைப் கிறும் கிறும் முறைப் கிறும் கிறும் முறைப் கிறும் முறைப் கிறும் முறைப் கிறும் கிறும் கிறும் முறைப் கிறும் கிறும் முறைப் கிறும் கிறும் முறைப் கிறும் கிறும் கிறும் முறைப் கிறும் க			-un	r	4		8-4	6	1	24		0 67-5	0 84	435 a. G. sweller
5		4	- L J17	D	4		8–4	6	1	24	1	0.80	0 10	1711 க. ராமசாமி கிரைப் மற்றும் முறை
6		5	-ur	σ	: ч	*	8-4	6	1	24	(75-0	0 93	1625 க. நாம சாமி (1), க. பழனிச் சாமி (2),
1117 1117 ர பு 8-4 6 1 24 2 35.5 2 91 895 க. ஏக்கசாமி கவுண்டர். 1118 1119 ர பு 8-4 6 1 24 3 36.5 4 16 217 ச. இகம்ப மான். 1120 1 1120-1 ஏ பு 8-4 6 1 24 0 03.0 0 06 1626 டே ஏர்மண்ண கவுண்டர் (1), பெ ரங்களம் கவுண்டர் (2), பெ ரங்களம் கவுண்டர் (3), பெ ரங்களம் கவுண்டர் (3), கின்ன சாமி சாமின்ன சாமி சாமின்ன சாமி சாமின்ன சாமி சாமின்ன சாமி சாமின்ன சாமின்ன சாமி சாமின்ன சாமி சாமின்ன சாமி சாமின்ன		6	-шт,	ø	ч		8–4	6	1	24	0	71-0	0 88	9 - 1 இ (3) - 435 க. செலம்ப
1118 1118 ர பு 8-4 6 1 24 2 35.5 2 91 895 க. ரங்களம் கவுண்டர். 1119 1119 ர பு 8-4 6 1 24 3 36.5 4 16 217 ச. கெம்ப மாள். 1120 1 1120-1 ர பு 8-4 6 1 24 0 03.0 0 06 1626 பே. ராமண்ண கவுண்டர் (1), பெ. ரங்களம் கூரண்டர் (1), பெ. ரங்களம் கூரண்டர் (2), பெ. ரங்களம் கூரண்டர் (3). 2 -2 ர பு 8-4 6 1 24 1 52.5 1 88 1006 பே. ராமண்ண கூரண்டர் (3). 3 -3 ர பு 8-4 6 1 24 1 52.5 1 88 1006 பே. ரங்களம் கூரண்டர் (4) கேரண்டர் (4) கேரண்											-5	36.0	6 63	
1118 1118 g 4 8-4 6 1 24 3 04.5 3 77 314 g. Act control (4) 1119 1119 g 4 8-4 6 1 24 3 36.5 4 16 217 g. Gathu toneir. 1120 1 1120-1 g 4 8-4 6 1 24 0 03.0 0 06 1626 Qu. gringer consequent (1), Qu. gringer (1	1117	***	1117	p	ч		8-4	6	1	24	2	35.5		895 க. ரங்களமி
1119 1119 ர பு 8-4 6 1 24 3 36.5 4 16 217 ச. கெம்ப மான். 1120 1 1120-1 ர பு 8-4 6 1 24 0 03.0 0 06 1626 பே. ராமண்ண கவுண்டர் (1), பெ. சின்ன சாமி கவுண்டர் (2), பே. சின்ன சாமி கவுண்டர் (3). 2 -2 ர பு 8-4 6 1 24 1 52.5 1 88 1006 பே. ராமண்ண கவுண்டர் (3). 3 -3 ர பு 8-4 6 1 24 1 13.5 1 40 896 பே. ராமண்ண கவுண்டர் . 4A -4டார் ர பு 8-4 6 1 24 0 77.0 0 95 748 பொ. மாரப்ப கவுண்டர் . 4B -4பா ர பு 8-4 6 1 24 0 77.5 0 96 309 போ. சின்ன		•••	1118	r	4			6	j	24	3	04.5	3 77	314 ச. இன்னசாமி
1120 1 1120-1 σ ψ 8-4 6 1 24 0 03.0 0 06 1626 $Gu \cdot \sigma \pi i g correct co$	1119	***	1119		ч		8-4	6	1	24	3	36.5	4 16	217 ச. கெம்ப இருப
2 -2 ஏ பு 8-4 6 1 24 1 52.5 1 88 1006 பெ. ரங்களமி கவுண்டர் (3). 3 -3 ர பு 8-4 6 1 24 ! 13.5 1 40 896 பெ. ரங்களமி கவுண்டர். 4A -4பா ர பு 8-4 6 1 24 0 77.0 0 95 748 பொ. மாரப்பி கவுண்டர். 4B -4பா ர பு 8-4 6 1 24 0 77.5 0 96 309 போ. சின்ன	1120	1	1120-1	1	ч		8-4	6	1	24	0	03.0	0 06	1626 பெ. சாமண்ண
3 -3 p 4 8-4 6 1 24 1 52.5 1 88 1006 Qu. gribate and square in. 4A -41.01 p 4 8-4 6 1 24 0 77.0 0 95 748 Quit. uniquid and and and and and and and and and an								į						பெ - ரங்கசாமி கவண்டர் (2), பெ - சிண்ண சாமி
3 -3 p 以 8-4 6 1 24 ! 13.5 1 40 896 Qu. 可能毎年768 年刊 日本 -4に可 p 以 8-4 6 1 24 0 77.0 0 95 748 Qu. では毎年768 年刊 日本 -4に申 p 以 8-4 6 1 24 0 77.5 0 96 309 Qu. 日本	1	2	-2	σ.	4		8-4	6	1	24	1	52.5	1 88	7.76 min 1
4A -41.11 p 4 8-4 6 1 24 0 77.0 0 95 748 Quit un più de descrit 4B -4un p 4 8-4 6 1 24 0 77.5 0 96 309 Quit 8 20 20 20 20 20 20 20 20 20 20 20 20 20	-	3	-3	D	4		8-4	6	I	24	!	13.5		தவுண்டர். 896 பெ. ஏங்கசாமி
4B -4Un r 4 8-4 6 1 24 0 77.5 0 96 309 Qun - 8 ix sa	-	4A	-41.01	ø	ч		8-4	6	1	24	0	77-0	0 95	748 பொ. மாரப்ப
		4B	-4un	or	4		84	6	1	24	0	77-5	0 96	309 பொ. கெல்ல
4 23.5 5 29 2 ~ mag w -		77.00								-	4	23.5	5 29	Zajneow-

1 1121-1 9 4 8-4 6 1 24 0 08.0 0 10 1626 GG 10 1626	-	2	3	4	5	7	7		8		9		10	, 11	. 1
2 -2 g y 8-4 6 1 24 1 08.0 1 34 1006 Gur gracedo cos conscious. 3 -3 0 H 8-4 6 1 24 0 72.0 0 89 897 Geor gracedo cos conscious. 4A -4un g y 8-4 6 1 24 0 48.5 0 60 307 Geor gracedo cos conscious. 4B -4un g 8-4 6 1 24 0 48.5 0 60 307 Geor gracedo cos conscious. 2 85.5 3 53 1 1122-1 g 8-4 6 1 24 0 0 03.0 0 0.6 1777 Geor gracedo cos conscious. 2 85.5 3 53 1 1122-1 g 8-4 6 1 24 0 0 72.5 0 34 1007 Geor gracedo cos conscious. 3 -3 g y y 8-4 6 1 24 0 17.0 0 21 1777 Geor gracedo cos conscious. 4 -4 g 8-4 6 1 24 0 27.5 0 34 1007 Geor gracedo cos conscious. 5 -5 g y 8-4 6 1 24 0 27.5 0 34 1006 George gracedo cos conscious. 6 -6 g y 8-4 8-4 6 1 24 0 27.5 0 37 309 Geor George gracedo cos conscious. 7 -7 g y 8-4 6 1 24 0 29.5 0 37 309 Geor George gracedo cos conscious. 8 -8 g y 8-4 6 1 24 0 20.5 0 26 748 George gracedo conscious. 9 -9 g y 8-4 6 1 24 0 31.0 0 39 1006 Geor gracedo cos conscious. 9 -9 g y 8-4 6 1 24 0 24.5 0 30 897 Ceor gracedo cos conscious.	1 1	1121-1	σ	4		8-4	6	1				1		1626 GO 10 1 1 1 1 1 1 1 1 1 1 1 1 1 1 1 1 1 1	2
3	2	-2	o	4		8-4	6	1	24	1	08.0	1	34	கவுண்டர் (3) . -1006 பெ. ராமண்ண	
4B -4U" \$	3	÷3	- D	a H		8-4	6	1	24	0	72•0	0	89	897 வெ. ரங்களாமி	
1 1122-1 g. 4 8-4 6 1 24 0 0.03-0 0 06 1777 Gas. grains and sequences. 2 85.5 3 53 1 1122-1 g. 4 8-4 6 1 24 0 0.03-0 0 06 1777 Gas. grains and sequences. 3 -3 g 4 8-4 6 1 24 0 27.5 0 34 1007 Gas. grains and sequences. 4 4 4 g. 4 g. 4 8-4 6 1 24 0 27.5 0 34 1006 Gu. grains and sequences. 5 -5 g 4 8-4 6 1 24 0 27.5 0 37 309 Guir. Plane and sequences. 6 -6 g 4 8-4 6 1 24 0 29.5 0 37 309 Guir. Plane and sequences. 7 -7 g 4 8-4 6 1 24 0 20.5 0 26 748 Guir. Large and sequences. 8 -8 g 4 8-4 6 1 24 0 31.0 0 39 1006 Gu. grains and sequences. 9 -9 g 4 8-4 6 1 24 0 24.5 0 30 897 Gas. grains and sequences.	1949	-4uπ 3	σ			8-4	6	. 1	24	- 0	49.0	0	60	748 Qum. மாரப்ப	
1 1122-1 p. 4 8-4 6 1 24 0 0.03-0 0 06 1777 Qui: gibrer ill auchie q. 2 85-5 3 53. 1 1122-1 p. 4 8-4 6 1 24 0 0.03-0 0 06 1777 Qui: gibrer ill auchie q. 2 -2 p. 4 8-4 6 1 24 0 27-5 0 34 1007 Qui: gibrer ill auchie q. 3 -3 p. 4 8-4 6 1 24 0 17-0 0 21 1777 Qui: gibrer ill auchie q. 4 -4 p. 4 8-4 6 1 24 0 27-5 0 34 1007 Qui: gibrer ill auchie q. 5 -5 p. 4 8-4 6 1 24 0 27-5 0 34 1006 Qui gracole cut. 5 -5 p. 4 8-4 6 1 24 0 29-5 0 37 309 Quiri. Blair cor gracole cut. 6 -6 p. 4 8-4 6 1 24 0 29-5 0 37 309 Quiri. Blair cor gracole cut. 7 -7 p. 4 8-4 6 1 24 0 52-0 0 64 310 p. Blair cor gracole cut. 8 -8 p. 4 8-4 6 1 24 0 31-0 0 39 1006 Qui gracole cut. 9 -9 p. 4 8-4 6 1 24 0 31-0 0 39 1006 Qui gracole cut. 9 -9 p. 4 8-4 6 1 24 0 24-5 0 30 897 Qui gibre cut.	48	-4011	σ			8-4	6	1	24	0	48-5	. 0	60	309 இபா. கின்ன	1
1 1122-1 g. 4 8-4 6 1 24 0 03.0 0 06 1777 Qai. gravas and sustained and the supply by produced to the physics and the sustained and th										2	85.5	3			-44
2 -2 F .4 8-4 6 1 24 0 27.5 0 34 1007 Gas. prices and in the price series of the s	1	1122-1	σ.	. 4		8-4	6	. 1	24	0	02.0	-+	۰.		
3 -3 g 4 8-4 6 1 24 0 27.5 0 34 1007 Gas: gracioses and state in adjoint in the problem of t			21	3-3					-	. 0	.03.0	Ů	.00	மற்றும் தான்ற	வண்டி பாதை
3		-2	F .	.4		8-4	6	1	24	0	27-5	0	34	1007 வெ. ராமண்ண	gri en
5 -5 \(\sigma \) . 4 \(\cdot \) 8-4 \(6 \) 1 \(24 \) 0 \(27.5 \) 0 \(34 \) 1006 \(\text{QU.} \) griderics \(\text{griffelia} \) \		13 60			***	8-4	6	1	24	0	17-0	0	21	1777 வெ. ரங்கராம் கவுண்டர் மற்றும் தான்கு	
6 -6 \(\sigma \) 4 \\ \ \ \ \ \ \ \ \ \ \ \ \ \ \ \ \	10.			- 53				1	24	0	27.5	0	34	1006 பெ. நாழன்கள	
7 -7 ர பு 8-4 6 1 24 0 52.0 0 64 310 ச. கின்ன சாமி கவுண்டர். 8 -8 ர பு 8-4 6 1 24 0 31.0 0 39 1006 பே. ராமண்ண சவுண்டர். 9 -9 ர பு 8-4 6 1 24 0 24.5 0 30 897 வே. ரங்களம்		-3	σ .	.4	.	8-4	6			0	29.5	0	37	au rg	
7 -7 \(\sigma \) 4 \\ \cdots \) 8-4 \(6 \) 1 \(24 \) 0 \(20.5 \) 0 \(26 \) 748 \(\text{Gun} \cdots \text{ungive} \) \(\text{exposite} \text{Lit} \cdots \) 8 \(-8 \) \(\text{F} \) 4 \\ \cdots \) 8-4 \(6 \) 1 \(24 \) 0 \(31.0 \) 0 \(39 \) 1006 \(\text{Qu} \cdots \text{gradistrict} \) \(\text{exposite} \text{Lit} \) 9 \(-9 \) \(\text{F} \) 4 \\ \cdots \) 8-4 \(6 \) 1 \(24 \) 0 \(24.5 \) 0 \(30 \) 897 \(\text{Qu} \cdots \text{gradistrict} \)	6	-6	σ	4		8-4	6	1	24	0	52 • 0	0	64	310 # · Bairer	
9 -9 ர பு 8-4 6 1 24 0 31-0 0 39 1006 பெ. ராமண்ண 9 -9 ர பு 8-4 6 1 24 0 24-5 0 30 897 வே. ரங்களம்	7	-7	σ	4		8-4	6	1	24	0	20-5	0	26	சவுண்டர். 748 போ. மாரப்ப	
9 -9 \sigma 4 8-4 6 1 24 0 24-5 0 30 897 @a. states 1.0	8	-8	gr	4		8-4	6	1	24	0	31-0	0	39	கவுண்டர். 1006 பெ. ராமண்ண	
	9	-9	σ	4		8-4	6	1	24	0 :	24-5				n i

புள்து.

• விவரப்பட்டியேலைப் பார்க்கவும்.

3, பிளிச்சி (இதஞ்சு) கோவை (வடக்கு)

	then er	யிற் தி	்டத்தி	ชักเมอ	Edwarni 11	ரவட்டம் சாகுமு	16 am	Doy	1 一直に	TO BE	MAN
74.1	1460	हो। यः नी	ன் விப	già.		பானின் பொள்.	1	000	ல் போகப்).	& pop
	-			£)	1 AS 50 m			1	31 DE	C 2021	-
Giet. Merkenbit friede	8 உட்பிரிவு எண்.	(S) untiqu.	द्वीतं काका.	ஒரு போகம் அல்லது இரு போகம்.	கைப்பற்று தாரருடைய பெயரும் எண்ணும் அல்லது அனுபோக தாரருடைய பெயர்	நிலத்தின் எந்த பகுதி யாவது சாகுபடியாளரால் பயிரிடப்பட்டுள்ளதா.	எந்த மாதத்தில் பயிர் செய்யப்பட்டது எந்த மாதத்தில் அறுவடை செய்யப்பட்டது.	DuShflखं जिपाताते.	பயிரான /அறுவக்ப யான் பரப்பு,	உண்பையான பார்ச்சல் ஆதாரம்,	விளைச்சல் அளவு
			(4)	(5)	(6)	(7)	(8)	(9)	(10)	(11)	(12)
120	2	152		34	SO Spyrity	Oran					
1121	2	1.08	1.34	34		Osq					
								-	μ. 		
										in a	
						-2	contino	y ot	-		
							h.	L.	Ja)	
							Try	/		N STORY OF THE STO	
	+			+		,	0	312	1224	, W	
							ரொம் நிர் தே இசிர் சோக	aures lei (e s au (eu	ල්ල ්) ජුබාන න්	-	
+	-	_						(
10.5	-										



8-7-202

AND SHOTE TAME MADU T. RADHAMANI AB LAS UNBOUGHE BRIDING LINGUIN L.No: 8936/B1/2017 dt. 11.01.2018 Shop No.16.Old Post Office Road, . 1. Openion significant 813. UMS Building,

(BENEDIO)

numir 1. porto

சம்மத கடிதம்

ஆம் தேதி கோயம்புத்தூர் மாவட்டம், கேர்யம்புத்தூர் 2021 ஆம் வருடம் ஜீலை மாதம் வடக்கு தாலூக்கா, கோயம்புத்தூர் - 641 110, வெள்ளமடை, கதவு எண். 677/1A முகவரியில் இயங்கி வரும் "ஸ்ரீ ராஜலட்சுமி சாமப்பா பில்டிங் மெட்டீரியல்ஸ்" என்ற பெயரில் இயங்கி வரும் கூட்டு கம்பெனிக்கு, கோயம்புத்தூர் மாவட்டம், காரமடை கிராமம், கண்ணார்பாளையம், கதவு எண். 2/246 முகவரியில் வசித்து வரும் திரு. பழனிச்சாமி அவர்கள் குமாரர் திரு. சித்தார்த்தா மொளலி (1) மேற்படி கதவு எண். 2/241 முகவரியில் வசித்து வரும் திரு.ஞானசேகரன் அவர்கள் குமாரர் திரு.டேஸ்ரீசாந்த் (2) ஆகிய எங்களுக்கு கோயம்புத்தூர் மாவட்டம், கோயம்புத்தூர் வடக்கு தாலூக்கா, பிளிச்சி கிராமம், பட்டா எண். 3450-ன் படி க.ச.1120/2 நெ. காலையில் பாத்தியப்பட்ட 1.52.50 பு.ஹெக்டேர் பரப்பு மற்றும் 1121/2 நெ. காலையில் பாத்தியிப்பட்ட 1.08.00 பு.ஹெக்டேர் பரப்புள்ள பூமியானது எங்கள் இருவருக்கும் கூட்டாகப் பாத்தியப்பட்டது. மேற்படி பூமியில் சாதாரண கற்கள் மற்றும் கிராவல் மண்வெட்டியெடுக்க "ஸ்ரீ ராஜலட்சுமி சாமப்பா பில்டிங் மெட்டீரியல்ஸ்" கம்பெனிக்கு அனுமதி அளிக்கும் நாளிலிருந்து (10) ஆண்டுகளுக்கு மனப்பூர்வமாக சம்மதிக்கிறோம் என இதன்மூலம் உறுதி பத்து கூறுகிறோம்.

78 / 208



PARTNERSHIP DEED

This Deed of Partnership is entered into this 22th day of April 2019, Between

- 1. Mr.S.GNANASEKARAN, S/O.SAMAPPA GOWDER, aged about 5 Years
 Residing at No. 2/241, KANNARPALAYAM, KARAMADAL 641 104.
 (HEREINAFTER CALLED THE PARTY OF THE FIRST PART)
- 2. Mr. S.PALANISAMY, S/O, SAMAPPA GOWDER, aged about 55
 years Residing at No. 2/246, KANNARPALAYAM,
 TARAMADAI-641 104.

(HEREINAFTER CALLED THE PARTY OF THE SECOND PART)

1. Apronor

3. Majerwan

A. K. Nalisani.

एक सो एपये Rs. 100 (0) F (0) HUNDRED'RUPEES PROTINDIA : SELECTION OF SUBJECTAL SELECTION OF THE தப் ழ்நாடு எடுள்ளாரு TAMILNADU கி.100/- A சி. மவரி 2--4 2219 - Sri Rojalakshni Samappa A. சத்யவதி BF 716797 Building Materials Conyay (4) & Donn & Dipumonumini S.F. No. 677/1, Vellamadai 2-D. Consultação en mail E.B. ஆமிஸ் வதி Coimbatone = 641110 மேட்டுமானையம் 641:301 உரியப் எஷ்: 7323/81/2008/16 3. Mrs. M.RAJESWARI, D/O MATHAPPA GOUNDER, aged about 64 years Residing at No: 10/19, VACHINAMPALAYAM, SIRUMUGAI-641 302. (HEREINAFTER CALLED THE PARTY OF THE THIRD PART) 4. Mrs.P.MAHESWARI, D/O,PALANISAMY, aged about 37 Years Residing at No: 6/224, MONGAMPALAYAM, THERAMPALAYAM- 641 697. (HEREINAFTER CALLED THE PARTY OF THE FOURTH PART)

3. N. Raj James Pi

4 K. Mahamasin.



Building Materials Conyany முக்கிரைத்தாள் விற்பனையாளர் 2-D. கோஆப்ரேடில் காலவி S.F.No. 677/1, Vellamadae E.B. ஆபிஸ் வீதி Combatone -64/110 மேட்டுபாணையம்-841 301 உரியம் எண்: 7323/B1/2008/18

WHERE AS the above parties have agreed to form a partnership from 22th day of April - 2019 and under the name and style

SRI RAJALAKSHMI SAMAPPA BUILDING MATERIALS COMPANY"

AND WHERE AS the parties mutually agreed to enter into partnership terms and Condition

TERMS AND CONDITIONS:

1. NAME OF THE FIRM:

The Name of the firm shall be "SRI RAJALAKSHMI SAMAPPA BUILDING MATERIALS COMPANY"

2. REGISTERED OFFICE OF THE FIRM:

The registered office of the firm shall be kept at S.F.No: 677/1,


VELLAMADAI, COMBATORE, TAMILNADU- 641 110.

The Partners may by mutual consent change the registered office of

the firm according to their convenience.

3 N. Rajuna

1. K. Mahaman

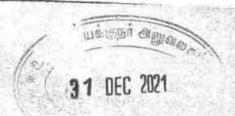

3. OBJECT OF THE FIRM:

The object of the firm is to carry on the business in Trading in all kinds of Building Materials, Production and Sales. They may commence any other business mutually agreed between the partners from time to time.

4. DURATION OF THE FIRM:

The duration of the firm shall be "AT WILL"

5. CAPITAL OF THE FIRM:

The capital of the firm shall be Rs.1,00,00,000/- (Rupees One Crore only) which shall be contributed by the partners under.

S.NO	NAME OF THE PARTNER	CAPITAL INVESTMENT
1.	S.GNANASEKARAN	Rs. 30, 00,000 /-
2.	S.PALANISAMY	Rs. 30, 00,000 /-
3.	M.RAJESHWARI	Rs. 30, 00,000 /-
4	P.MAHESWARI	Rs. 10, 00,000 /-
	TOTAL	Rs. 1,00,00,000 /-

If any further capital over and above these contributed capital be considered necessary by the partners, the same shall be the partners in the same ratio in which they contributed originally

1. Officer

4 K. Mahuman

3. N. PojMuan.

3 1 DEC 2021

9. MANAGING PARTNERS AND WORKING PARTNERS AND THEIR

The First Part of the Partner is Managing Partner and All partners have agreed to working partners actively devote their ting and attention to the business of the partnership, it is hereby agreed that in consideration of the party of the all Part actively devoting their time and attention to the business of partnership they shall be entitled to draw monthly salary and remuneration as under.

The monthly remuneration payable to each of partners for the each accounting year in the following the

(a)

In respect of the first
Rs 3, 00,000/- of the
Profit or in the
Case of loss
Rs. 12,500/- Each
Whichever is more

0,4

In respect of

Balance Profit

1.	S.GNANASEKARAN	27
2.	S.PALANISAMY	
3.	M.RAJESHWARI	27
4.	P.MAHESWARI	27
	TOTAL	9 9
		60

(6)

1. Quara

۵.

4 K. Machestrobii.

3. M. FSYLWART

ii) The partners shall be entitled to increase the above remuneration and may agree to pay remuneration to other partner or partners. The parties I : eto may also agree to revise the calculating the above remuneration and decide to pay salary and grant the benefit of the house rent allowance, rent free quarters, motor car or conveyance allowance, medical expenses accident and / or life insurance policy premium, Provident Fund, Gratuity, Be us, Commission on sale / gross receipts and / or other benefits to the above and / or the other partners either on monthly or yearly basis as they may agree

10. SHARE OF PROFIT / LOSS:

The Net Profit of the partnership husiness as per the accounts maintained by the partnership including rent / Salaries and other establishment expenses as well as interest and remuneration payable to the partners h accordance with this deed of partnership or any supplementary deed as in y be executed by the partners shall be divided and distributed among the

	S.GNANASEKARAN * *	
2.	S.PALANISAMY	30%
8.	M.RAJESHWARI	30%
4.		30%
	P.MAHESWARI	10%
	TOTAL	100 %

4 18. Nederal

16. PARTNERS INDIVIDUAL LIABILITY:

The firm shall in no way be liable to the individual debts, if any existing or fature of the partners. Each of the partners shall punctually pay and satisfy all the present and future private debts and engagement and indemnify the other of them and his I her representative and the properties and assets of the partnership there of and from all actions, Proceedings, damages, costs, charges and expenses on

17. DISPUTE OF THE FIRM:

In case any dispute arises between the partners the same shall be settling by referring the dispute to any third person agreeable to all the partners. 18. PARTNERSHIP ACT:

The provision of the Indian Partnership Act 1932, in so far as they are specifically mentioned here shall apply to the firm

IN WITNESS to agreeing the above terms and conditions of Partnership, we the partners Mentioned above do set our hands below in that presence of witnesses

WITNESSES

1. Company Calayon (Resonlabyon (Pa)
6/224- Mangam Palayon (Paromiabyon (Pa)
641617

Bileal (Bilealamous) 2. Slo. S. Butingagowder 5/56, somiverent Paloyen. Icaramadaia 641104

8 (Not CC. Ashok) Stor E. chinnaturai, 6/180, mographyn, Theran paloyam (P.O), Agalurdon, -646ps.

4. John (J. RANDITH)

4. Jo. N. JAKONATHAN, 30, A. ARRUMINA AVENUE, The winnipos sylven, Thursday or buildy.

X. (Consolidation of the consolidation of the conso

19 Part of the partner

2nd Part of the partner

M.RAJESHWARD

3rd Part of the Partner

X. K. Mahowasi. (P.MAHESHWARI)

4th Part of the Partner

ANNEXURE -1X Cell 93600 05261

SRI RAJALAKSHMI SAMAPPA BULL DING
MATERIALS COMPANY

11 DEC 2021

(1½ Metal, ½ Jally, ¾ Jally, Chips, M.Sand)
SF.No 677/1A Vellamadai, Coimbatore - 641 110
Email: srsbc2019@gmail.com

Date: .3 . 7 . 2021

ผู้ผิดภาพที่พัก เชื่อใกรเกาะสาเอิ สาแล้งงา เกิดงังตุกัน กายเลิดผล้ากัง เราะ ถึงจะกิบเล่า เรื่องกระ ระเบาะ 3-7-2021 Hairan เราะอัดบลล์ในเล่า Homonge มากับผลูกฎกเลเพล่า เมื่อที่อดีโดการแล้ง ผู้เลืองกับ ผู้กับกลาเอ เรื่อกๆ ผลเกุ่ๆบับเบลง.

ผิดขาพกัลท์ เรื่ ฏกระหน่าย เก่าๆข่า กุษณะผิงพัฒ ผินองพรศ Ami บกะ அฏินเอ ผิงมกก ผิรัฐอกร Hosel ผิดเดินอ ญฑัวอทบับพัมท์ Long ของ ผิงฏ ஆณฑพัวลหน่า องผิดพกบับเอ ผิงเอ Halang เอกราคม หน่องบอกพรศ มพัผิ รุกฏ กุลท ผิเรี, S- 53 กุลท & A ผิวอก อาลับ อเลิมผิ ผิเมิ அริโลกาเอ ฆะผูญัมบบผิดหา



ATTESTED


S.M. PRABHAKARAN, B.A.B.L.,
ADVOCATE & NOTARY PUBLIC
(GOVT, OF INDIA) EDT. No. 1849/92
28, REVATHY BUILDING
GOBAL APUDAM 2NU STREET,
COMPATIBLE - 841 018.
CGL: 8694- \$1171

Uniagnoism.

USINEW 2. Demy

Mahandi.



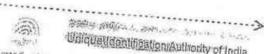



பெரியார் பல்கலைக்கழக ஆட்சிக்குழு 2010 ஆம் ஆண்டு ஏப்ரல் மாதம் நடந்த பயன்பாட்டுப்புவியமைப்பியல் தேர்வில் அரசு கலைக் கல்லூரி, சேலம் - 636 007 (தன்னாட்சி) பயின்ற P விஸ்வநாதன்

முதல் வகுப்பு A++ தரத்தில் தேர்ச்சி பெற்றார் என்று தக்க தேர்வாளர்கள் சான்றளித்தபடி **அறிவியல் நிறைஞர்** எ**ன்னும்** பட்டத்தை அவருக்குப் பல்கலைக்கழக இலச்சினையுடன் வழங்குகி**றது**.

The Syndicate of the Perigar University hereby makes known that

VISWANATHAN P

has been admitted to the DEGREE OF MASTER OF SCIENCE in

APPLIED GEOLOGY

he/she having been certified by duly appointed Examiners to be quinque to receive the same and was placed in the FIRST CLASS

WITH A++ GRADE at the Examination held in APR-2010 through GOVERNMENT ARTS COLLEGE, SALEM - 636 007 (AUTONOMOUS).



Dated 28-02-2011 சேலம் 636011, தமிழ்நாடு, இந்தியா. Salem 636011, Tamil Nadu, India. Given under the seal of this university

பதிவாளர் Registrar

துணைவேந்தர் Vice-Chancellor

ANNEXURE SAN

TIN. No.: 3312 2703755

C.S.T. No.: 880783 / 29.11.2005

Area Code: 142

S S S S S Ph. Mines: 0427 - 2403645 Fact: 0427 - 2400046

31 DEC 2021

SUDHARSHAAN MINING CORPORATION

Mfrs: Dead Burnt Magnesite, Lightly Calcined Magnesite, Dunite Chips & Powder. S.F. No. 77, Kuduvampatty Road, Vinayagampatti, SALEM - 636 008.

Date: 28.12.2015....

EXPERIENCE CERTIFICATE

This is to certify that Shri.P.Viswanathan, S/o. P.Paramasivam, Geologist, has worked in our Magnesite Mines from 13.09.2010 to 25.11.2015 as our company Geologist. During his service he used to maintain all records and returns submitted to Government Departments.

His nature of work in the mines was to show the plan of working and demarcate Magnesite reserve areas. He was looking after production of Magnesite and was maintaining quality of the Mineral as per the specifications given by the buyers.

During his tenor of his service he was very sincere and prompt in his duties.

I wish him the best of luck in all his future endevours.


For M/s. SUDHARSHAAN MINING CORPORATION,

SUDHARSHAN MINING CORPORATION

SF-77, KUDUVAMFATTI RÓAD, SALEM - 636 008. Tamilnadu. G.PASUPATHY, 28 Dec 2015

Proprietor

Resi : "Garuda" 14/315, Kaliyapillai Garden IInd Cross, Fairlands, Salem - 636 004. Tamilnadu.

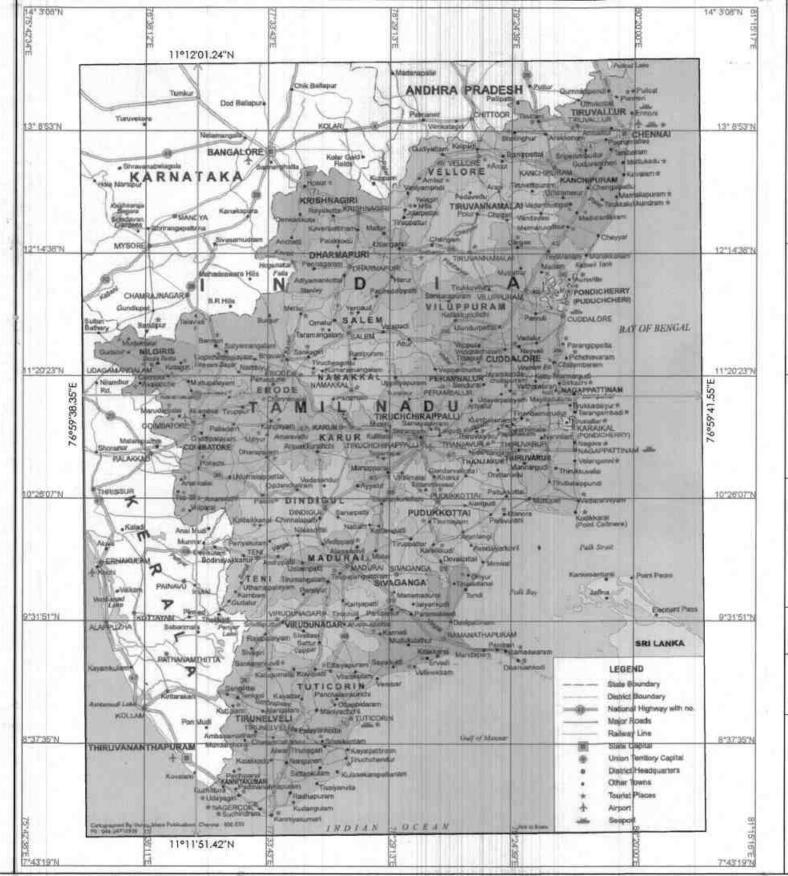



INDEX

Q.L.APPLIED AREA:



TOPO SHEET NO.: 58 - A/16

LATITUDE : 11°11'51.42"N to 11°12'01.24"N LONGITUDE : 76°59'38.35"E to 76°59'41.55"E

APPLICANT:



TVI. Sri. RAJALAKSHMI SAMAPPA BUILDING MATERIALS COMPANY, No. 677/ 1A, VELLAMADAI, COIMBATORE DISTRICT - 110.

LOCATION OF Q.L. APPLIED AREA:

\$.F.NO's : 1120/ 2 & 1121/ 2.

EXTENT : 2.60.5 Ha.
VILLAGE : BILICHI,

TALUK : COIMBATORE NORTH,

DISTRICT : COIMBATORE, STATE : TAMILNADU.

PLATE NO - I

DATE OF SURVEY: 08.12.2021

LOCATION PLAN

SCALE. 1:24,00,000


PREPARED BY:

THIS IS TO CERTIFY THAT THE INFORMATION IN THIS PLATE IS TRUE AND CORRECT TO THE BEST OF MY KNOWLEDGE BASED UPON THE LEASE MAP AUTHENTICATED BY STATE GOVERNMENT



*

11° 17' 26.62"N

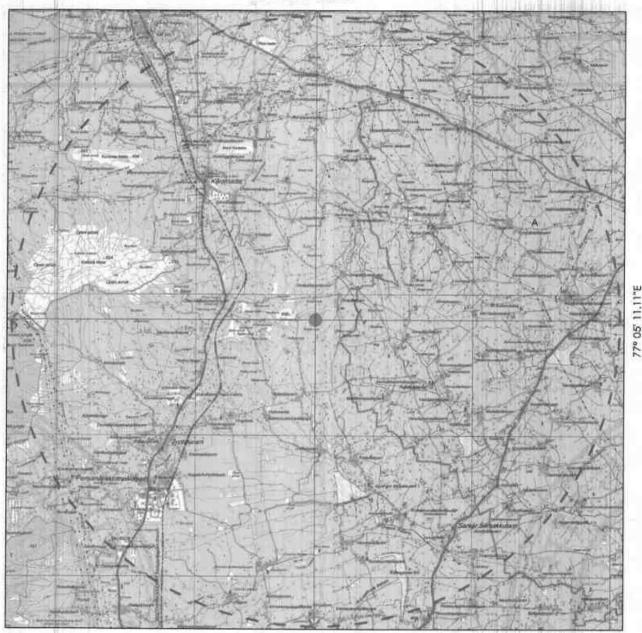

76° 54' 08.81"E

11° 06' 26.04"N

TOPO SHEET NO.: 58 - A/16

LATITUDE : 11°11'51.42"N to 11°12'01.24"N LONGITUDE : 76°59'38.35"E to 76°59'41.55"E

10km RADIUS

10

Q.L. APPLIED AREA



INDEX

Express highway: with toll; with bridge, with distance stone, Roads metalled: according to importance... Roads, double carriageway; according to importance... Unmetalled road. Cart-track. Pack-track with pass. Foot-path Streams: with track in bed: undefined. Canal. Dams; masonry or rock-filled; earthwork. Weir., River, dry with water channel, with island & rocks. Tidal river?... Submerged rocks, Shoel, Swamp, Reeds., Wells: lined; unlined. Tubewell. Spring. Tanks:perennial; dry... Embankments: road or rail; tank. Broken ground... Railways, broad gauge: double: single with station; under constru. Railways, other gauges: double; single with distance stone; do..... Mineral line or tramway. Kiin. Cutting with tunnel. Contours with sub-features, Rocky slopes, Cliffs. Sand features: (1)flat. (2)sand-hills(permanent). (3)dunes(shifting). Towns or Villages: Inhabited; deserted. Fort... Huts: permanent; temporary. Tower. Antiquities. Temple, Chhatri, Church, Mosque, Idgah, Tomb, Graves,.. Lighthouse. Lightship. Buoys: lighted; unlighted. Anchorage... Mine. Vine on trellis. Grass, Scrub., Palms: palmyra; other. Plantain. Conifer. Bamboo. Other trees... Areas: cultivated; Wooded. Surveyed trees... Boundary, international... Boundary, state: demarcated; undemarcated... Boundary, district, subdivision; tahsil or taluk; forest... Boundary pillers: surveyed; unlocated... Heights. triangulated: station: point; approximate. Bench-mark: geodetic; tertiary; canal Post office. Telegraph office. Overhead tank... Rest house or inspection bungalow. Circuit house. Police station.... Camping Ground. Forest: reserved; protected. Spaces names: administrative; locality or tribal. Hospital, Dispensary, Veterinary: Hospital/Dispensary, Aerodrome, Helipad, Tourist site... Powerline: with pylons surveyed; with poles unsurveyed...

Defrom

.200

BM 63-3 .mv₆5-7

APPLICANT:

TVI. Sri. RAJALAKSHMI SAMAPPA BUILDING MATERIALS COMPANY, No. 677/ 1A, VELLAMADAI, COIMBATORE DISTRICT - 110.

LOCATION OF Q.L. APPLIED AREA:

S.F.NO's : 1120/ 2 & 1121/ 2.

EXTENT : 2.60.5 Ha.
VILLAGE : BILICHI.

TALUK : COIMBATORE NORTH.

DISTRICT : COIMBATORE, STATE : TAMILNADU.

PLATE NO - I-A

DATE OF SURVEY: 08.12.2021

TOPO SKETCH OF QUARRY LEASE APPLIED AREA FOR 10Km RADIUS

SCALE. 1:1,00,000

PREPARED BY:

THIS IS TO CERTIFY THAT THE INFORMATION IN THIS PLATE IS TRUE AND CORRECT TO THE BEST OF MY KNOWLEDGE BASED UPON THE LEASE MAP AUTHENTICATED BY STATE GOVERNMENT

P.VISWANATHAN, M.Sc., QUALIFIED PERSON



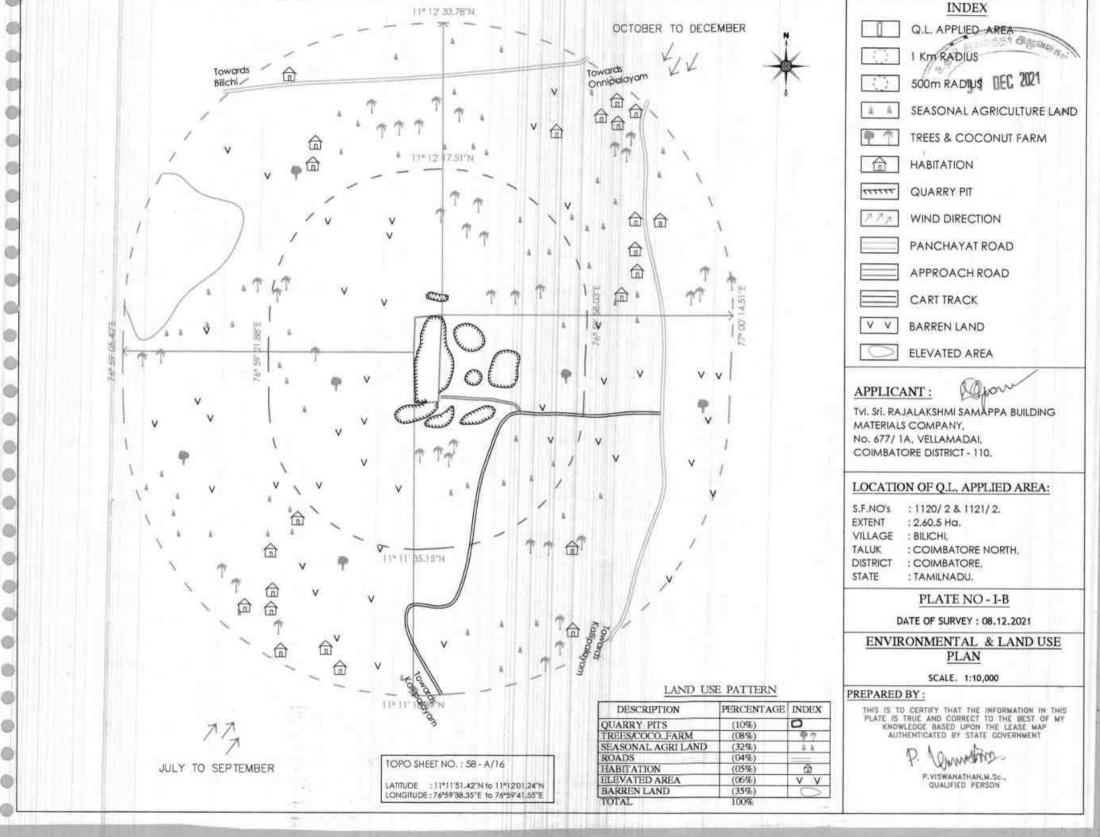


PLATE NO : I-C

ROUTE MAP

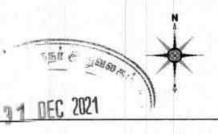

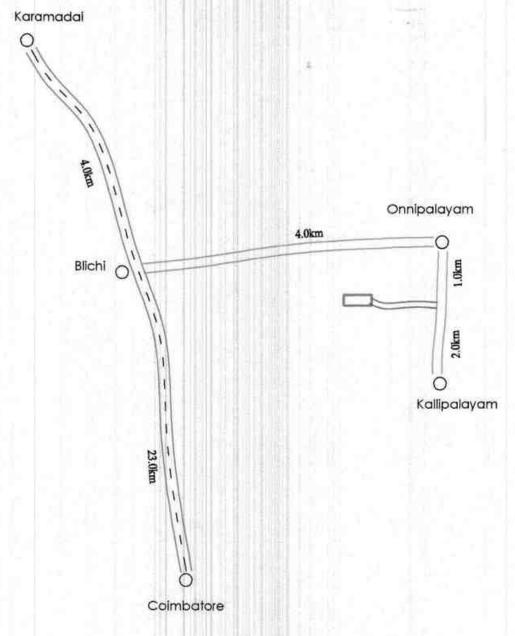

INDEX

LEASE APPLIED AREA

NATIONAL HIGHWAY

VILLAGE ROAD

APPROACH ROAD

APPLICANT:

TVI. Sri. RAJALAKSHMI SAMAPPA BUILDING MATERIALS COMPANY, No. 677/ 1A, VELLAMADAI, COIMBATORE DISTRICT - 110.

LOCATION OF Q.L. A. AREA:

S.F.NO's

: 1120/2 & 1121/2.

: COIMBATORE NORTH,

EXTENT

: 2.60.5 Ha.

VILLAGE

STATE

: BILICHI,

DISTRICT


: COIMBATORE, : TAMILNADU.

SCALE:


NOT TO SCALE

PREPARED BY:

THIS IS TO CERTIFY THAT THE INFORMATION IN THIS PLATE IS TRUE AND CORRECT TO THE BEST OF MY KNOWLEDGE BASED UPON THE LEASE MAP AUTHENTICATED BY STATE GOVERNMENT

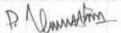

P.VISWANATHAN, M.Sc., QUALIFIED PERSON

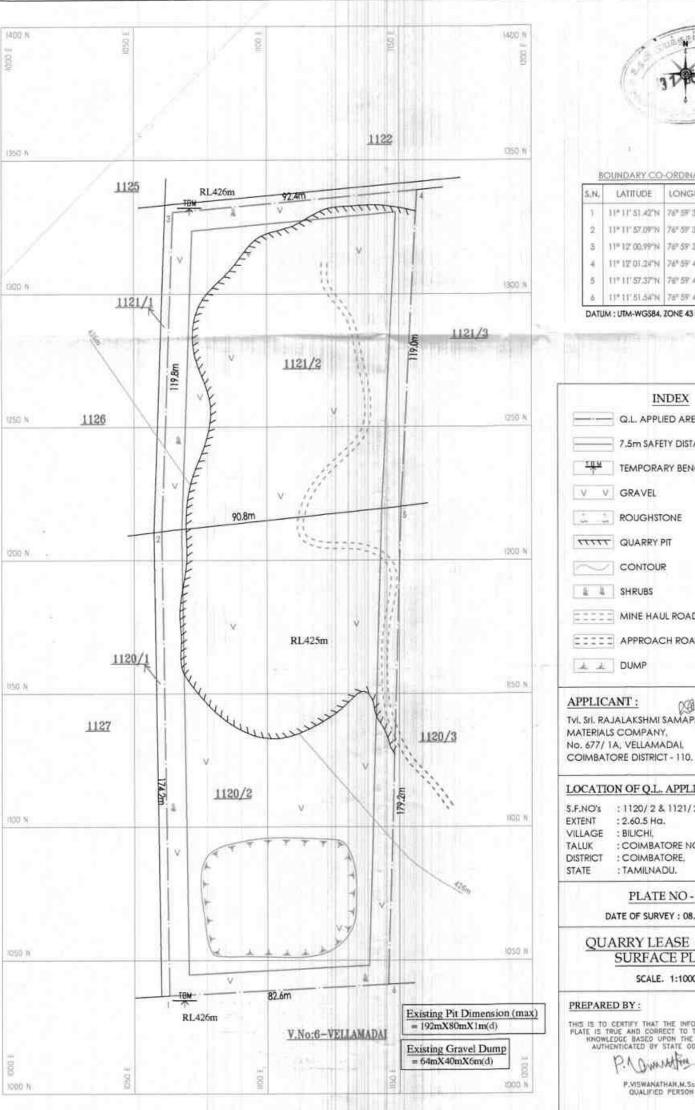



BOUNDARY CO-ORDINATES

S.N.	LATITUDE	LONGITUDE
3	11" 11" 51.42"N	76° 59' 38.41' E
2	11° 11° 57.09°N	76° 59' 38.35°E
3	11" 12' 00.99"N	76° 57' 38.52°E
4	11° 12' 01.24'N	76° 59' 41.55°E
5	11" 11" 57.37"N	76° 59' 41.33°E
à	11" 11" 51.54"N	76" 57" 41.12"E

DATUM: UTM-WGS84, ZONE 43 NORTH

INDEX

Q.L. APPLIED AREA BOUNDARY

7.5m SAFETY DISTANCE

TEMPORARY BENCH MARK

V GRAVEL

ROUGHSTONE

TTTTT QUARRY PIT

CONTOUR

SHRUBS

TITE MINE HAUL ROAD

IIII APPROACH ROAD

± ± DUMP

APPLICANT:

TVI. SIL RAJALAKSHMI SAMAPPA BUILDING MATERIALS COMPANY, No. 677/ TA, VELLAMADAL

LOCATION OF Q.L. APPLIED AREA:

: 1120/2 & 1121/2.

: 2.60.5 Ha.

: BILICHI,

: COIMBATORE NORTH,

: COIMBATORE,

: TAMILNADU.

PLATE NO - II

DATE OF SURVEY: 08.12.2021

QUARRY LEASE PLAN & SURFACE PLAN


SCALE. 1:1000


PREPARED BY:

THIS IS TO CERTIFY THAT THE INFORMATION IN THIS FLATE IS TRUE AND CORRECT TO THE BEST OF MY KNOWLEDGE BASED UPON THE LEASE MA!! AUTHENTICATED BY STATE GOVERNMENT



P.VISWANATHAN,M.Sc. QUALIFIED PERSON

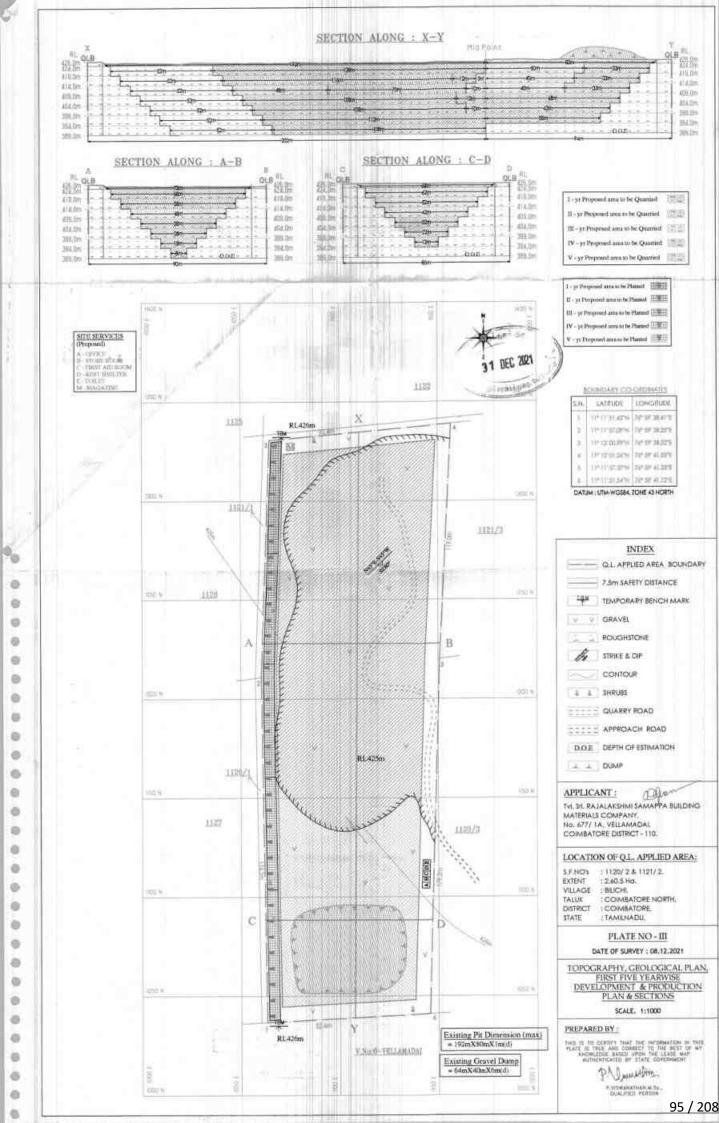

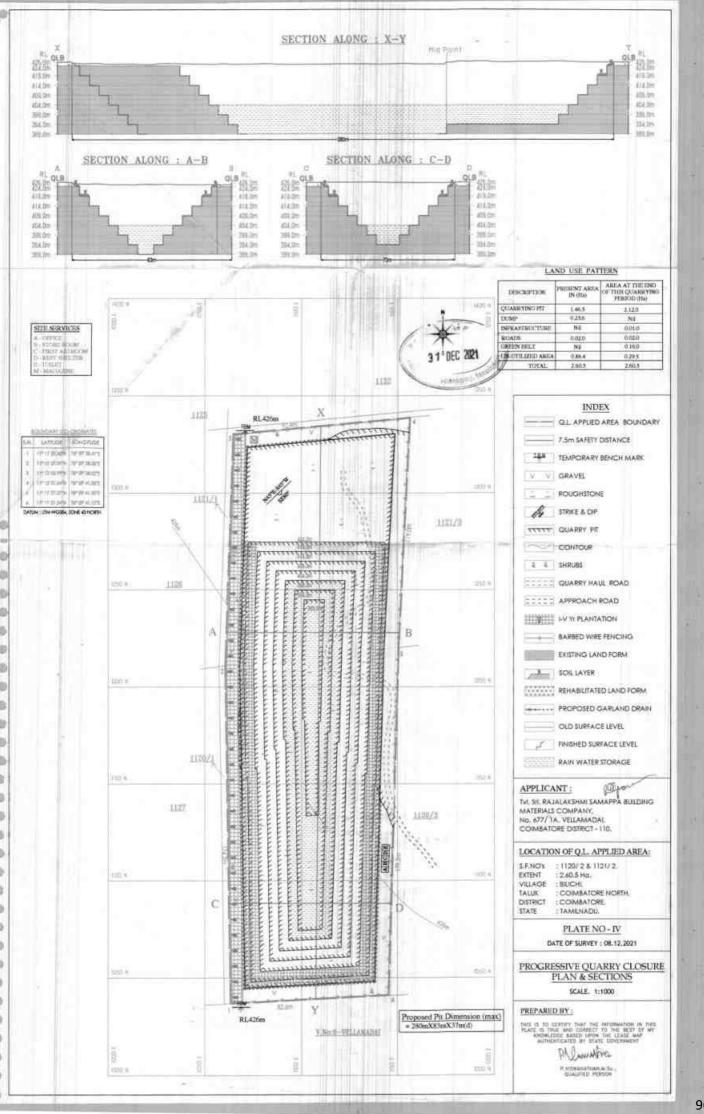





MINING PLAN FOR BILICHI (E-W) ROUGHSTONE AND GRAVEL QUARK

(PREPARED UNDER RULES 41 & 42 AS AMENDED IN TAMILNADU MINOR MINERAL CONCESSION RULES, 1959)

(Lease Period = Five Years)

IN

LOCATION OF THE QUARRY LEASE APPLIED AREA

EXTENT :

4.62.50ha

S.F.NOS

1119, 1120/4B & 1121/4B

VILLAGE :

BILICHI (E-W)

TALUK

COIMBATORE NORTH

DISTRICT :

COIMBATORE

STATE

TAMILNADU

FOR

APPLICANT

Thiru.P.Siddharthamouli,

S/o.Palanisamy,

No.2/246, Kannarpalayam,

Karamadai,

Coimbatore District.

PREPARED BY

Dr.P.Thangaraju, M.Sc., Ph.D.,

Qualified Person

Regd.off.No:17, Advaitha Ashram Road,

Alagapuram Post,

Salem - 636 004.

Cell: 94433 56539.

E-mail id: infogeoexploration@gmail.com

P.Siddharthamouli,

S/o.Palanisamy,

No.2/246, Kannarpalayam.

Karamadai,

Coimbatore District.



CONSENT LETTER FROM APPLICANT

The Mining Plan in Respect Roughstone and Gravel Quarry in S.F.Nos.1119, 1120/4B & 1121/4B over an extent of 4.62.50ha of Patta Land in Bilichi (E-W) Village, Coimbatore North Taluk, Coimbatore District, Tamilnadu State has been prepared by

Dr.P.Thangaraju, M.Sc., Ph.D.,

Qualified Person

I request to the District Collector, Coimbatore to make further correspondence regarding the modification of the Mining Plan with the said Qualified Person at his following address.

Dr.P.Thangaraju, M.Sc., Ph.D.,

Regd.off.No:17,

Advaitha Ashram Road.

Alagapuram Post,

Salem - 636 004.

Cell: 94433 56539, 94422 78601.

I hereby undertake that all the modifications, if any made in the Mining Plan by the Qualified Person may be deemed to have been made with my knowledge and consent and shall be acceptable to me and binding on me in all respects.

Signature of the Applicant

P.Siddharthamouli

Place: Coimbatore

Date: 07.03.2019

P.Siddharthamouli,

S/o.Palanisamy.

No.2/246, Kannarpalayam,

Karamadai.

Coimbatore District.



DECLARATION OF THE APPLICANT

The Mining Plan in Respect of Roughstone and Gravel Quarry in S.F.Nos.1119, 1120/4B & 1121/4B over an extent of 4.62.50ha of Patta Land in Bilichi (E-W) Village, Coimbatore North Taluk, Coimbatore District, Tamilnadu State has been prepared in full consultation with me.

I have understood its contents and agree to implement the same in accordance with Laws, Rules and Act applicable to Quarry.

Signature of the Applicant

P.Siddharthamouli

Place: Coimbatore

Date: 07.03.2019



CERTIFICATE

Certified that I, **Dr.P.THANGARAJU**, M.Sc., Ph.D., having at at Regd.off.No.17, Advaitha Ashram Road, Alagapuram, Salem – 636 004, am a Post Graduate in Geology (M.Sc.Geology) from Madras University, Chennai and I worked in the field of Geology in a role of Geologist.

Rule 15(I)(a) and (b) of Minerals (Other than Atomic, Hydro Carbons Energy Minerals) Concession Rules 2016 stipulates the eligibility for preparing Mining plans as "(I)(a) a post graduate degree in Geology granted by a university established" and (I)(b) "Professional experience of five years of working in a supervisory capacity in the field of mining after obtaining the degree". Since my qualification and experience are satisfied the Rule (I)(a) and (I)(b) of 15 of the said Rules, I am eligible to prepare Mining Plans for both Major and Minor Minerals.

Accordingly, I prepare this Mining Plan in respect of Roughstone and Gravel Quarry in S.F.Nos.1119, 1120/4B & 1121/4B over an extent of 4.62.50ha of Patta Land in Bilichi (E-W) Village, Coimbatore North Taluk, Coimbatore District, Tamilnadu State for **Thiru.P.Siddharthamouli**, S/o.Palanisamy, No.2/246, Kannarpalayam, Karamadai, Coimbatore District, Since the Mining Plan is prepared as per the provisions contained in Rule 15(I)(a) and (I)(b) of Minerals (Other than Atomic, Hydro Carbons Energy Minerals) Concession Rules, 2016.

Signature of the Qualified Person

Dr.P.Thangaraju, M.Sc., Ph.D.,

Place: Salem

Date: 09.03.2019

Dr.P.Thangaraju, M.Sc., Ph.D.,

Regd.off.No:17.

Advaitha Ashram Road.

Alagapuram Post,

Salem - 636 004.

Cell: 94433 56539, 94422 78601.



CERTIFICATE FROM THE QUALIFIED PERSON

This is to certify that the Provisions of Prepared under Rules 41 & 42 as Amended in Tamilnadu Minor Mineral Concession Rules, 1959. The preparation of Mining Plan for Roughstone and Gravel Quarry in S.F.Nos.1119, 1120/4B & 1121/4B over an extent of 4.62.50ha of Patta Land in Bilichi (E-W) Village, Coimbatore North Taluk, Coimbatore District, Tamilnadu State has been prepared for

Thiru.P.Siddharthamouli,

S/o.Palanisamy,

No.2/246, Kannarpalayam,

Karamadai,

Coimbatore District.

Whenever specific permissions/ exemptions/ relaxations and approvals are required, the Applicant will approach the concerned authorities of the District Collectorate, Coimbatore, Tamilnadu for such permissions/ exemptions/ relaxations and approvals.

It is also certified that information furnished in the above Mining plan are true and correct to the best of my knowledge.

Signature of the Qualified Person

Dr.P.Thangaraju, M.Sc., Ph.D.,

Place: Salem

Date: 09.03.2019

Dr.P.Thangaraju, M.Sc., Ph.D.,

Regd.off.No: 17,

Advaitha Ashram Road,

Alagapuram Post,

Salem - 636 004.

Cell: 94433 56539, 94422 78601.



CERTIFICATE FROM THE QUALIFIED PERSON

Certified that the Provisions of Mines Act, Rules and Regulations or Orders made there under have been observed in the preparation of Mining Plan for Roughstone and Gravel Quarry in S.F.Nos.1119, 1120/4B & 1121/4B over an extent of 4.62.50ha of Patta Land in Bilichi (E-W) Village, Coimbatore North Taluk, Coimbatore District, Tamilnadu State has been prepared for

Thiru.P.Siddharthamouli,

S/o.Palanisamy,

No.2/246, Kannarpalayam,

Karamadai.

Coimbatore District.

Whenever specific permissions/ exemptions/ relaxations and approvals are required, the Applicant will approach the concerned authorities of Director General of Mines Safety (DGMS), No.5, II Street, Block—AA, Anna Nagar, Chennai-40, Tamilnadu for such permissions/ exemptions/ relaxations and approvals.

It is also certified that information furnished in the mining plan are true and correct to the best of my knowledge.

Signature of the Qualified Person

Dr.P.Thangaraju, M.Sc., Ph.D.,

Place: Salem

Date: 09.03.2019



LIST OF CONTENTS

S.No.	Description	Page No.
1.0	Introduction and Executive summary	1
2.0	General Information	4
3.0	Location	5
	PART-A	
4.0	Geology and Mineral Reserves	7
5.0	Mining	10
6.0	Blasting	14
7.0	Mine Drainage	16
8.0	Other Permanent Structures	17
9.0	Employment Potential & Welfare Measures	19
	PART-B	,
10.0	Environment Management Plan	21
11.0	Mine Closure Plan	28
12.0	Any Other Details Intend to Furnish by the Applicant	30

2 9 MAR 2019

S.No.	Description	i sonsspon
1.	Copy of Precise Area Communication	T
2.	Copy of FMB	п
3.	Copy of Combined Map	111
4.	Copy of Patta	IV
5.	Copy of Adangal	v
6.	Copy of A-Register	VI
7.	Copy of Consent Document	VII
8.	Copy of ID Proof	VIII
9.	Copy of Qualified Person Certificate	IX

LIST OF PLATES

S.No	Description	Plate.No
1.	LOCATION PLAN	1
2.	TOPOSKETCH OF QUARRY LEASE AREA COVERING 10KM RADIUS	IA
3.	ENVIRONMENTAL PLAN	IB
4.	KEY PLAN	IC
5.	QUARRY LEASE & SURFACE PLAN	П
6.	TOPOGRAPHY, GEOLOGICAL PLAN & SECTIONS SHOWING YEARWISE DEVELOPMENT & PRODUCTION	ш
7.	CONCEPTUAL PLAN & SECTIONS	IV

Mining Plan



OVER AN EXTENT OF 4.62.50ha IN BILICHI (E-W) VILLAGE, COIMBATORE NORTH TALUK, COIMBATORE DISTRICT, TAMILNADU.

(Prepared Under Rules 41 & 42 as Per the Amended Under Tamilnadu Minor Mineral Concession Rules, 1959)

1.0 INTRODUCTION AND EXECUTIVE SUMMARY

The Mining Plan and Environment Management Plan is prepared for Thiru.P.Siddharthamouli, S/o.Palanisamy, No.2/246, Kannarpalayam, Karamadai, Coimbatore District has applied for Roughstone and Gravel Quarry in S.F.Nos.1119, 1120/4B & 1121/4B over an extent of 4.62.50ha of Patta land in Bilichi (E-W) Village, Coimbatore North Taluk of Coimbatore District as per Prepared under Rules of 41 & 42 as Amended in Tamilnadu Minor Mineral Concession Rules, 1959.

The application was processed by the District Collector, Coimbatore and passed a letter vide Rc.No.617/Mines/2018 Dated 07.03.2019 to submit Mining Plan for the approval in Department of Geology and Mining, Coimbatore to obtain Environment Clearance from the Appropriate Authorities, Tamilnadu.

In order to ensure compliance of the order of the Honourable supreme court dated 27.02.2012 in I.A.No.12.13.2011 in Special Leave Petition SLP (C) No.19628-19629/2009, now it has been decided that all mining projects of minor minerals including their renewal irrespective of sizes of the lease would hence forth require prior environment clearance for mining project within the lease area up to less than 100ha including projects or minor mineral with lease area less than 5ha would be treated as category B as defined in the EIA notification 2006 and will be considered by the State notified by MoEF as prescribed procedure under EIA notification 2006.

In the above circumstances the applicant through his consultant is hereby preparing the mining plan for approval and subsequent submission of Form-I and Pre feasibility report to obtain environment clearance from the Appropriate Authorities, Tamilnadu to Roughstone and Gravel quarry. This mining plan is prepared by considering the TNMMCR 1959 and as per the EIA Notification 2006 and its further amendments and judgments up to till 24.01.2019.

1



型的 专用的 西美国 四四、四年

Mining Plan

Short Notes of Mining plan

- a. Village Panchayat Bilichi (E-W)
- Panchayat Union Periyanayakkanpalayam
- c. The Geological Resources are 6,42,164m³ of Roughstone and 92,244m³ of Gravel formation in the entire area.
- d. The Total Mineable Reserves are 3,65,156m³ of Roughstone and 70,592m³ of Gravel formation in the entire area.
- e. The proposed quantity of reserves/ (level of production) to be mined and is about 2,82,076m³ of Roughstone for a period of five years and 70,592m³ of Gravel formation for a period of three years in the entire area.
- f. Total extent of the lease applied area is about 4.62.50ha.
- g. Topography of the area = The area exhibits slightly elevated topography
- h. Proposed Depth of mining = 22m below ground level
- Lease period = Five years
- It is a fresh application.
- Method of mining/ level of mechanization.

Opencast mechanized method, the quarry operation involves shallow jack hammer drilling, slurry blasting.

- Type of machineries proposed in the quarrying operation.
 - Excavators attached with rock breaker (Rental Basis).

Jackhammer, Compressor (Diesel drive) (4 jack hammer capacity).

- Mo trees will be uprooted due to this quarrying operation.
- n. The approach road from the main road to quarry will be constructed and maintained in a good condition for the haulage of Blue metals and machineries.
- There is no export of this Roughstone and Gravel.
- p. Topo sketch covering 10km and 1km radius around the proposed area with markings of habitations, water bodies including streams, rivers, roads, major structure like bridges, wells, archeological importance, places of worships is marked and enclosed as Plate No.IA and IB.
- q. The lease applied area is about 4.62.50ha bounded by nine corners; the corners are designated as 1-9 Clockwise from the Southwestern corner the Co ordinates for the all the corners are clearly marked in the Topography, Geological Plan and section enclosed as (Plate No-III).



2 9 MAR 2019

Mining Plan

Bilichi (E-W) Roughstone and Gravet Qua The plans of proposed quarrying area showing the dimensions of the pit, their proposed depth and maximum area of proposed quarrying are enclosed as Plate No.III.

- Eco Sensitive area is located at 9.2km from Western side of the lease applied area. S.
- General conditions will not be applicable for the proposed area. The area applied for lease is t. 10km away from the,
 - Interstate boundary.
 - ii) Protected area under wild life protection ACT 1972.
 - iii) Critically polluted areas as identified by CPCB,
- There are no wastages anticipated during this quarry operation, hence waste dump is not u. proposed in the lease applied area.
- Around 30 employees are deploying in the quarrying operation. ν.
- Total Cost of the project is about Rs.1,13,17,563/-. w.

Bilichi (E-W) Roughstone and Gravel Quarry

2.0 GENERAL INFORMATION

2.1 a) Name of the Applicant : Thiru.P.Siddharthamouli,

b) Address of the Applicant (With Phone No and Aadhaar Number)

Address

S/o.Palanisamy,

No.2/246, Kannarpalayam,

Karamadai.

Coimbatore District.

Pin code

641 104

Mobile No

97867 96039 & 98422 04259

Aadhaar Number

5445 8330 7612

c) Status of the Applicant (Individual/ Company/ Firm).

The applicant is an individual.

2.2 a) Mineral which the Applicant intends to mine.

The Applicant intends to quarry Roughstone and Gravel only.

 Precise area communication letter details received from the competent authority of the Government.

The precise area communication letter was received from the District Collector, Coimbatore vide R.c.No.617/Mines/2018 Dated 07.03.2019 to obtain approved mining plan and obtain Environment Clearance from the Appropriate Authorities, Tamilnadu.

c) Period of permission/ lease to be granted.

The applicant applied permission to quarry Roughstone and Gravel for the period of Five years/ The District Collector considered for the Grant of quarry lease for the period of Five years for Roughstone and Three years for Gravel.

2 9 MAR 2019

Mining Plan

Bilichi (E-W) Roughstone and Gravel Quarry

d) Name and address of the Qualified Person preparing the mining plan.

Name

Dr.P. Thangaraju, M.Sc., Ph.D.,

Address

Regd.off.No.17,

Advaitha Ashram Road,

Alagapuram, Salem - 636 004.

Mobile

94433 56539

Tele Fax

0427-2431989

Email

infogeoexploration@gmail.com

3.0 LOCATION

a) Details of the area with location map

The lease applied area is about 21.0km Northeastern side of Coimbatore and 3.0km from Southeastern side of Bilichi (E-W) Village.

Coimbatore

21.0km

Bilichi (E-W)


Northeast

3.0km

Lease applied area
Southeast

Bilichi (E-W) Roughstone and Gravel Quarts

Mining Plan

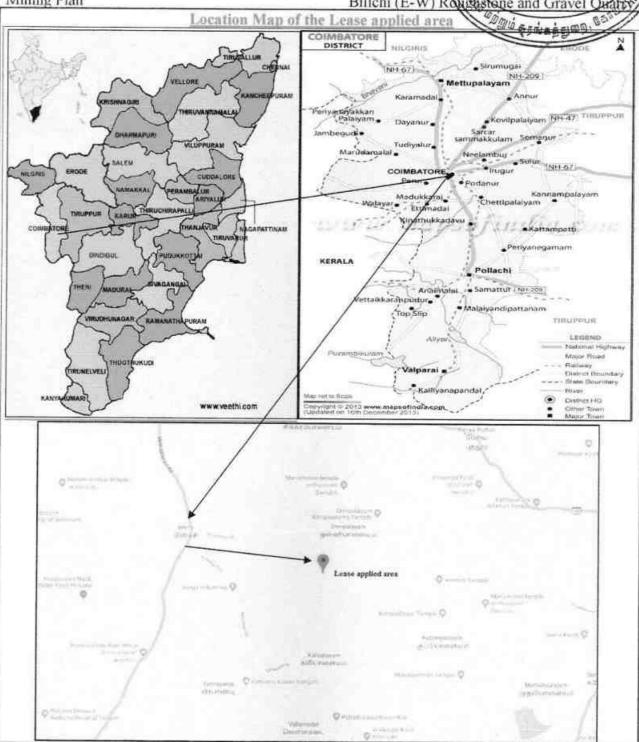

TTATE	T77	78
TARI	PH -	

District	Taluk	Village	S.F.Nos	Lease applied area in ha
Coimbatore	Coimbatore North	Bilichi (E-W)	1119	3.36,50
			1120/4B	0.77.50
			1121/4B	0.48.50
	Total Ex	tent		4.62.50ha

Mining Plan Bilichi (E-W) Roughston and Gravel Quarr

b) Classification of the area (Ryotwari/ Poramboke/ others).

It is a Patta Land (Barren land) which is not fit for vegetation/ Cylin vation

Ownership/ Occupancy of the applied area (surface right).

It is a Patta land, Jointly Registered the S.F.Nos.1120/4B & Name of Application (Thiru.P.Siddharthamouli) & Srikanth vide Patta Nos.3134 & 3133 another of Chandira and Javalakshmi vide Patta No.3289. The applicant has been consent from Joint Pattadhars. (Refer the Patta copy as Annexure No.IV & Consent Document as Annexure No.VII)

2 9 MAR 2019

d) Toposhect No. with latitude and longitude.

The lease area falls in the Toposheet No.58-A/16 Latitude between 11°11'51.83"N to 11°11'01.78"N and Longitude between 76°59'44.32"E to 76°59'54.24"E on WGS datum-1984. Refer the Plate No.1 & II).

Existence of public road/ Railway line, if any nearby and approximate distance.

The metal road is situated on the Eastern side of the applied area which connects the village road at a distance 370m.

Multiple road access is available from the quarry to state highways and National Highway, no villages are enrooted hence the traffic density is not much more due to the transportation of Roughstone

The same road will be maintained and utilized for haulage, besides trees will be planted on the either side of the road to prevent dust and noise propagation to the nearby areas.

The Nearest Railway line is Coimbatore - Ooty line which is about 2.8km on the Northwestern side of the area.

PART - A

4.0 GEOLOGY AND MINERAL RESERVES.

4.1 Brief description of the Topography and general Geology of the area (with plans).

The lease applied area is exhibits slightly elevated topography. The area has gentle sloping towards Northeastern side. The altitude of the area is 420m (Max) above Mean sea level. The area is covered by the Gravel which is about 2.0m thickness. Massive Granitic Gneiss is found after 2.0m (Gravel) which is clearly inferred from the nearby existing quarry pits.

The Water level in the surrounding area is 55-50m below general ground profile which is observed from the nearby bore wells. Average annual rainfall is about 709mm during the monsoon.

7

Topographical View of lease applied area

Peninsular gneiss forms the oldest rock formations, in which the massive formation of Granitic Gneiss lies over with rich accumulation of recent quaternary formation. On regional scale the Granitic Gneiss body N30°E to S30°W with dipping SE60°.

The general geological sequences of the rocks in this area are given below

AGE		FORMATION
Recent	~	Quaternary weathered
		Formation (Gravel)
	U1	nconformity
Archaean	-	Granitic Gneiss
		Peninsular Gneiss comple

4.2 Details of exploration already carried out if any

State Geology and Mining Dept, Govt. of Tamilnadu, has carried out the Regional prospecting and exploration in these areas during 1992 to 1993.

Geological Survey of India has carried out detailed mapping in Coimbatore District. Besides, the Qualified Person and his team members made a detailed geological of the proposed area. The Roughstone formation is clearly inferred from the nearby existing quarry pits.

4.3 Estimation of Reserves

Geological reserves with geological sections on a scale of 1:1000/1:2000.

As far as Roughstone is concerned, the only practical method is the systematic geological mapping and delineation of Roughstone within the field and careful evaluation of body luster, physical properties, engineering properties, commercial aspects etc.,

Bilichi (E-V

Totally six sections have been drawn, two sections are drawn Length wise as (X-Y) and X1-Y1) and another four sections are drawn Width wise as (A-B), (E4 SatMAL) 2019 o case the maximum area considered for lease. The Topographical, Geological and sections seated the commercial marketable Roughstone deposit has been prepared in 1 1000 scale (Refer the Geological plan and sections Plate No-III. The sale of Roughstone is in terms of cubic meters (Volume) and not in terms of tonnage.

Geological Resources (Plate No.III)

The Geological Resources of Roughstone and Gravel are calculated up to a maximum depth of 22m below ground level.

-TABLE-2

			GEOLOG	ICAL RI	SOURCES	
Section	Bench	Length in (m)	Width in (m)	Depth in (m)	Geological Resources in Rough stone (m ³)	Gravel formation (m ³)
	1	41	119	2		9758
	11	41	119	2	9758	
201 10	111	41	119	5	24395	
AY-AB	XY-AB		24395			
		5	24395			
		To	tal		82943	9758
	1	105	171	2		35910
	1.1	68	113	4	30736	
	111	105	171	5	89775	+.
X1Y1-CD	IV	105	171	5	89775	
	V	105	171	5	89775	
	Total				300061	35910
		70	146	2		20440
	111	45	146	4	26280	
XIYI-EF	IV	70	146	5	51100	
	V	7.0	146	- 5	51100	*
		То	tal		128480	20440
	1	108	121	2 -	-	26136
	IV	108	121	5	65340	
XIYI-GH	V	108	121	- 5	65340	
			tal		130680	26136
	G	and Total			642164	92244

The Geological Resources of Roughstone = 6,42,164m³

The Geological Resources of Gravel = 92,244m³



Mineable Reserves:

The Mineable reserves are calculated by deducting 7.5m safety distance maintained by adjacent Patta land, 10m safety distance maintained by Cart track & Odai and bench locked up Reserves.

TABLE-3 MINEABLE RESERVES Gravel Mineable Reserves Length Width Depth Bench Section formation (m³) in Rough stone (m3) in (m) in (m) in (m) H XY-AB Ш Total I Ш X1Y1-CD IV V Total III X1Y1-EF IV V Total I IV XIY1-GH

The available mineable reserves have been computed as 3,65,156m³ of Roughstone and 70,592m³ of Gravel formation at the rate of 100% recovery upto a maximum depth of 22m below ground level for a mining period of Five years.

5.0 MINING

5.1 Method of mining (opencast/ underground).

Grand Total

Total

Open cast Mechanized Mining is being carried out with 5.0 meter vertical bench and a bench width not less than the bench height.

However, as far as the quarrying of Roughstone is concerned, observance of the provisions of Regulation 106 (2) (b) as above is seldom possible due to various inherent petro genetic factors coupled with mining difficulties. Hence it is proposed to obtain relaxation to the provisions of the above regulation from the Director of Mines Safety for which necessary provision is available with the Regulation 106 (2) (b) of MMR-1961, under Mine Act - 1952.

Bilichi (E-W) Granstone and Oka

5.2 Mode of working (mechanized, manual).

The Roughstone is proposed to quarry at 5m bench height which and Mark 2019 and Proposed to Roughstone is proposed to quarry at 5m bench height which and Mark 2019 and Proposed to quarry operation involves shallow jack had been dealling shurt with the Blasting. Excavation, Loading and Transportation of Roughstone to the next the state of the

The production of Roughstone in this quarry involves the following method which is typical for Roughstone quarrying in contrast to other major mineral mining

Splitting of rock mass of considerable volume from the parent rock mass by jackhammer drilling and blasting, hydraulic excavators are used for loading the Roughstone from pithead to the needy crushers.

Occasionally hydraulic excavators are attached with rock breakers for fragmentation to avoid secondary blasting. The primary boulders thus splitted are removed from the pits by excavators and further made to smaller sizes by rock breakers attached in excavators. It is a conventional opencast mechanized method of mining.

5.3 Proposed Bench Height and Width.

The Granitic Gneiss is hard and compact rock, the bench height is proposed 5.0 meter vertical bench the width of the bench is not less than the Height.

5.4 Indicate the overburden/mineral production expected pit wise as detailed below (composite plan and section showing pit layout, dumps, disposal of waste if any etc.)

The overburden in the form of Gravel formation, the Gravel will be directly loaded into tipper for the filling and levelling of low lying areas, this will be done only after obtaining permission and paying necessary seigniorage fees to the Government. The excavated Roughstone will be directly loaded into tipper to the needy customers. The Composite plan. Development plan and section indicating the Pit lay out, Green belt development are shown in Plate No-III.

2 9 MAR 2019

Mining Plan

Bilichi (E-W) Roughstone and Gravel Quan Year wise development and Production

TABLE-4

		YEAD	RWISE PE	RODUCAT	TON DET	AILS	
Year	Section	Bench	Length in (m)	Width in (m)	Depth in (m)	Recoverable Reserves in Rough stone (m³)	Gravel formation (m³)
		1	84	104	2		17472
1st Year		IV	77	98	5	37730	3
	X1Y1-GH	V	38	87	5	16530	-
		Total				54260	17472
		1V	4	98	5	1960	
		1	70	129	2		18060
2nd Year	XIYI-EF	III	41	125	4	20500	-
		IV	61	118	5	35990	d.
		Total			58450	18060	
		Ш	4	125	4	2000	
	X1Y1-CD XY-AB	1	97	154	2		29876
		11	56	103	4	23072	2
3rd Year		111	40	138	5	27600	4
ord rear		1	24	108	2		5184
		11	18	104	2	3744	
		Ш	8	99	5	3960	
			Total			60376	35060
		III	49	138	5	33810	-
4th Year	XIYI-CD	IV	33	127	5	20955	
	ATTIFED		To	tal		54765	
		IV	51	127	5	32385	
5th Year	X1Y1-EF	IV	9	118	-5	5310	
om rear	X1Y1-GH	V	38	87	5	16530	
	ATTI-UII		To	tal		54225	
		Grand T	otal			282076	70592

The Recoverable reserves have been computed as 2,82,076m³ of Roughstone for a period of five years and 70,592m³ of Gravel formation for a period of three years at the rate of 100% recovery upto a maximum depth of 22m below ground level.

The applicant ensures the total quantity proposed in the benches will not exceed during the Quarrying operation. Besides the Roughstone locked up in benches will be exploited after obtaining necessary permission from the office of **Director General of Mine Safety**, Chennai region by submitting relevant documents, appropriate safety plans and its Mitigation measures.

2 9 MAR 2019

Mining Plan

Bilichi (E-W) Roughstone and Gravel Quarr

One lorry load

Total No of Working days

Total quantity to be removed in this five years plan period = 2.82.076m³

Harmon war Harmon Lands and Lands Lands

Hence total lorry loads per day

260 Days per year

approx 1. 6

2,82,076m³/6m³

= 47013Lorry loads

= 47013/5 years

= 9403/260 Days

36 Lorry loads per day.

Working hours = 8.00 am to 6.00 pm (with 1-2 pm lunch break)

5.5 Machineries to be used for Mining

The following machineries are utilized on rental basis for the development and production work at this quarry.

TABLE - 5

I. <u>DRILLING MACHINE</u>

S.No.	Туре	Nos	Dia Hole mm	Size Capacity	Motive power
1	Jack hammer	8	30-35	1.2m to 2m	Compressed air
2	Compressor	2	*	400 psi	Diesel Drive

II. EXCAVATION AND LOADING EQUIPMENT

S.No.	Type	Nos	Capacity	Motive Power
1	Excavator with Bucket and Rock Breaker	2	300	Diesel Drive

III. HAULAGE WITHIN THE MINE & TRANSPORT EQUIPMENT

S.No.	Type	Nos	Capacity	Motive Power
ī	Tippers	3	20 Tonnes	Diesel Drive

5.6 Disposal of Overburden/Waste

The overburden in the form of Gravel formation, the Gravel will be directly loaded into tippers for the filling and levelling of low lying areas. There is no disposal of Gravel. The excavated Roughstone will be directly loaded into tipper to the needy customers.

Bilichi (E-W) Registone and Grasel Quarry

5.7 Brief note on conceptual mining plan for the entire lease period Phase on the geological, mining and environment considerations.

Conceptual mining plan is prepared with an object of long term systematic development of benches, layouts, selection of permanent structures, depth of quarrying and ultimate pit dimensions, selection of sites for construction of infrastructure, etc.,

The ultimate pit size is designed Phased on certain practical parameters such as economical depth of mining, safety zones, permissible area, etc.,

As the applicant has applied quarry lease for Five years, the ultimate pit limit (dimension) at the end of this mining plan period is given below.

TABLE-6

Description	Length (Max) (m)	Width (Max) (m)	Depth (Max) (m)
Conceptual	251m	154m	22m from below ground level

Greenbelt has proposed on the 7.5m & 10m safety barrier and Panchayat roads by planting Neem/ Casuarina trees of native species. All the base line information studies like Air quality monitoring, Noise and vibration monitoring, Water analysis studies will be carried out every year as per the MoEF&CC Norms. Please refer Plate No. III & IV. It is propose to engage any local institution to monitor the EIA and EMP during the course of quarrying operation after the grant of quarry lease.

6.0 BLASTING

6.1 Blasting patterns

The quarrying operation is proposed to carried out by Opencast Mechanized Method in conjunction with conventional method of mining using Jack hammer drilling and blasting for shattering effect and loosen the Roughstone.

Drilling and blasting parameters are as follows:

Depth of Each hole : 1.5m

Diameter of hole : 30-32mm

Spacing between holes : 1.2m

Burden for hole : 1.0m

Pattern of hole : Zigzag – Multi-rows

Inclination of holes : 80° from horizontal


Use of delay detonators : 25millisecond relays

Detonating fuse : "Detonating" Cord

2 9 MAR Zu is
Rugastone and Gravel Quarry

Mining Plan

Bilichi (E-W) Roughstone and

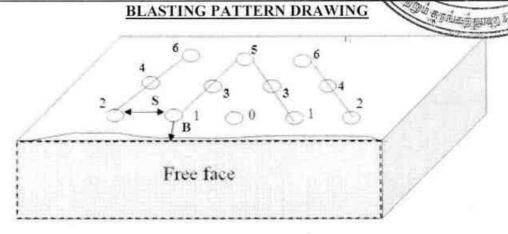

Staggered "V" Pattern of Blasting Design

Spacing = 1.2m

Burden = 1.0m

Depth of the hole = 1.5m

No of holes proposed per day= 188Holes

6.2 Type of explosives to be used

Small Dia.25mm Slurry explosives are proposed to be used for shattering and heaving effect for removal and winning of Roughstone. No deep hole drilling and primary blasting are proposed.

6.3 Measures proposed to minimize ground vibration due to blasting

Shallow depth jackhammer drilling & blasting are proposed to be quarry with minimum use of explosives mainly to give shattering effect in Roughstone for easy excavation and control fly rock.

Delay detonators

Delay blasting (millisecond delays) permits to divide the shot in to smaller charges, which are detonated in a predetermined millisecond sequence at specific time intervals.

The major advantages of delay blasting are

- · Reduction of ground vibration.
- Reduction in air blast.
- · Reduction in over break.
- Improved fragmentation.
- Better control of fly-rocks.

15

Bilichi (E-W-Roughs Sheund Cravel Quarry

Blasting program for the production per day:

No of Holes = 188Holes

Yield = 564Tons

Powder factor = 6tons/Kg of explosives

Total explosive required = 94Kg- Slurry explosives

Charge hole = 0.5Kg

Blasted at day time only = 5-6p.m (whenever required).

6.4 Storage and safety measures to be taken while blasting

The applicant has authorized explosive agency to carry out the small amount of blasting and it is being supervised by competent and statutory foreman. The explosives agencies should have the valid Blaster certificate. He will blast holes in the quarry site. After the completion of Blasting, the explosives Agencies will take it out back the remaining quantity of Explosives. The magazine is available at the quarry site to temporarily store the explosives.

7.0 MINE DRAINAGE

7.1 Depth of water table (Phased on nearby wells and water bodies).

The water table in the area is about 55m BGL in summer season and 50m in Ramy season which is observed from the nearby wells and the data obtained from existing private boreholes. The lease area is fully covered by Massive Granitic Gneiss formation and it is revealed from the adjacent quarries. Hence the Ground Water problem will not arise. If water seepage may occur due to the fracture, the same will be used for Greenbelt.

TABLE -7

Type	Distance & Direction	Location
Open well	300m Western side	11°11'54.93"N 76°59'34.44"E

7.2 Arrangements and places where the mine water is finally proposed to be discharged.

The Quarry operations are confined above the water table during the entire lease period. If water is encountered due to rain water seepage, the same will be pumped out by 5HP water pumps to facilitate the Green belt development areas. Besides, the water will also be used for dust suppression on haul roads during Haulage of machineries.



Bilichi (E-W Roughstone and Gravel Oparry

8.0 OTHER PERMANENT STRUCTURES (also shown in the map) The company

8.1 Habitations/ Villages Natham.

There is no approved habitation within 300m radius from the periphery of the lease applied area.

8.2 Power Lines (HT/LT).

An abandoned LT Line is located on the Northeastern side. No electricity supply for this line then LT line will be shifted before the lease execution.

8.3 Water bodies (river, pond, lake, odai, canal, etc.,).

10m safety distance maintained by Odai from Eastern side of the lease applied area.

8.4 Archaeological/ historical monuments.

There is no Archaeological/ historical monuments within 500m radius from the lease applied area.

8.5 Road (NH, SH others).

The Nearest National Highway (NH-67) Coimbatore – Ooty which is about 3.0km from the Western side of the lease applied area.

The State Highway (SH-168) Karamadai – Annur which is about 4.0km from the Northeastern side of the lease applied area.

8.6 Places of worships.

There is no place of worships within the radius of 500m from the lease applied area.

8.7 Reserved forest/ forest/ social forest/ wild life sanctuary etc.

There is no Reserve forest/forest/social forest/ wildlife sanctuary within 500m radius of the lease applied area.

2 9 MAR 2019

Bilichi (E-W) Rönglistone and Gravel Ovarry

n

S. No	Salient Futures Present around site	Prescribed safety distance		Actual Dista	nce from the site		
1.,,	Railways, Highways, Reservoirs or Canal	50m	Railway line – 2.8km (Coimbatore – Ooty)Northwesterside. Highways - (NH-67) Coimbatore – Ooty which is about 3.0km from the Northwestern side of the lease appliturea. River – River is passing about 3km from the Northwestern side and Gowsika River is passing 6.5km from Southeastern side of the lease applied area. Canal – No Canal within 1.0km radius. Reservoir – No Reservoir within 10.0km radius.				
2.	Village Road	10m	Village ro	ad is 370m from	the Eastern side of	the area.	
3.	Habitation/ Village	300m	There is no approved habitation within 300m from the periphery of the lease applied area. A distance is clearly marked in the Plate No.I-B.				
			S.No Na	me of the Village	Approximate Direction fr applied	om lease	
			1. Or	inipalayam	1.0km		
				ngalipalayam	2.5km		
				lipalayam	2.0km -	The state of the s	
w	100 at 100 000 000 at 100 000 at			ichi	3.5km	-NW	
4.	Adjacent Land	7.5m	East - S South - V West - S	F.No.1121/1 & 1 .F.No.1112 & 11 /illage No.6 Vella .F.No.1120/4A & y distance mainta	11 amadai	Patta lands.	
5.	Power House, EB line (HT & LT Line)	50m	radius from	n the periphery o — An abandoned ern side. No elect	bitation within of f the lease applied I LT Line is local tricity supply for the the lease execution.	area. ited on the nis line. LT	
6.	Boundaries of the	7.5m &	The bound	laries of the perm	itted areas is as fo	llows:	
MSK	permitted area	10m	Direction	S.F.Nos	Classification	Safety Distance	
			North	1121/1 & 1118/1	Patta Land	7.5m	
			East	1112 & 1111	Patta Land/Odai	10m	
			South	Village No.6 Vellamadai	Patta Land	7.5m	
			West	1120/4A & 1121/4A	Patta Land	7.5m	

2 9 MAR 2019

ACRES NOTES	The second	
Mining	Plan	

MIII	ning Pian	Billeni (E-W) Regignstene and Grave Louary		
7.	Reserve forest	50m	There is no reserve forest within 50m radius of the lease applied area.	
8.	Protected area / ECO sensitive area/Wild	10km	Eco Sensitive area is located at 9.2km from Western side of the lease applied area.	

9.0 EMPLOYMENT POTENTIAL & WELFARE MEASURES

9.1 Employment potential (skilled, semi skilled, un skilled)

The following manpower's are proposed in the mining plan to carry out the day-to-day quarrying activities, the same employment is maintaining aimed at the proposed production target and also to comply with the statutory provisions of the Metalliferous mines regulations, 1961.

Skilled labour

Mine Foreman : 1

Blaster/mate : 1

Excavator – Operator & Driver : 5

Jack hammer operator : 16

b. Semi-skilled

Watchman : 1

c. Unskilled

Labour & Helper : 3 Cleaner : 3

Total : 30

Allowing 10% absenteeism the man power would be around 27, the above manpower is adequate to meet out the production schedule and the machinery strength envisaged in the mining plan and to comply with the statutory provisions of the Mines Safety Regulations. It is been ensured that the labor will not be employed less than 18 years, **No child labour** will engaged or entertained for any kind of quarrying operations. All the labors engaged for quarrying operations will be insured during the quarry lease period.

9.2 Welfare Measures

a) Drinking Water

Packaged drinking water is available from the nearby approved water vendors in Onnipalayam which is about 1.0km from the Northeastern side of the area. Drinking water shall be readily available at conveniently accessible points during the whole of the working shift.

b) Sanitary Facilities

Hygienic modern sanitary facilities will be constructed with in the safety barriers of lease applied area as semi permanent structure and it will be maintained periodically.

2 9 MAR 2019
Bilichi (E-W) Romanstone and Gravel Quarry

Mining Plan

First aid facility

First aid kits are kept in Mines office room, in case of such eventuality is the victim will be given first aid immediately at the site and injured person will be taken to the hospital. Hospital is available at distance of 5.5km Northwestern side in Karamadai by a vehicle earmarked for the purpose the competent and statutory foreman/permit manager/mate will be in charge of first aid.

d) Labour Health

Periodically medical check up related to occupational health safety will be conducted to all the workers in Applicant own cost.

e) Precautionary safety measures to the labourers





- Helmets,
- Mine Goggles,
- Ear plugs,
- Ear muffs,
- Dust mask,
- Reflector jackets
- Safety Shoes

As personal protective device as per the specification approved by Director of mines safety. Periodically medical check-up will be conducted for all workers for any mine health related problems. Proper training and vocational education will be given by qualified and experienced safety officer to all the employees about the safety and systematic Roughstone quarrying operations. The drillers and workers will be sent for vocational training periodically, to carry out the quarrying operations scientifically and to safe guard the men & machinery and to create awareness about conventional opencast quarrying operations.



Bilichi (E-W) Rengistone, and Gravel Quarry PART – B

10.0 ENVIRONMENT MANAGEMENT PLAN

10.1 Existing Land use pattern

The quarry lease applied area is exhibits slightly elevated topography. The area is a dry barren land devoid of Agriculture and Habitations. The land is not used for any specific vegetation.

LAND USE TABLE-8

Description	Present area in (ha)	Area at the end of this Quarrying period (ha)
Quarrying Pit	Nil	3.71.8
Infrastructure	Nil	0.03.0
Roads	Nil	0.05.0
Green Belt	Nil	0.42.4
Unutilized Area	4.62.5	0.40.3
Grand Total	4.62.5	4.62.5

10.2 Water Regime

It is a simple opencast quarry operation. The quality of water will not be affected due to this quarrying operation. However, mitigation measures will be carried out like Garland drains constructed on all sides of quarry pit to avoid rain water entering into the pit.

The waste water discharged to water bodies will be met the standard prescribed under the Environment (Protection) Act – 1986 by The Ministry of Environment, Forest and Climatic change.

2 9 MAR 2019 *
Bilichi (E-W) Roughstone and Gravel Quarry

Mining Plan

10.3 Flora and Fauna:

TABLE-9

		List of	Flora		
S.No	Name of the plant (Scientific)	Family Name	Common Name	Habit	Picture
1,	Calotropis igantean	Asclepiadaceae	Crown Flower, Erukku	Shrub	
2.	Borassus flabellifera	Arecaceae	Palmyra Palm	Tree	
3.	Azadirachta indica	Meliaceae	Neem, Vembu	Tree	V V
4.	Acacia nilotica	Mimosaceae	Babul, Karuvelam	Tree	
5.	Aloe vera	Liliaceae	Kathalai	Herb	

		List of Fauna	
S.No.	Scientific Name	Common Name	Picture
1.	Acraea terpsicore	Tawny coster	2
2.	Eumenus	Wasp	HAY
3.	Carausius sp	Stick insect	7
4.	Aranea sp	Spider	*
5.	Hieroglyphus sp	Grasshopper	



10.4 Climatic Conditions

The area receives rainfall of about 709mm/annum and the rainy season is mainly from Oct-Dec during monsoon. The summer is hot with maximum temperature of 35°C and winter encounters a minimum temperature of 18°C.

10.5 Human settlement

There are few villages located in this area within 5km radius, the approximate distance and population are given below:

TABLE - 10 Approximate distance & Approximate S.No Name of the Village Direction from lease applied area population Onnipalayam 1.0km - NE 900 1. 700 2. Sengalipalayam 2.5km - SE 3. Kalipalayam 2.0km - SW 500 400 4. Bilichi 3.5km - NW

Basic human welfare Amenities such as Health Centre, Schools, Communication Facilities, and Commercial Centres etc are available at Karamadai located at a distance of 5.5km on the Northwestern side of the area.

10.6 Plan for air, dust suppression

The air quality will be affected by the Suspended Particulate Matter (SPM) generated by the blasting, jack hammer drilling, Loading and unloading during the Roughstone quarry operation.

The following Mitigative measures will be carried out

- Mist Water spraying will be carried out by means of water sprinklers to suppress the dust emission in the Haul roads.
- Vegetations will be formed on the non quarrying area.
- The Roughstone will be fully covered by the Taurpaulin during transportation to avoid the spillage of materials.

Air quality will be monitored periodically as per Norms and Mitigative measures carried out to prevent dust and Air propagation in to air. The estimated budget for dust suppression would be around Rs.52,000/year.

Bilich (Roughstone and Graval Quarry

10.7 Plan for Noise level control.

The noise level is increased due to the excavation, Drilling, Blaston and Transportation.

Engineering Noise control:

Noise will be created due to the usage of Machineries and Vehicles. The Noise will be controlled in the following manner.

- Selection of new low noise equipment's is proposed to be deployed for the Roughstone quarry operation.
- Modifications of older equipment.
- Implementation of effective preventive maintenance which reduces noise level more than 50%.
- Developing Green belts which act as Acoustic barrier, pollution absorbent and noise controller.
- The drivers will be strictly instructed to move the vehicle in speed not exceeding 40km per hour during transportation.
- Sentries with flags & whistle will be posted in village road junction and populated area to control and regulate traffic.

Shallow holes of 32mm diameter and maximum depth of 1.5m will be drilled and conventional low power explosives such as Slurry Explosives, ordinary safety fuse will be used for Roughstone. Hence, ground vibration and noise pollution ie., minimal and restricted within the quarry working area.

Noise level monitoring and other Mitigation measures will be carried out to reduce Noise and Vibration. The estimated budget for Noise level monitoring would be around Rs.2,000/Year.

10.8 Environment impact assessment statement describing impact of mining on the next five years

In the mining plan proposed for a production of Roughstone and Gravel does not involve deep hole drilling and blasting. Such limited mining activity is not likely to cause any impact adversely on the environment. As far as pollution of air, water and noise concerned, the environment impact studies will be conducted as per EIA notification issued by MoEF & CC. It is B2 Category mine. The estimated budget would be around Rs.3,80,000/-.

10.9 Proposal for waste management

There is no waste anticipated in this Roughstone and Gravel quarrying operation. The entire quarried out materials will be utilized (100%).



Bilichi (K-W) Roughstone and Orayel Quarry

Mining Plan

10.10 Proposal for reclamation of land affected during mining activities and at the end of mining (refilling/ fencing etc.)

In the mining plan only to a maximum depth of 22m below ground level has been envisaged as workable depth for safe &economic mining during entire lease period. Hence, after quarry reaches the ultimate pit limit of 22m depth below the ground level, fencing will be constructed around the quarried pits to prevent inadvertent entry of the public and cattle. There is no proposal for reclamation and rehabilitation. The barbed wire fencing cost would be around Rs.2,00,000/-.

10.11 Programme of Greenbelt development (indicate extend, number, name of species to be afforested).

7.5m & 10m safety barrier and Nearest Panchayat Roads has been identified to be utilized for Greenbelt appropriate native species of Neem/ Casuarina trees will be planted in a phased manner as described below.

TABLE - 11

Year	No. of tress proposed to be planted	Survival %	Area to be covered sq.m	Name of the species	No. of trees expected to be grown
1	95	80%	848	Neem/ Casuarina	76
П	95	80%	848	Neem/ Casuarina	76
III	95	80%	848	Neem/ Casuarina	76
IV	95	80%	848	Neem/ Casuarina	76
V	95	80%	848	Neem/ Casuarina	76

Nearly 4,240sq.m area is proposed to be used under Greenbelt by planting 95Nos of Neem/ Casuarina trees every year with an anticipated survival rate of 80%. (Refer Plate No.III). The estimated budget for plantation and maintenance of Green belt development would be around Rs.47,500/- for the period of five years.

10.12 Proposed financial estimate/ budget for (EMP) environment management:

Budget Provision for the entire quarrying period

TABLE -12

S.No	Monitory and Analysis Description	Rate per location	No. of location	Total Charges/ six months	Total Charges/ year
1	Ambient air quality monitoring	6500	4	26000	52000
2	Noise level monitoring	250	4	1000	2000
3 Ground vibration monitoring		1000	2	2000	4000
4	Water sampling and analysis	9000	1	9000	18000
	Total E	MP Cost/ year	•		76,000

The EMP cost would be around Rs.3,80,000/- for the period of five years.

2 9 MAR 2019
Bilichi (E-W) Roughstone and Grave Quarry

1

A. Project cost/ i	20 4 5 5 M 高岳 前 居	D. Care
i) Land cost	The Land value as per the Government Guideline is cost is calculated as follows, 4.62.50ha X Rs.14,90,500/ha = Rs.68,93,563/- (source: https://tnreginet.gov.in/portal/)	=Rs.68,93,563/-
ii) Machinery to be used	The following machineries are proposed to meet out the productions. Excavator attached with rock breaker, Tipper, Tractor mounted compressor With jack Hammer and loose tools (Rental Basis)	=Rs.30,00,000/-
iii) Refilling/ Fencing	Fencing will be constructed around the quarry pit to prevent the inadvertent entry of public and cattles cost would be around	= Rs.2,00,000/-
iv) Labourers shed	Labour sheds will be constructed as semi permanent structure. The cost would be around	= Rs.85,000/-
v) Sanitary facility	Adequate latrine and urinal accommodation shall be provided at conveniently accessible places. The cost would be around	= Rs.50,000/-
vi) Others items	First aid room & accessories	= Rs.50,000/-
vii) Drinking water facility for the labourers	Packaged drinking water will be provided for all the labours. Drinking water will be readily available at conveniently accessible points during the whole of the working shift the cost would be around	= Rs.1,00,000/-
viii) Sanitary arrangement	The latrine and urinal will keep clean and sanitary condition. The maintenance cost would be around	= Rs.50,000/-
ix) Safety kit	All the safety kit such as Helmet, Earmuffs, Goggles, Reflector Jackets, Safety shoes etc., will be provided to the workers by the applicant own cost which would be around	= Rs.85,000/-
x) Water sprinkling	Water will be sprinkled in the haul roads by water sprinklers the cost would be around	= Rs.1,00,000/-
xi) Greenbelt etc.	Greenbelt program will be carried out in the boundary barriers and Panchayat roads the cost would be around	= Rs.47,500/-
	Total Project Cost =	Rs.1,06,61,063/-

2 9 MAR 2019

Mining Plan Bilich (E-W) Roughstone and Grayel Quarry

B. EMP Cost :- (Per year)

Air Quality monitoring

D 10.000

Water Quality Sampling

Rs. 18,000/-

Noise Monitoring

Rs. 2,000/-

Ground vibration test

= Rs. 4.000/-

Total Cost

Rs. 76,000/-

Total EMP Cost for the five years period is Rs.3,80,000/-

A+B=

A. Project cost

= Rs.1,06,61,063/-

B. EMP Cost

= Rs 3,80,000/-

Total Project Cost (A+B)

= Rs.1,10,41,063/-

The applicant Indents to involve corporate social responsibilities (CSR) activity like providing note books to nearby school, providing drinking water facilities to the nearby villages etc., at 2.5% from the total project cost the cost would be around Rs.2,76,500/-

Total Project cost

= Rs.1,10,41,063/-

CSR Cost (2.5%)

= Rs. 2,76,500/-

Total cost

= Rs.1,13,17,563/-

(The Total cost of the project including EMP Cost is Rupees one crore thirteen lakhs seventeen thousand five hundred and sixty three only).



11.0 MINE CLOSURE PLAN

11.1 Steps proposed for phased restoration, reclamation of already mined out areas:

There is no proposal for back filling, reclamation and rehabilitation. The quarried pits after the end of the life of lease will be fenced to prevent inadvertent entry of public and cattles. After treating the water the same will be utilized for agriculture purpose of the agriculture lands.

11.2 Measures to be under taken on mine closure as per Act & Rules:

Measure will be taken as per Act & Rules. There is no proposal for back filling, reclamation and rehabilitation. The quarry pit will be fenced by barbed wire to prevent inadvertent entry of public and cattle.

The quarried out pit will be allowed to collect rain and seepage water which will act as a temporary reservoir for storage. This water storage will enhance the static level and ground water and to recharge the nearby wells and also it will be used for irrigating the nearby agriculture lands.

11.3 Mitigation measure to be undertaken for safety and restoration/ reclamation of the already mined out area:

Air quality: (Air quality will be degrade due to the drilling, blasting, mining operation and transportation)

Mitigation measures:

Drilling will be carried out by wet drilling mode to control the dust propagation into the air.

Blasting will be carried out on limited scale. Mist Water spraying on haul road is proposed to prevent the dust propagation into the air. Air quality will be monitored periodically as per norms.

NOISE AND VIBRATION: (The noise will be formed due to the drilling, blasting, loading and movement of Machineries)

Mitigation measures:

The applicant proposed to carry out the plantation all along the boundary to prevent Noise besides wet drilling will be practiced to prevent dust. All the machineries will be maintained in good conditions as per RTO and TNPCB Norms to prevent Noise, Smoke and vibration.

Bilichi (I-W) Roughstone and Gravel Quarry

2 9 MAR 2019

WATER REGIME:

Mitigation Measures:

The quarry operation proposed up to a maximum depth of 2 in below ground level for the five year period, the proposed depth is well above the water table (summer in 55m and rainy seasons in 50m) for the five years plan period. Hence the water table will not be affected in anyway

The seepage and rain water will be drained out from the pit by the 5H.P motor pump and discharged through filter media to the Greenbelt area in the boundary barrier. The excess water will be sprayed on haul roads to prevent dust propagation in to the atmosphere. The Roughstone quarry will not produce any harmful toxic effluents.

HUMAN HEALTH & SAFETY: Dust will be limited due to the mine operation

All the labours have been provided with safety equipments like helmet, Safety Goggles, Ear muff, Hand Gloves, safety jacket, safety belt, Mine boots etc., by the applicant own cost as per Director of mines safety. The foreman/Permit Mines Manager will provide first aid for small & minor injuries. In case of any eventualities, the victim will be taken to the nearby hospital by the applicant vehicle which is always available in the mines office. The hospital is about 5.5km in Karamadai (NW).

12.0 ANY OTHER DETAILS INTEND TO FURNISH BY THE APPLIC

This Mining plan for Roughstone and Gravel quarries prepared and 2019 rended Rules 41 & 42 of Tamilnadu Minor Mineral Concession Rules, 1959. The provisions of the Mark Act, Rules and Regulations and orders shall be complied with in the quarrying per parties of the safety off the mine, machinery and person will be well protected. Permission, relaxation or exemption wherever required for the safe and scientific quarrying of the deposit will be obtained from the Department of Mines Safety. Any violation pointed out by the inspecting authorities shall be rectified as per the guidelines of the concerned Department.

Prepared by

Dr.P. Thangaraju, M.Sc., Ph.D.

Qualified Person

Place, Salem

Date: 09 03 2019

This Mining Plan is Approved subject to the conditions / stipulation & indicated in the Mining Plan Approval Letter No: 617/mirce/2018, 64: 24/3/15 office of the A.D. Geology & Mining Coimbatore

This Mining Plan is Approved based on the incorporation of the particulars specified in the letter of the commissioner of Geology and Mining, Chennai ref No: 3863/LC/2012 Dated 19.11.2012 and subjected to further fulfillment of the condition laid down under Tamilnadu Minor Mineral Concession Rules 1959.

JOINT DIRECTOR AND

ASSISTANT DIRECTOR (I/c)
DEPARTMENT OF GEOLOGY & MINING
COIMBATORE.

COMBA



<u> ந</u>.க.எண். 617/கனியம்/2018



குறிப்பாணை

கள் மங்களும் தவரிக்காம் 6117 156IT - கோபம்பத்தார் மாவட்டம் - கோயம்புத்தூர் வடக்கு வட்டம் - பிளிச்சி (கி-மே) கீராமம் - புல எண்கள். 1120/4B-ல் 0.77.50 ஹெக்டேர். 1121 4B-ஸ் 0.48.50 ஹெக்டேர் மற்றும் 1119-ல் 3.36.50 ஹெக்டேர் ஆக மொத்தம் 4.61.50 ஹெக்டேர் பரப்பளவுள்ள பட்டா பூமியில் சாதாரண மற்றும் கிராவல் குவாரி தி ந.P.சித்தார்த்தாயெளலி என்பவருக்கு -கவரி ருத்தகை அனும்தி வழங்குவது – தொடர்பாக.

பார்வை: 1. திரு.P.சித்தார்த்தாமௌலி, த/பெ.S.பழனிச்சாமி, 2/246. கண்ணார்பாளையம். கோயம்புத்தூர் மாவட்டம் என்பவரது மனு நாள் 03.12.2018.

இவ்வலுவலக இதே ந.க.எண் மற்றும் நாள். 07.12.2018. கோயம்புக்கூர் வடக்கு சர் அட்சியர் (பொ)

அவர்களின் கடித ந.க.எண். 3681/2018 அ3

Блей 29.01.2019

இணை இயக்குநர் LOGBORE உதவி இயக்குநர்(பொ). diamigar புவியியல் கோயம்புத்தூர் தணிக்கை கரங்கத்துறை. அறிக்கை நாள் 05.03.2019.

பார்வை 1-60 கோயப்புத்தும் மாவட்டம். கயுமடை. கண்ணார்பாளையம். 2/246 नानात (ഥക്കുനിവിക് வசிக்கம் திரு.S.பழனிச்சாமி என்பவரின் மகன் திரு.P.சித்தரர்த்தாமௌலி என்பவர் கோயம்புக்கூர் வடக்கு வட்டம், பிளிச்சி(கி-மே) கிராமம். புல எண்கள். 1120/4B-ல் 0.77.50 ஹெக்டேர், 1121/4B-ல் 0.48.50 ஹெக்டேர் மற்றும் 1119-ல் 3.36.50 வெக்டேர் ஆக மொத்தம் 4.62.50 ஹெக்டேர் பரப்பளவுள்ள பட்டா பூமியில் சாதாரணகற்கள் மற்றும் கிராவல் குவாரி செப்ய, குத்தகை உரிமம் கோரி விண்ணப்பித்துள்ளார்.

கோயம்புத்துர் Curinna தொடர்பாக, வடக்கு 10601 ஆட்சியர்(பொ) மற்றும் கோயம்புத்தூர். புவியியல் william சுரங்கத்துறை **இணை** இயக்குநர் மற்றும் உதவி இயக்குநர்(பொ), ஆகியோர் புலத்தணிக்கை மேற்கொண்டு கோயர்புத்தூர் மாவட்டம், காரமடை, கண்ணார்பாளையும், 2/246 என்ற முகவரியில் வசிக்கும் திரு.S.பழனிச்சாமி என்பவரின் மகன் திரு.P.சித்தார்த்தமௌலி என்பவருக்கு கோயம்புத்தூர் வடக்கு வட்டர். பிளிச்சி(கி-மே) கிராமம், புல எண்கள். 1120/4B-ல் 0.77.50 ஹெக்டேர். 1121/4B-ல் 0.48.50 ஹெக்டேர் மற்றும் 1119-ல் 3.36.50 ஹெக்டேர் ஆக மொத்தம் 4.62.50 ஹெக்டேர் பரப்பளவுள்ள பட்டா பூமியில் சாது ஏணகற்கள் மற்றும் கிராவல் குவாரி செய்ய கிழகண்ட நிபந்தனைகளுடன் பரிந்துரை செய்துள்ளார்கள்.

நியந்தனைகள்

 அரகிலுள்ள பட்டர் நிலங்களுக்கும் மற்றும் பொது மக்களுக்கும், எவ்வித் இடையூறும் இன்றி தவரிப்பார் மேற்கொள்ள வேண்டும்.

 அருகில் உள்ள பட்டா நிலத்திற்கு 7.5 மீட்டர் மற்றும் பட்டா வண்டிப்பாதைக்கும், சிறிய ஒடைக்கும் 10 மீட்டர் பாதுகாப்பு இடைவெளி விட்டு குவாரிப்பணி மேற்கோள்ள வேண்டும்.

 புள்ளன் 1119-ன் வடகிழக்கே செல்லும் பயன்பாட்டில் இல்லாத மின் பாதையை குத்தகை உரிமம் பெறுவதற்கு முன்பு மனுதாரர் அப்புறப்படுத்திக் கொள்ள வேண்டும்.

4. மெருகேற்றக்கூடிய கிராணைட் கற்கள் வெட்டியெடுக்க கூடாது

5. தழந்தை தொழிலாளர்களை வேலைக்கு அமர்த்தல் கூ. ரது

அனுமதி கோரும். புல எண்கள். 1120/4B மற்றும் 1121/4B அளது பட்டா எண்கள் முறையே 3134 மற்றும் 3133-ன் படி கிரு. படவிச்சாட் என்பவர்ன் மகள் கிருசித்தர்த்தாயோன்லி(மனுதார்) மற்றும் தித்தானசோதன் என்லாரின் மகன் திகபர்கருத் என்பவர்கள் பெயூல் கூடக்கிப்பட்டாவாக கிராம் கணைகள்ள தாகிகவாக புன்னது. the rest the second of the second of the second of ச் நுதான சேது வி வியவின் முனைவி சி நமத் சந்திரி விறும் யாகிச்சும் இது பார்ச் முறு**னை**கள் கிருமத்கொடுகுகள் ஆகிய்வு இனி பெயர்ஸ் கூட்டுப்பட்டாளக் கிரும் கணக்கில் தாக்கலாக மார்று போயர் பாத்தில் பர்பிட்ட அட்சியா அளிகளார். தக்கண்க அதுபதி 如何**未**配口能 新的心脏器 的进 的过去分词 30000 电影记忆 மதுதார்! ராசுருண்கருகள் முற்றும் கிராவ் இடைப்படுக்க கூடித் பட்ட நோர்களான திரும்ரி காந்தி, ஆன அமைப் 2048 மற்றும் 1121 48) நிநுமதி, சந்திர மற்றும் திருமதி ஜெய்கட்கமியுள் கண் 1119) வூகியோர்கள் மனுதாருக்கு சும்மத கடிதம் அளித்துள்ளார்கள். எனவே மேற்படி பூமியில் மனுகாரர் குளாரி குத்தகை உரியம் பெற 5 1 FLISH LIBIT SLATT.

எனில் சர் வடசியர்போட கொயியத்தரி வடக்கு மற்றம் கோய**்பு**த்தரி பலியில் மற்றும் காங்கத்தனரி இனை இயக்குநி மற்றும் உதலி இயக்குள்போ ஆகியோது பலத்தனிக்கை முறிக்கையின் குடிப்படையில் கோய்படுத்தரி மாவட்டம், கருமடை சண்ணரியாளையும், 2246 என்ற முகவரியில் வசிக்கும் மேலும். தமிழ்நாடு சிறுகனிய சலுகை விதிகள்-1959 விதி எண். 41 மற்றும் 42- வி படி குவாரிப்பணி மேற்கோள்வது தொடர்பாக வரைவு கரங்க திட்டத்தினை 90 தினங்களுக்குள் சமர்ப்பிக்குமாறும். கற்றுச்சூடில் அனுமத் பேற்று சமர்ப்பிக்கவும் மணுதாரரை கேட்டுக் • கோள்ளப்படுகிறது


> od XXX மாவட்ட ஆட்சித் தலைவர் கோயம்புத்துர்.


2 9 MAR 2019


பெறுதல்: திரு.P.சித்தார்த்தாமௌலி, திபே.S.பழனிச்சாமி, 2/246, கண்ணார்பாளையம், காரமடை, கோயம்புத்தூர் மாவட்டம்


//உண்மை நகல் / உத்திரவுப்படி//

அ செருத்திரை மாவட்ட ஆட்சித் தலைவருக்காக கோயம்புத்தார்.

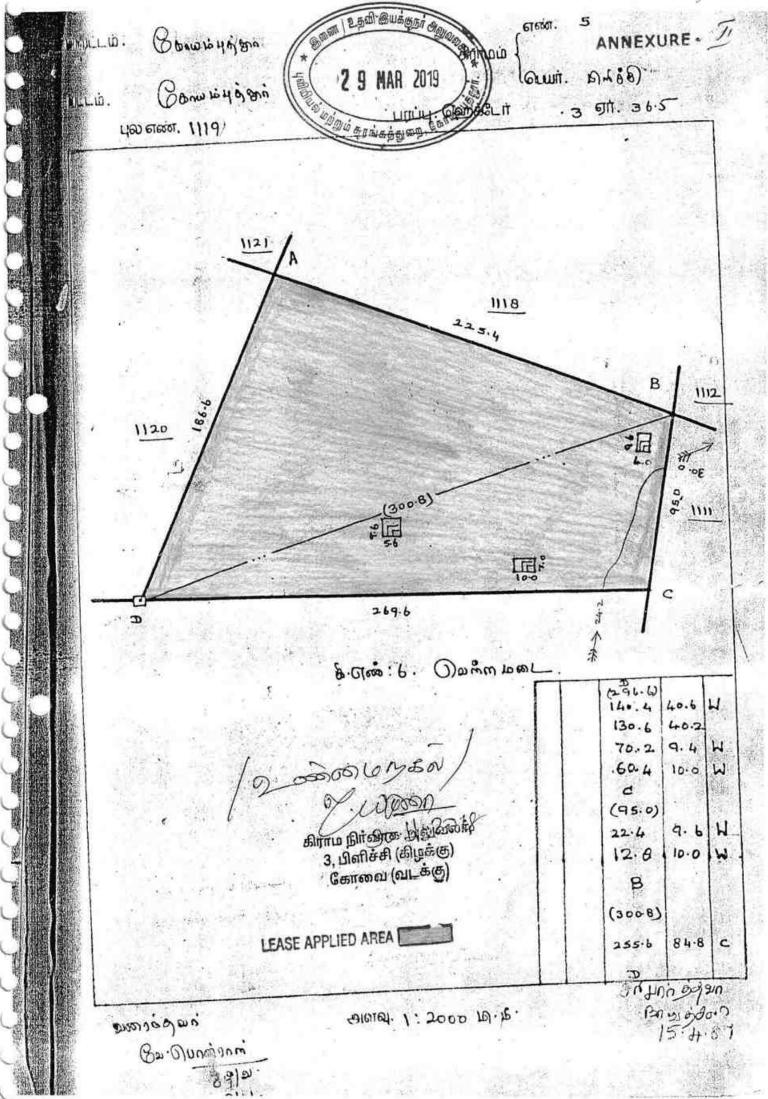

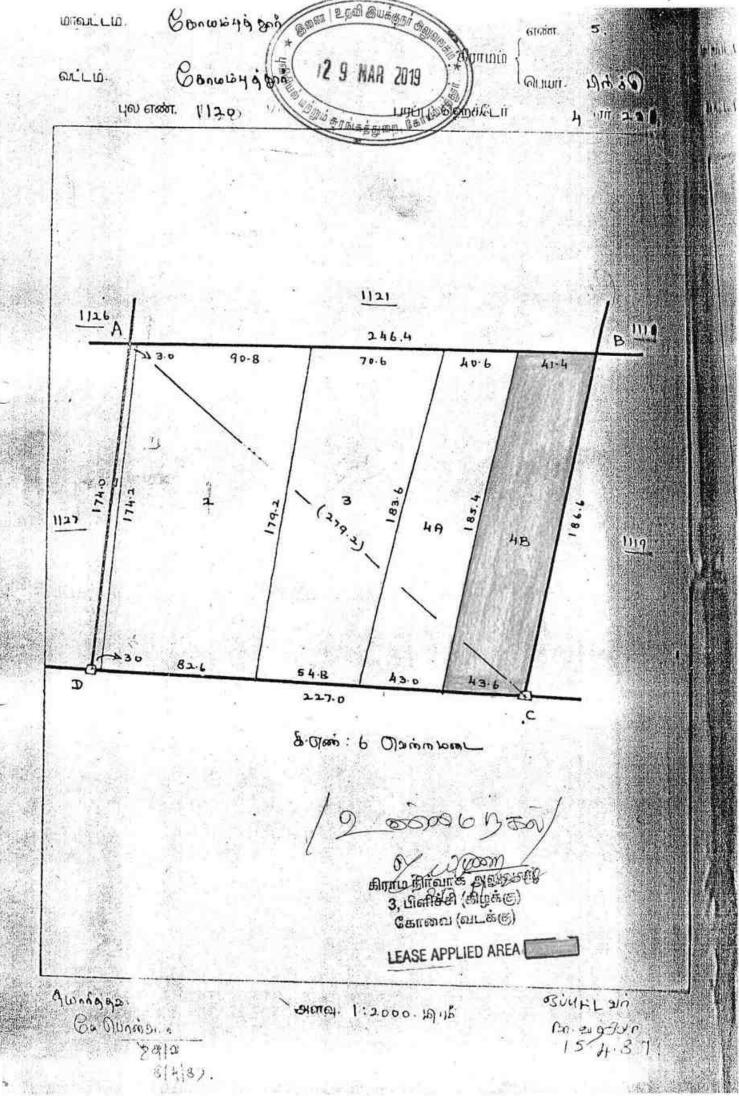

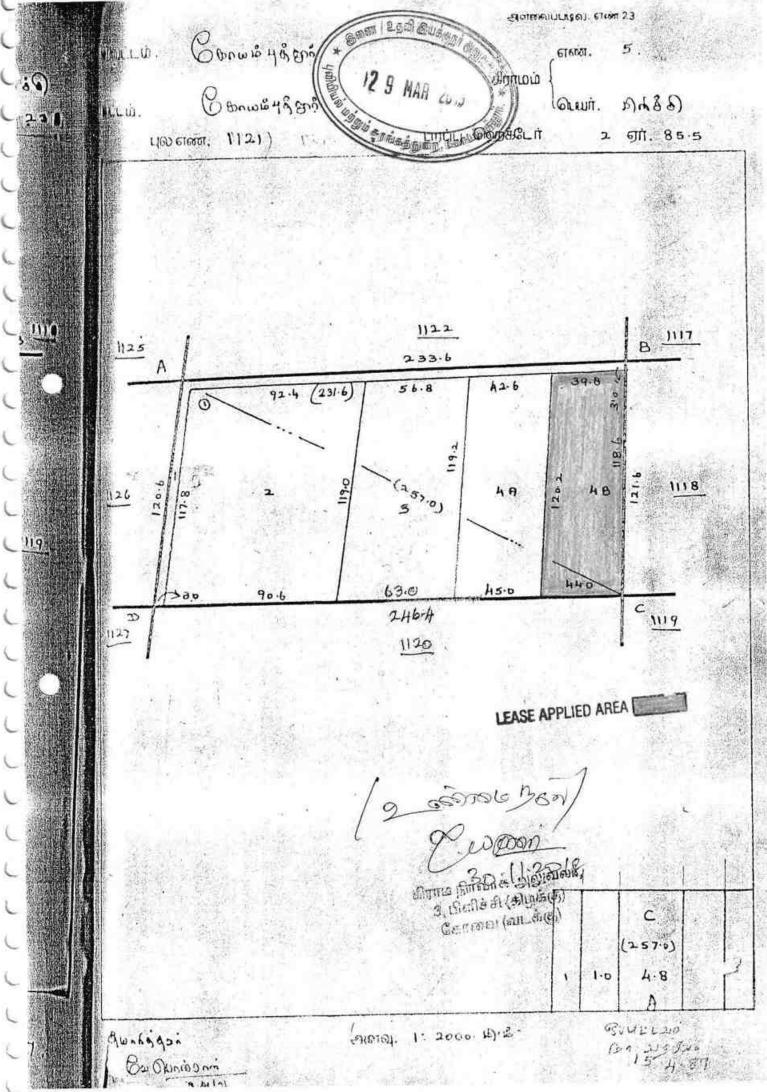

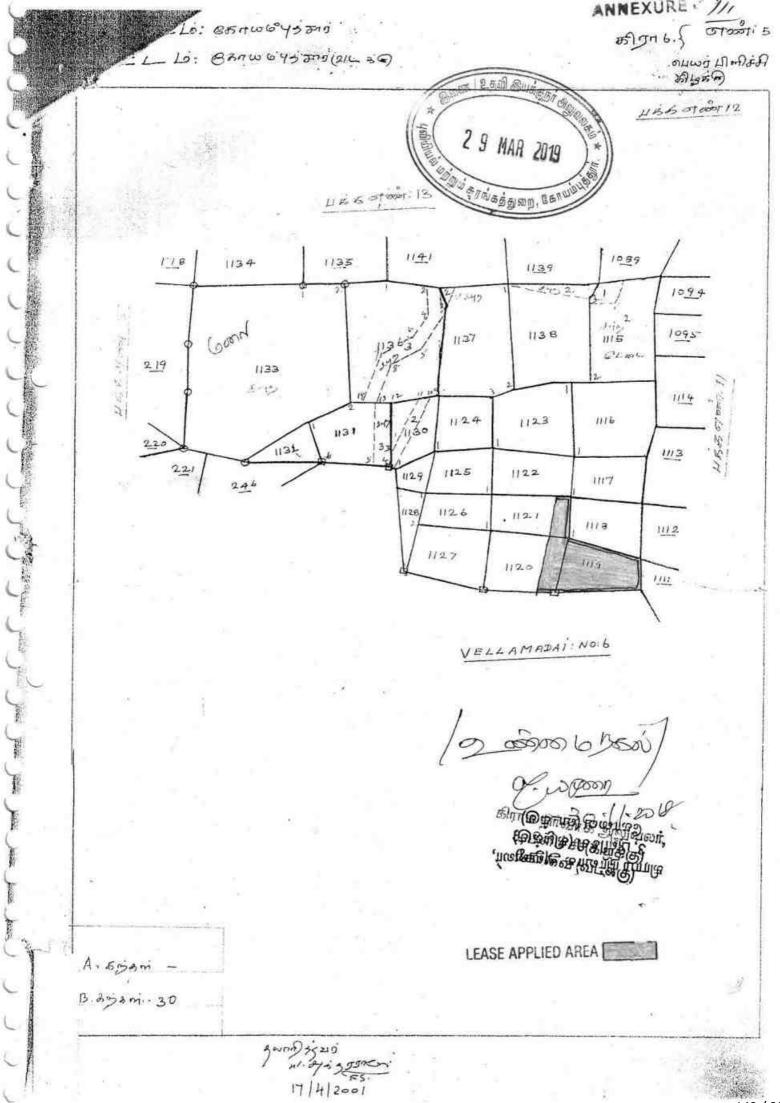





வருவாய்த் துறை

நில உரிமை விபரங்கள் : இ. எண் 10(1) பிரிவ



வட்டம் : கோயம்புத்தூர் வடக்கு

பட்டா என் : 3289

மாவட்டம் : கோயம்புத்தூர்

வருவாய் கிராமம் : பிளிச்சி (கி-மே)

உரிமையாளர்கள் பெயர்

1.	ஞானசேகரன்	ഥഞ്ഞബി .	சந்திரா
		ഥത്തെഖി	ஜெயலட்சுமி
2	புமுனிசாமி	(T) ad (a) (a) (a)	17 CO

		நன்வெ	நன்செய்		சப்	மற்றவை		
- No. 100		парт	தீர்வை	սցնվ	தீர்வை	பரப்பு	தீர்வை	
புல என்	உட்பிரிவு -	ஹெக் - ஏர்	ரு - பை	ஹெக் - ஏர் 3 - 36.50	ரு - பை	ஹெக் - ஏர்	ട്ര - ബ	
11:9			**		4.16	**	**	
47	COUNTY.			3 - 36.50	4.16			

குறிப்பு2 :



- பெற்கண்ட தகவல் / சான்றிதழ் நகல் விவரங்கள் மின் பதிவேட்டிலிருந்து பெறப்பட்டவை. இவற்றை தாங்கள் http://eservices.tn.gov.in என்ற இணைய தளத்தில் 12/02/005/03289/30512 என்ற குறிப்பு எண்ணை உள்ளீடு செய்து உறுதி செய்துகொள்ளவும்.
- 2. இத் தகவல்கள் 29-11-2018 அன்று 09:39:21 AM நேரத்தில் அச்சடிக்கப்பட்டது.
- 3. கைப்பேசி கேமராவின்2D barcode படிப்பான் மூலம் படித்து 3G/GPRS வழி இணையதளத்தில் சரிபார்க்கவும்



நில உரிமை விபரங்கள் : இ. எண் 10(1) பிரிவு

மாவட்டம் : கோயம்புத்தூர்

வட்டம் : கோயம்புத்தூர் வடக்கு

வருவாய் கிராமம் : பிளிச்சி (கி-மே)

பட்டா எண் : 3134

உரிமையாளர்கள் பெயர்

1.

பழனிசாமி

மகன்

சித்தார்த்தாமௌலி

2.

ஞானசேகரன்

மகன்

நீகாந்த்

		நன்	ிசய்	புன்	செய்	மற்றவை		
		սդնգ	தீர்வை	սցնւլ	தீர்வை	பரப்பு	தீர்வை	
प्रश तक्का	உட்பிரிவு	ஹெக் - ஏர்	ரூ - பை	ஹெக் - ஏர்	ரூ - பை	ஹெக் - ஏர்	ரூ - டை	
1120	48		**	0 - 77.50	0.96		**	

குறிப்பு2 :	
	மற்கண்ட தகவல் / சான்றிதழ் நகல் விவரங்கள் மின் பதிவேட்டிலிருந்து பெறப்பட்டவை. இவற்றை தாங்கள் http://eservices.tn.gov.in என்ற இணைய தளத்தில் 12/02/005/03134/30561 என்ற குறிப்பு எண்ணை உள்ளீடு செய்து உறுதி செய்துகொள்ளவும்.
	2. இத் தகவல்கள் 03-12-2018 அன்று 08:23:28 AM நேரத்தில் அச்சடிக்கப்பட்டது.
	3.கைப்பேசி கேமராவின்2D barcode படிப்பான் மூலம் படித்து 3G/GPRS வழி இணையதளத்தில் சரிபார்க்கவும்



நில உரிமை விபரங்கள் : இ. எண் 10(1) பிரின்

மாவட்டம் : கோயம்புத்தூர்

வருவாய் கிராமம் : பிளிச்சி (கி-மே)

வட்டம் : கோயம்புத்தூர் வடக்கு

பட்டா எண் : 3133

உரிமையாளர்கள் பெயர்

பழனிசாமி 1.

மகன்

சித்தார்த்தாமௌலி

ஞானசேகரன் 2.

மகன்

ழீகாந்த்

		நன்ட		. புன் ே		மற்ற	ഞഖ
		սյմւլ	தீர்வை	பரப்பு	தீர்வை	பரப்பு	தீர்வை
புல எண்	உட்பிரிவு	ஹெக் - ஏர்	'ரூ - பை	ஹெக் - ஏர்	ர്ര - വെ	ஹெக் - ஏர்	ரு - பை
1121	4B	***		0 - 48.50	0.60		**
14	-			0 - 48.50	0.60		

குறிப்பு2:



- 1-மேற்கண்ட தகவல் / சான்றிதழ் நகல் விவரங்கள் மின் பதிவேட்டிலிருந்து பெறப்பட்டவை. இவற்றை தாங்கள் http://eservices.tn.gov.in என்ற இணைய தளத்தில் 12/02/005/03133/30550 என்ற குறிப்பு எண்ணை உள்ளீடு செய்து உறுதி செய்துகொள்ளவும்.
- இத் தகவல்கள் 03-12-2018 அன்று 08:23:33 AM நேரத்தில் அச்சடிக்கப்பட்டது.
- 3. கைப்பேசி கேமராவின்2D barcode படிப்பான் மூலம் படித்து 3G/GPRS வழி இணையதளத்தில் சரிபார்க்கவும்

	Control of the contro							1	*/	100				1	1	*					
And the state of t	Banks I Flags									1/20//	9	MA		019		(Sant.					
- Little (b. Control of Control o	சுப்பிற்கு வில்வவழுக் எயல் பியால்கும் மில்வல்கள் காக்கல் வர்காகத் காக்குகள் சுலைத் கிற்பேக்கா (5) த பெற்பியாதுக்க கிற்பல் பெற்பியாதுக்க காக்கல் படக்குத்தைய முக்கிர்கிற்கு (5) படக்குத்தைய முக்கிர்கிற்கு கிற்பியியா இங்கிறின் இங்கிறின் இங்கிறின் இங்கிறின் இங்கிறின் இங்குக்கு இங்குக்குக்கு இங்குக்கு இங்குக்கு இங்குக்கு இங்குக்கு இங்குக்கு இங்குக்கு இங்குக்கு இங்குக்கு இங்குக்கு இங்குக்குக்கு இங்குக்கு இங்குக்கு இங்குக்குக்கு இங்குக்கு இங்குக்குக்குக்கு இங்குக்குக்கு இங்குக்குக்குக்குக்குக்குக்குக்குக்குக்கு	7 77	(F) (M) 1-1				4												lot.		
	ternic denderation		-						-	-	-	-	-	-		-		-	-	-	
Gunaus.	சுக்கிய்ய காயவகைக் உ மிராமுத்	4.54	+	+		100		+	+	+	+	-	-	-		-			-		
Seven ma 6	ALBERT AND	£	1	+				+		+	+	-	-	-	-	-	+	-		+	
å -	தெய்யப்பட்டது. பழிரின் பெயர்.	3.5	+	t		Soff,					t	l		-			T				
	ாயா அடிக்குரை குர்ந குற்ற குப்பப்பங்க படைறுகு அடுக்குறை இப்பப்பங்கி	(0)	12	Ala t	-18 -18	Sand Series	SERTE BE	1	1:		200		1	-	4	1	id.	-	10000	-	1
	நாது, ம்கள்களிர .டுக்கழின் த		12	19 amone 1	8 18 1.	Lang manual	S. Charles & G. Barra & & G. Ba		A100	84					1					-	
	காயவனர்கள் உ வ்ராவு முல்ல்லோய நாவு ம்லல் முனவும் .டுர்கல் மில்லியின்		2	11 511	graf -	Train and purings	Centa Be			3											
	úra <u>ga</u> cénésiral paraga drestreada Oraskylda T	6.1 (6.1)	3, Fb.0	11 511	9 call 1	The second secon	(CB 118)														
	்பயிலின் பெயர். பயிரான திறுக்கை! உண்ளமான உண்ளமான பார்க்கல் ஆன்ரம். இகைக்கள்கள்	6.1 (6.1)	Men S. too	11 511	8 ses 2	Tariff Williams	OB THE STATE OF TH		2200												
	் பயிரின் பெயர். மயிரான செய்ய உண்ளமாள் உண்ளமாள் பாம்க்கல் ஆன்வு இகைக்கல் ஆன்வு இதன்கு	(c) (c) (c)		11 511	8 x 8 /	TO OC	(A) Table (A)		45	1											
முதல் கோசும்.	மாத்தில் அழுவன் மாத்தில் அழுவை செய்வர்க்கு மின்ன பெய்க் பயின்ன அழுவை உண்ளவள்ள கான முய்க் மாக்குல் ஆன்மு	(a) (b)	Table 1	11 511	8 x8/2	TO OC OCTO	DR #189			1					4						
முதல் கோசும்.	க்கும் அத்த வடுக்கும். காகள்படி படுக்கு இன்று கிய மக்கு அரம் அத்த கிய மக்கு அரம் அத்த அத்த அரம் அத்த அத்த அரம் கிய படியாகம் கிய படிய இத்த அத்த அத்த கிய விரம் காம்ம் கிய படிய காம் இத்த அத்த இத்த இத்த இத்த இத்த இத்த இத்		B 14 8 30 (3) 7 14 8 14	11 511	graf.	O.S. Same	Distriction of the second of t			1					4						
naturalisi apagala Genradii. Wasuri	கவப்படுத்த நடிக்கும். கொழ்த்த நடிக்கும். கொழ்த்த நடிக்கும். கொழ்த்த நடிக்கும். குர்க்கும். அதிகைய வர்க்கும். அதிகைய வர்க்கும். அதிகைய வர்க்கும். அதிகைய வர்க்கும். அதிகைய வர்க்கும். அதிகைய வர்க்கும். அதிகள் வர்க்கும். அதிகள் வர்க்கும். அதிகள் வர்க்கும். அதிகள் வர்க்கும். அதிகள் வர்க்கும். அதிகள் வர்க்கும். அதிகள் வர்க்கும். அதிகள் வர்க்கும். அதிகள் வர்க்கும். அதிகள் கிகைக்கம். அன்வு		282 B. T. K. 30 (2)	11 511	graf -	O.S. Same	3, 120		45	1					4						
என்றை முற்ற கோகம். மானில் கொகம். கொக்	கவட்டத்திரை இது இருந்து அருந்து இருந்து அருந்து வருந்து அருந்து அருந்து வருந்து வருந்		74-16 2836 B-148-190 (2)	11 511	of the same	O.S. Same	3, 120			1					4						
தில் வந்த திட்டத்தின்படி நல் வந்த திட்டத்தின்படி நல்கள்கள் விளர்	திர்வை கொட்டு இருந்து இரு ம்கைய் இருந்து நடித்து இரு நடித்து இருந்து நடித்து இருந்து இருந்து இருந்து இருந்து இருந்து இருந்து வருந்து		282 B. T. K. 30 (2)	11 511	9 xx 12	O.S. Same	3, 120			1					4						

mi. complete where the state of	A careful Les interept constitution of the careful Les interept constitution of the careful ca				3, 2134-6	Signature Managaratic	Congress of the second	2 9	MAR	2019			
9 3	Santam than Santam than Santam than Santam S	130			Que : 3 33	2							
- m	் நல்படுத்த நூல்வதுத பார்க் பெய மக்கதிருப் நரிக்கற்ற (ர) சிர்கள்கு பிர்கள் சிர்கள்கத்தி பிர்கள் அர் நல்லத் எடுந்பப்பை (5) பிர்கள்கத்தி அர்கு கிருக்கும் மற்றுக்கு சிர்கள்கள் குர்கள் கிருக்கும் புரிகர்டு (5)	2			5								
as grantil so	சுத்பாப காபமான்க மாவுத மாவுத சுத்வகளில் இங்கிறிர்				is seedlined D	1							-
திராமத்தின் வருடன்ளி தொடித்தின் வருடன்ளி	ound.	8	(m)		- व्या	orts basey							
De Karing 2	்லம் கடுத்தாய் கர் தர்ச் தொல்றமாக பாவழுத் எத்த்தா இசுமாபாய்கர்	(3)		-	()	Lisablera,	ப (வட்க்கு)					1	ì
	. இருக்குள் இருக்குள்		1 1	1 1	10 × 50	(1) (1) (1) (1) (1) (1) (1) (1) (1) (1)	1691			1			1
	mentanista (E. a.												
O), present.	January Spanial E												
कृषिकी	S Gentrander of the Section of the S		Surru Branks Alles (B)										
Antigota Lucativi Gani	இது ஏத்ச சுந்த்தை சொர்காயதாதுக்க குசையு குக்கூடுப்பட்டிக்கப சியேட சித்தேதிய அத்த	(Pares)	Saffied 6	1 0 0 0 0 0 0 0 0 0 0 0 0 0 0 0 0 0 0 0		K							
A & D CO CO CONTRAIN 1. IN	enectrifing participates Chunchi netrogui Spiringa zenicura Spiringa zenicura Spiringa zenicura	50	8,000 S.	9 4 -									
1.9	greens	- 4		0.309								***	
- ஆம் பசலியில் நல வரித் இடத்தின்படி பலக்களின் விபாம்	- 19 m y 9	6715096	-	ما موياده	17	+			-	+	1	1	
五 右根	ngan	AB 8:	+-	48 04	ŽÍ.	+						*	

மாவட்டம் : கோயம்புத்தூர்

வட்டம் : கோயம்புத்தூர் வடக்கு

கிராமம் : பிளிச்சி (கி-மே)



2. உட்பிரிவு எண்

3. பழைய புல உட்பிரிவு

हा वर्णना

4. பகுதி

5. அரசு / ரயத்துவாரி

ரயத்துவாரி

புஞ்சை

1119

1119

6. நிலத்தின் வகை

7. பாசன ஆதாரம்

B. இரு போகமா



9. முண் வயனமும் ருணு

10. மண் தரம்

11. தீர்வை (ரூ - ஹெ)

1.24

12. புரப்பு (ஹெக்டேர் - ஏர்) 3 - 36.50

13, மொத்த தீர்வை (ரூ -

பை)

14. பட்டா என்

3289

15. குறிப்பு

கிணறுகள்

16. பெயர்

1.சந்திரா 2.ஜெயலட்சுமி

குறிப்பு 1:



பேற்கண்ட தகவல் / சான்றிதழ் நகல் விவரங்கள் மின் பதிவேட்டிலிருந்து பெறப்பட்டவை. இவற்றை தாங்கள் http://eservices.tn.gov.in என்ற இணைய தளத்தில் 10512 என்ற குறிப்பு எண்ணை உள்ளிடு செய்து உறுதி செய்துகொள்ளவும்.

அ-பதிவேடு விவரங்கள் 2 9 MAR 2019

மாவட்டம் : கோயம்புத்தூர்

வட்டம் : கோயம்புத்தூர் வடக்கு

கிராமம் : பிளிச்சி (கி-மே)

 ដុល តស់ត 	1120
2. ខ្លាំ ប៉ាព្យិស្ស តល់វា	4B
3. பழைய புல உட்பிரிவு எண்	-4p
4. பகுதி	P
5 அரசு / ரயக்குவாரி	ரயத்துவாரி

அரசு / ரயத்துவாரி ரயத்துவாரி
 நிலத்தின் வகை புஞ்சை

7. பாசன ஆதாரம் 8. இரு போகமா 9. மண் வயனமும் ரகமும் 8 - 4

10. மண் தரம்

11. தீர்வை (ரு - ஹெ) 1.24

் 12. பரப்பு (ஹெக்டேர் - ஏர்) 0 - 77.50

13. மொத்த தீர்வை (ரூ - 0.96

பை)

14. பட்டா என்ன

3134

15. குறிப்பு

16. பெயர்

1.சித்தார்த்தாமௌலி 2.ஸ்ரீகாந்த்

குறிப்பு 1:



மேற்கண்ட தகவல் / சான்றிதழ் நகல் விவரங்கள் மின் பதிவேட்டிலிருந்து பெறப்பட்டவை. இவற்றை தாங்கள் http://eservices.tn.gov.in என்ற இணைய தளத்தில் 10561 என்ற குறிப்பு எண்ணை உள்ளிடு செய்து உறுதி செய்துகொள்ளவும். மாவட்டம் : கோயம்புத்தூர்

வட்டம் : கோயம்புத்தூர் வடக்கு

கிராமம் : பிளிச்சி (கி-மே)



ध्रक हाखेंग

1121

2. உட்பிரிவு என்

4B

 பழைய புல உட்பிரிவு எண்

-4p

4. பகுதி

.

5. அரசு / ரயத்துவாரி

ரயத்துவாரி

6. நிலத்தின் வகை

புஞ்சை

7, பாசன ஆதாரம்

8. இரு போகமா

9. மண் வயனமும் ரகமும் 8 - 4

10. மண் தரம்

6

11, தீர்வை (ரூ - ஹெ)

1.24

12. பரப்பு (ஹெக்டேர் - ஏர்) 0 - 48.50

13. மொத்த தீர்வை (ரூ -

0.60

பை)

14. பட்டா என்

3133

15. குறிப்பு

16. பெயர்

1.சித்தார்த்தாமௌலி 2.ஸ்ரீகாந்த்

குறிப்பு 1:



மேற்கண்ட தகவல் / சான்றிதழ் நகல் விவரங்கள் மின் பதிவேட்டிலிருந்து பெறப்பட்டவை. இவற்றை தாங்கள் http://eservices.tn.gov.in என்ற இணைய தளத்தில் 10550 என்ற குறிப்பு எண்ணை உள்ளிடு செய்து உறுதி செய்துகொள்ளவும்.



தமிழ்நாடு तमिलनाडु TAMIL NADU G. Chandra.

2/241, Kanrarpalayan. Karamadai, Che.

12AB 897178

மு. தாள் விற்பணையாளர் R:K.S. பில்டிங், பங்களாமேடு மேட்டுப்பாளையம் - 641 301. உரிழம். என்ர: 7333/பி1/97/எ

இப்படிக்கு,

சம்மதக்கடிதம்

1.தோயம்புத்தூர் மாவட்டம் 2/241,கண்ணார்பாளையம், சிக்கார்க் புளையம், திராமம், காரமடை, என்ற விசாலத்தில் வசிக்கும் **திரு.s ஞானசேகரன் மனைவி சேந்திறி**

சிக்காரம்பாளையும் கிராமம், கோயீம்புத்தூர் மாவட்டம், . . 2/246, கண்ணார்பாளையம், காரமடை, என்ற விசாலத்தில் வசிக்கும் திரு.s பழனிசாமி மனைவி P ஜெயலட்சுமி

ஆகிய நூங்கள் எழுதிகொடுக்கும் சம்மதக் கடிதம் என்னவென்றால்.

கோயம்புத்தூர் மாவட்டம், கோவை வடக்கு, பிளிச்சி கிராமம் க.ச எண் 1119 ல் 3.36.5 ஹெக்ே¢ேர் பரப்பு காலையானது பட்டா எண் 3289 ன் படி எங்களுக்கு பாத்தியப்பட்டது. 2/246 கண்ணார்பாளையம்,சிக்காரம்பாளையம் மேற்படி, காயம்புத்தூர் மாவட்டம் கிராமம். ⁸காரமடை, கோயமுத்தூர் என்ற விலாசத்தில் வசிக்கும் திரு பழனிசாமி மகன் சித்தார்த்தாமெளலி என்பவருக்கு கோயம்புத்தூர் மாவட்ட ஆட்சியர் அவர்களால் மேற்படி பூமியில் சாதாரணக்கற்கள் மற்றும் கிராவல் மண் எடுக்க அனுமதி வழங்க ஓப்புதல் அளிக்கப்பட்ட நாளிலிருந்து ஐந்து வருடத்திருக்கு மேற்படி பூமியில் கிராவல் மண் வெட்டி ஏடுத்து செல்லை கம்மதம் தெரிவிக்கிறோம்

K.K. NATESAN, B.Com., B. L. ADVOCATE & NOTARY

Combatore District I, Jawans Bhavan, Ground Floor, Coimbatore - 641 018.

Cell: 94437 10112



தமிழ்நாடு तिमलनाड् TAMIL NADU - வ. ப. Thulapauah

2.11.18 (BENDER 2-104

சம்மதக்கடித்ம^ற

9/8 8 ffeet to 1


கோயம்புத்தூர் மாவட்டம் 2/241,கண்ணார்பாளையம்,சிக்காரம்பாளையி கிராமம், காரமடை, கோயமுத்தூர் மாவட்டம் என்ற விசாலத்தில் வசிக்கும் திரு s ஞானசேகரன் மகன் திரு. மேரீகாந்த் ஆகிய நான் எழுதிகொடுக்கும் சம்மதக் கடிதம் என்னவென்றால்

கோயும்புத்தூர் மாவட்டம் கோவை வடக்கு பிளிச்சி கிராமம் க.ச எண் 1120 4பி ல் 0.77.5 ஹெக்டேர் பரப்பு காலையானது பட்டா எண் 3134 ன் படி மற்றும் க.ச எண் 1121 4பி ல் 0.48.85 ஹெக்டேர் பரப்பு காலையானது பட்டா எண் 3133 எனக்கு மற்றும் சித்தார்த்தா்மௌலி என்பவருக்கும் கூட்டாக பாத்தியப்பட்டது. மேற்படி கண்ணார்பூரளையம், சிக்காரம்பாளையம் கிராமம், காரமடை, கோயமுத்தூர் என்ற திரு.பழனிசாமி விலாசத்தில் வசிக்கும் மகன் திரு. P சித்தார்த்தாமௌலி கோயம்புத்தூர் மாவட்ட ஆட்சியர் அவர்களால் மேற்படி பூமியில் என்பவருக்கு கிராவல் மண் எடுக்க அனுமதி வழங்க ஓப்புதல் மற்றும் சாதாரணக்கற்கள் அளிக்கப்பட்ட நா<u>ளிலிருந்து</u> ஐந்து வருடத்திருக்கு மேற்படி பூமியில் கிராவல் மண் வெட்டி எடுத்து செல்ல சம்நதம் தெரிவிக்கிறேன்

ADSTRACT CONTARY QUULLAGE,
ADSTRACT CHART

Commission Charact
Lawrent Blocker, Chrond Floor,
Commission 641 018.
Cen 94437 10112



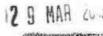

Day Unique Identification Authority of India

Address:

்டூத் முகவரி

90 பழனிசாமி, 2/246, கண்ணார்பாளையம், காரமடை, கிக்காரம்பாளையம், காரமடை, ்கோயம்புத்தூர், தமிழ் நாடு.

S/O: Palanisamy, 2/246, KANNARPALAYAM, KARAMADAI, Chikkarampalayam, Karamadai, Coimbatore, Tamil Nadu, 641104

5445 8330 7612



5445 8330 7612

இந்திய அரசாங்கம்

Government of India


சித்தார்த்தாமெனவி பழனிசாயி

Siddharthamouli Palanisamy

பிறத்த நாள் / DOB : 19:02/1992

ஆண்பால் / Male

ஆதார் - சாதாரண மனிதனின் அதிகாரம்

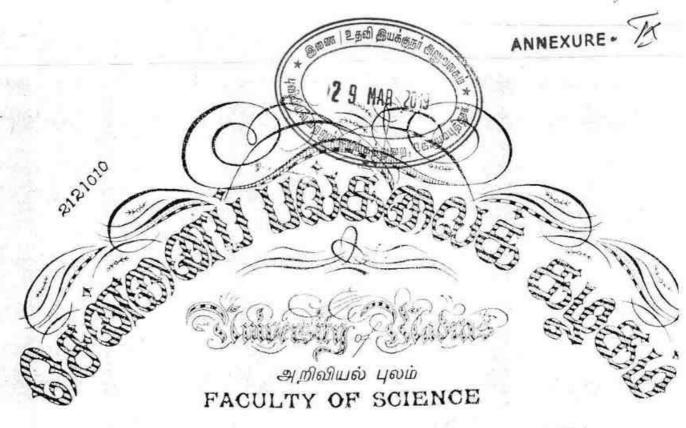

் சென்னைப் பல்கலைக் கழகப் இறனை 1994 ஆகம் ஆண்டு ஏப்ரல் மாதம் நடத்த கூசிமனியல் தோலை பை நார்நூராக என்றவி அறிவியல் நிறைஞர் தோச்சி பெற்றார் என்று தக்க தேர்வாவர்கள் சான்றவித்தபடி அறிவியல் நிறைஞர் என்றை பட்டத்தை அவருக்குப் பல்கலைக் கடிக இசைச்சைய்தி வ வழங்குகிறது.

The Senate of the UNIVERSITY OF MADRAS hereby makes known that . Degree of Master of Science, he she having been certified by duly appointed Examiners to be qualified to receive the same in . Geology and was placed in the First . Class, at the Examination held in April 1994.

To Siven under the seal of the University

Courses Madras

LEGITERIT. Provistras 7.7 Ponder Gerico.
Vice-Chancello

GOVERNMENT OF INDIA MINISTRY OF LABOUR AND REMABILITATION OFFICE OF THE DIRECTOR GENERAL OF MINES SAFETY

2 9 MAR 2019

Certificate of Practical experience granted by the Manager to Candidate for a Manager's / Surveyor's / Foremen's / Over man's / Structure of competency (Restricted) examination under the Metalliferous Mines Regulations 1961.

T.VENKATARAJAGOPALAN being the Mines Agent of M/S.LIMENAPH CHEMICALS, RAJAPALAYAM OF LIMESTONE PRODUCTS (Thenmali Limestone Mine) do hereby certify that Thiru. P.THANGARAJU, son of S.PERIASAMY (whose signature is appended) worked as a Geologist in the above mine from 02.05.1994 to 30.12.1999. During his term of work aforesaid, he has obtained practical experience as detailed overleaf. The duties connected with his work have involved continuous attendance at the mine and have been efficiently performed by him.

I believe him to be of good character and a fit and proper candidate to be examined for Certificate of Competency.

OF THEMPLAI LIME STONE MINES

(Signature with date and official Scal)

[T.VENKATARAJAGOPALAN]

Mines Agent:

P.O.

: ARUKANGULAM

District

: TIRUNELVELI

State

: TAMIL NADU

(Signature of Candidate)

(State name of Mineral) : LIMESTONE

S.No	Particulars of practical Expereince	Place of Experience (b)	Period of experie	A SOCIAL CONTRACTOR CO	Total Experience (e)			
(a)	, , ,	From	То	Yr.	Month	Day		
01.	As a Trainee in Drilling , Operation.	Semi Mechanised Opencast working	02.05.1994	15.07.1995	01	02	14	
02.	As a Trainee in Blasting Operation.		16 07 1995	10.12.1996	01	04	25	
03.	Exploration		11.12.1996	31,01,1998	01	0.1	20	
04.	Surveying		01,02,1998	25.06.1998	00	04	25	
05.	Sampling Quality control and		26.06.1998	20,07,1999	01	00	24	
06,	Supervision in HEMM Operation.		21.07.1999	30.12.1999	00	05	10	
		GRAND TOTAL			05	0.7	28	

AVERAGE MONTHLY OUTPUT (D) / AVERAGE DAILY EMPLOYMENT (c) DURING THE ABOVE PERIOD IS GIVEN BELOW:

In open – cast working	In all
35	35
	In open – cast working

OF THEMMALAI LIME STONE MINES

Signature of Candidate

Signature of Manager with Disertskilnes)

Name of the Mine

Instructions :-

- 01. State clearly the nature of duties
- 02. State whether on surface, in open cast workings or below ground.
- O3. State specifically the period spent by the applicant in different mining operations, or surveying operations, as the case may be. If the employment has not been such as to involve continuous attendance of the applicant at the mine, it must be stated how many days a week he was employed at the mine, whether underground or above ground and in what capacity.
- 04. Delete if the mine is a Metalliferous mine.
- 05 Delete if the mine is a Coal mine

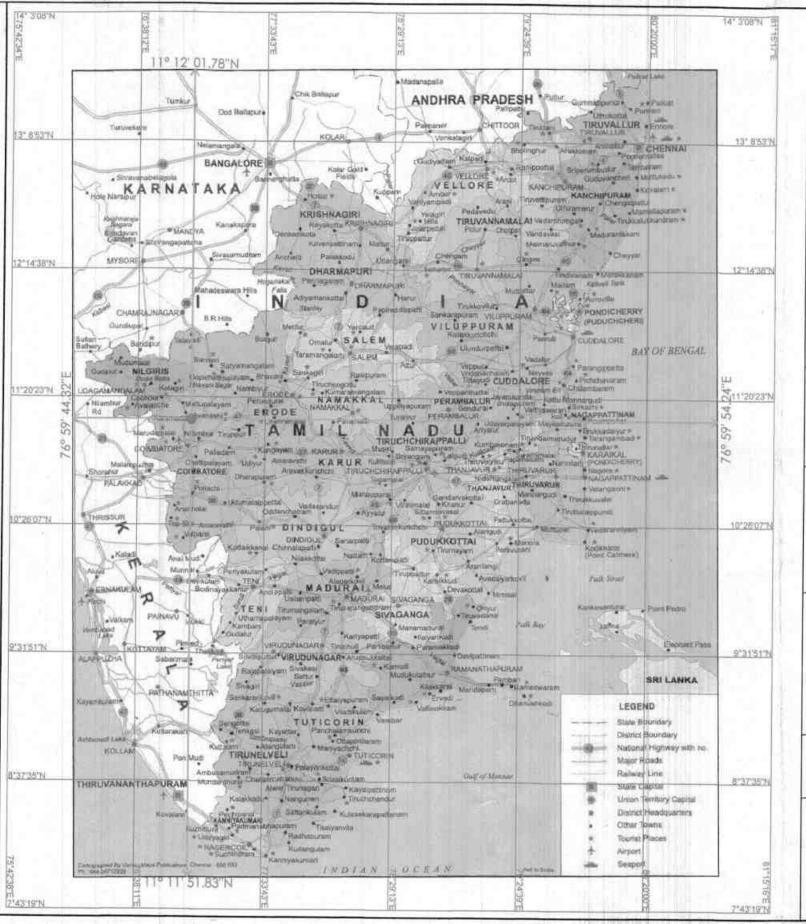




PLATE NO:I

DATE OF SURVEY : 08.03.2019

APPLICANT:

THIRU. P. SIDDHARTHAMOULI, S/O. PALANISAMY, NO.2/246, KANNARPALAYAM, KARAMADAI, COIMBATORE-641 104

LOCATION OF Q.L. APPLIED AREA:

S.F.Nos : 1119, 1120/48 & 1121/48

EXTENT : 4.62.5 Ha

VILLAGE: BILICHI (EAST- WEST)
TALUK: COIMBATORE NORTH

DISTRICT : COIMBATORE STATE : TAMIL NADU

INDEX

Q. L.A. AREA



TOPO SHEET NO.: 58 A/16

LATITUDE : 11" 11' 51.83"N to 11" 12' 01.78"N

LONGITUDE: 76" 59' 44.32"E to 76° 59' 54.24"E

LOCATION PLAN

SCALE 1:24,00,000

PREPARED BY:

THIS IS TO CERTIFY THAT THE INFORMATION IN THIS
PLATE IS TRUE AND CORRECT TO THE
BEST OF MY KNOWLEDGE BASED UPON THE LEASEMAP
AUTHENTICATED
BY STATE GOVERNMENT



157 / 208

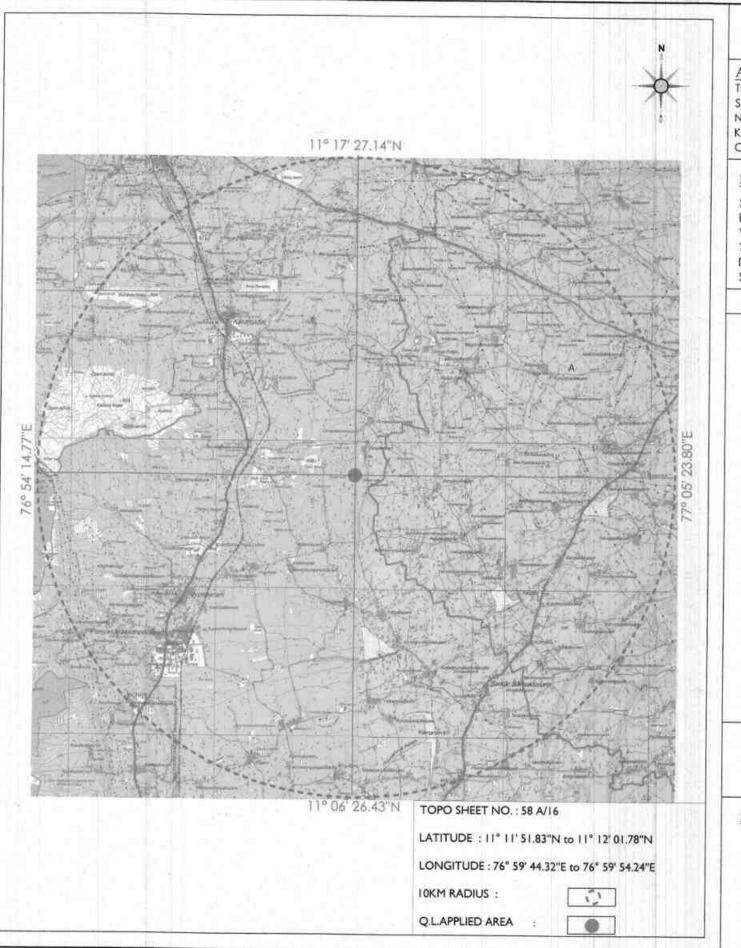


PLATE NO:I-A

DATE OF SURVEY: 08.03.2019

APPLICANT:

THIRU, P. SIDDHARTHAMOUR S/O. PALANISAMY,

KARAMADAI. COIMBATORE-641 104

NO.2/246, KANNARPALATAM. 2 9 MAR 2019

7月105万面到柳原。 LOCATION OF Q.L. APPLIED AREA:

S.F.Nos : 1119, 1120/48 & 1121/48

EXTENT : 4.62.5 Ha

VILLAGE: BILICHI (EAST- WEST) TALUK : COIMBATORE NORTH

DISTRICT : COIMBATORE STATE : TAMIL NADU

INDEX

CONVENTIONAL SYMBOLS

Express righteep with hit with tridge, with distance more	done whele and
field, cottled southy to concern	
Strate street samplesty associng in transfera	
(presentations Section Forecas) with your Process.	****
Seams with train in less, undertained, Company	34 Su -00
Dated Principly of Stock-Rest, earthways, Villan.	
they stywin upon therm, wit most 4 mins. Total year.	ph po me
Submerped todas Missil Swarray Posicis	600 500 v5- v6
place level proved. Table and disting Tarton personal, my	e I I she she
becomes not one to see bose pount.	2000 OF 25 Days
Published broad pages studied single with states, under some	
Surreys when gauges Assire, might will distance cores, on	
Moved fre or henvior. Not Culting with Server	a 45.A
German with such frames of Ferman street CORs.	52 69 334
Sed Seves (196: Gave temperature, Starwoods	WALL DAY ARE
Twent or Miligan Paristing Horward Place	-45- 12
Nuts personant temporary Traver Antiquines	or or 2 Marie
Terrors Driefs Chinel Molecus Sight, Torol Gallery	· 在 · · · · · · · · · · · · · · · · · ·
Significant Signific Resp. Signed Unigited Anybridge	2 6 6 6
Stor West Will David Stock	F 100 15 15
Spine polysis other Flation Contra Statute Otto hass	4 M = 1 10 M
from refrider, model Services (see	-00 -00
Specify, related to	
sale process promotes	
- Walter material and state of their forms	-
Supplemental services or services	
highly templated earlier port spromise.	A200 ,200 _EF
Bright mith glassic setting ment	SM 63-3 JAVAN S
Half office Talegraph affice, Overhead tank	4
Stat Rever's Impediantingshoe Could Name Fathe plans	H H H
Complete process Forms recovered, protection	(ED) 85 24
Special former administrative breakly in your .	KORG AMER
Hopel Departery Vehicles Charter Departury	年 4 日
Restricted Printed Transport	(A) 384 -
Paser free will agree beneged with place empressed	


TOPO SKETCH OF QUARRY LEASE APPLIED AREA FOR 10Km RADIUS


SCALE- 1:100000


PREPARED BY:


THIS IS TO CERTIFY THAT THE INFERMATION IN THIS PLATE IS TRUE AND CORRECT TO THE BEST OF MY KNOWLEDGE BASEO UPON THE LEASEMAP AUTHENTICATED BY STATE GOVERNMENT




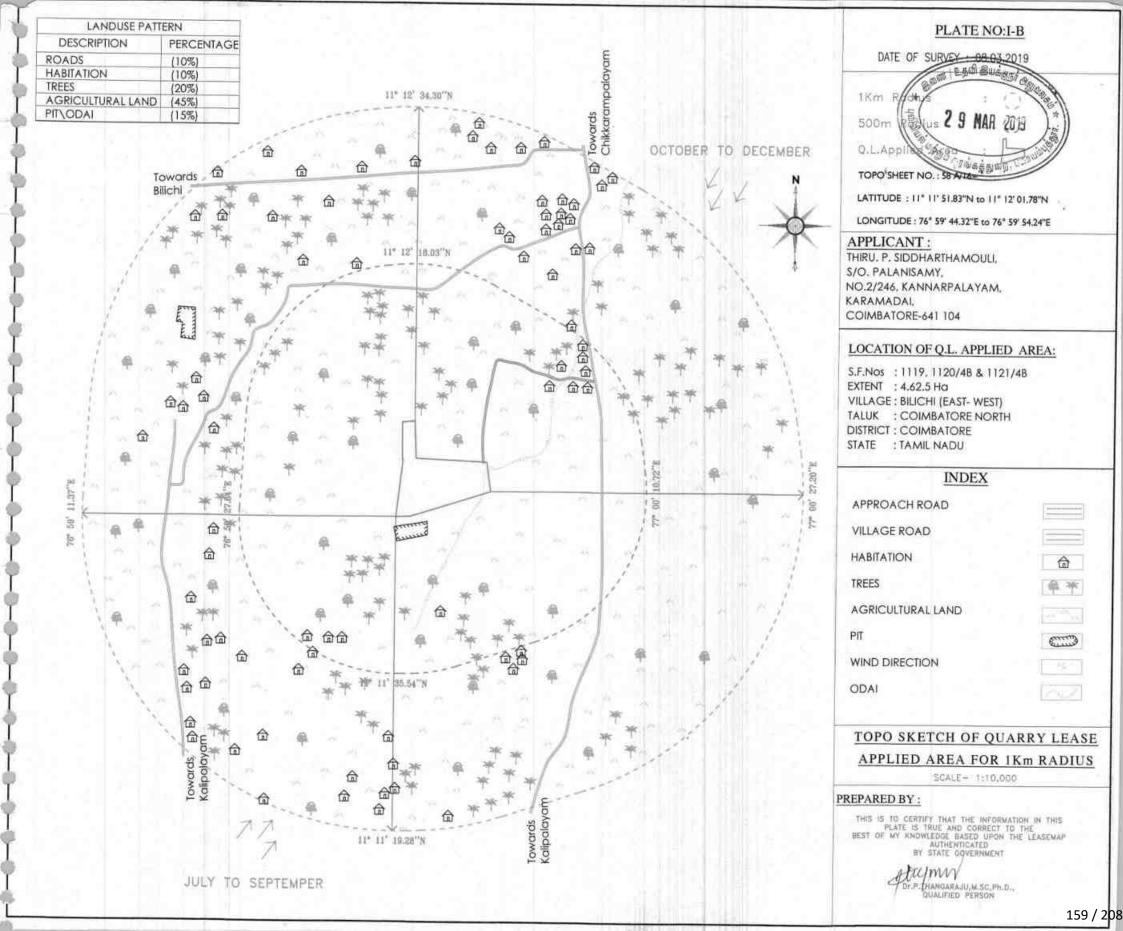

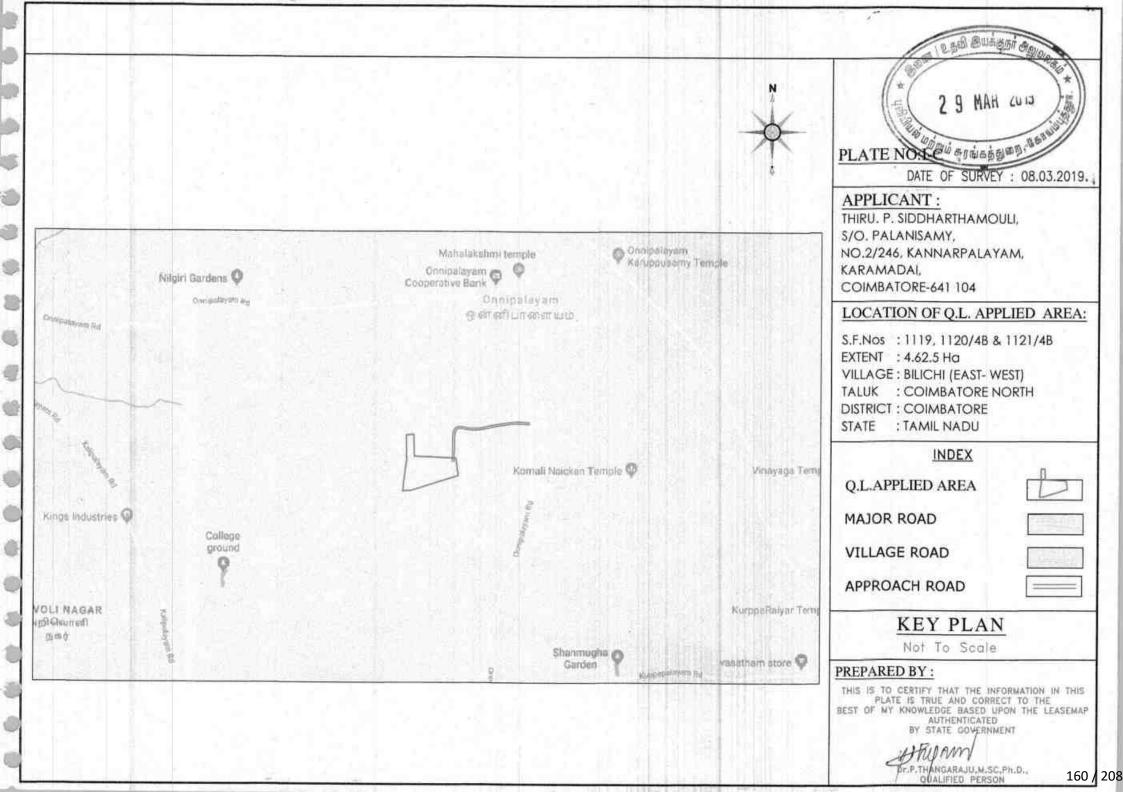

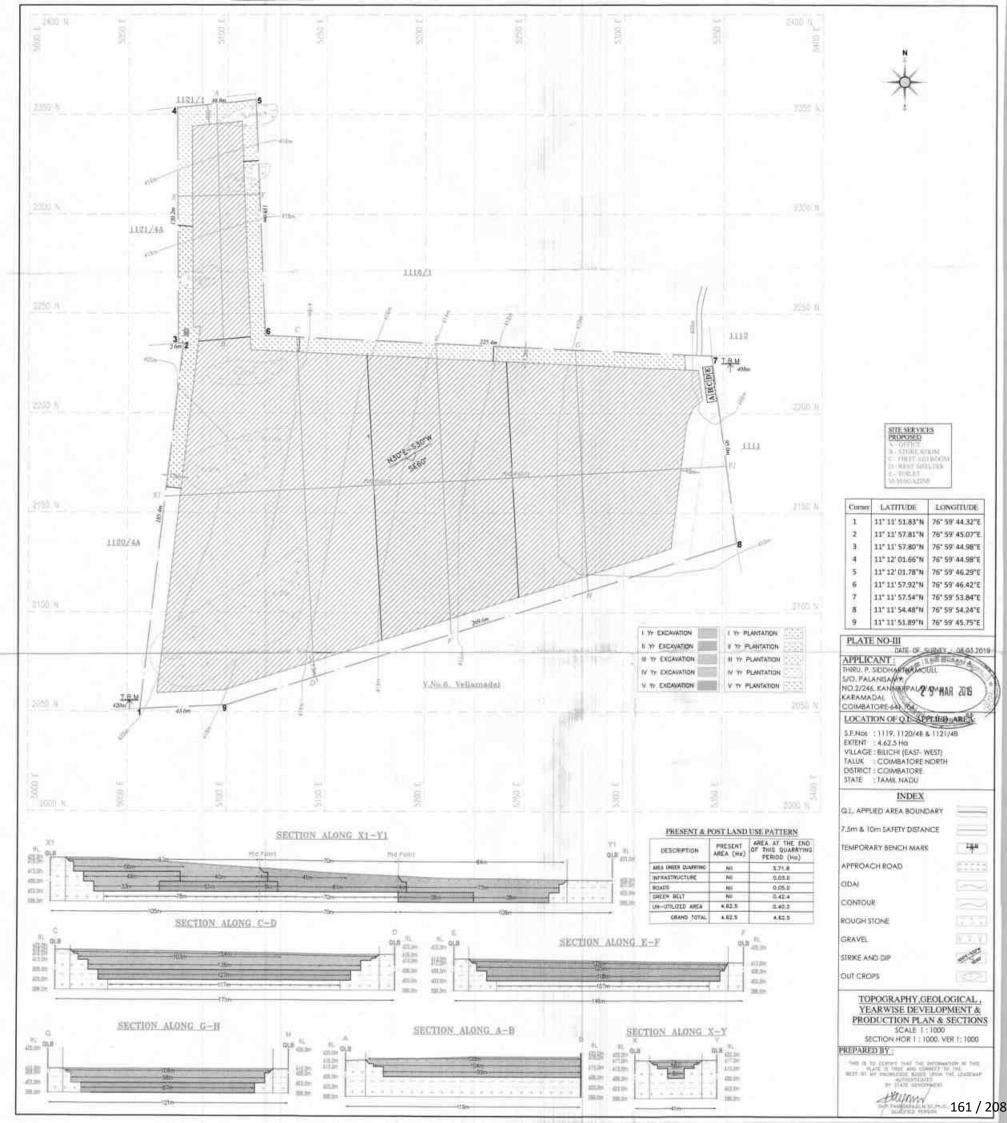

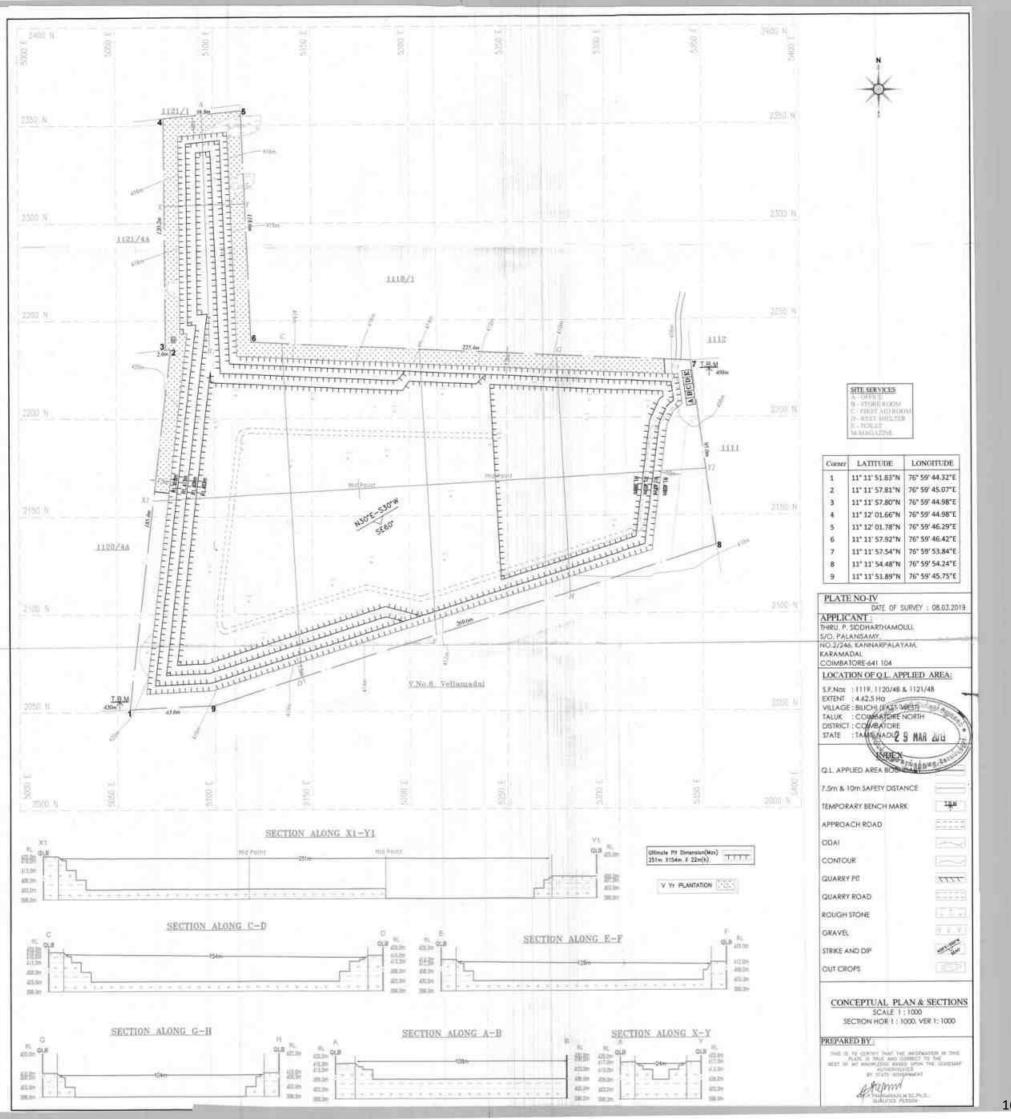

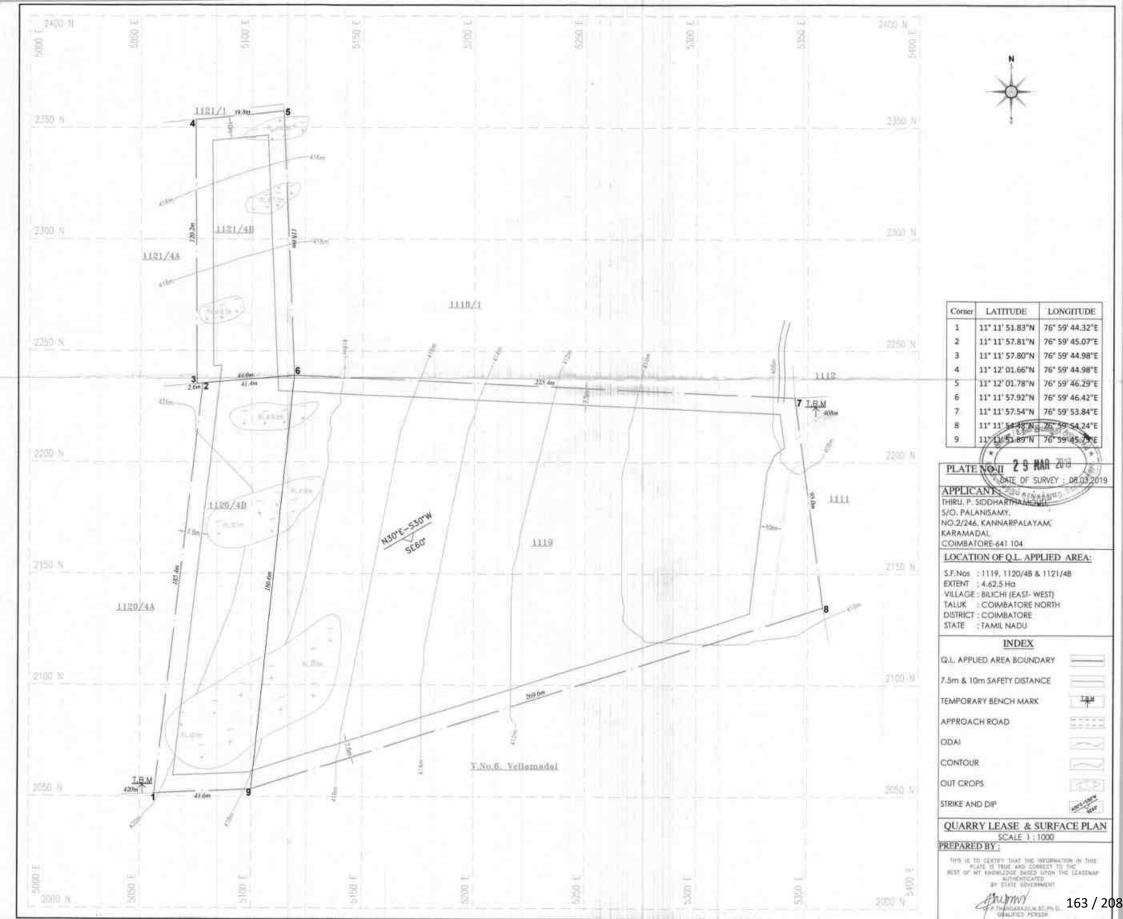





TEST REPORT

4. 15 A W 4 P A B 40 M 10 A 10 A	The state of the s					
Report No	EHS360/TR/2022-23/001	Report Date	02.03.2023			
	Tvi. SRI RAJALAKSHMI SAMAPPA R		JARRY			
Site Location	S.F.Nos. 1120/2 & 1121/2,Bilichi Villag					
	Coimbatore District. Cluster Extent:	7.23.0 ha				
Sampling Method	IS 5182	Sample Drawn by	Laboratory			
Sample Name	Air	Sample Code	EHS360/001			
Sample Description	Ambient Air Quality Monitoring Sample Condition Good					
Sampling Location AAQ 1 – CORE ZONE Project Area 11°12'0.51"N 76°59'39.01"E						

Date	Period. hrs	PM10(μg/m³)	PM2.5(μg/m ³)	SO2 (μg/m ³)	NO2 (μg/m ³)	O3 (μg/m³)	NH3 (μg/m³)	CO (mg/ m ³)
01.12.2022	7:00-7:00	45.5	22.3	6.5	24.1	BDL(DL:5.0)	BDL(DL:1.0)	BDL(DL:1.14)
02.12.2022	7:15-7:15	44.2	22.1	6.1	24.5	BDL(DL:5.0)	BDL(DL:1.0)	BDL(DL:1.14)
08.12.2022	7:00-7:00	45.3	23.6	6.0	22.0	BDL(DL:5.0)	BDL(DL:1.0)	BDL(DL:1.14)
09.12.2022	7:15-7:15	46.1	24.1	6.5	23.8	BDL(DL:5.0)	BDL(DL:1.0)	BDL(DL:1.14)
15.12.2022	7:00-7:00	47.2	23.4	5.2	24.2	BDL(DL:5.0)	BDL(DL:1.0)	BDL(DL:1.14)
16.12.2022	7:15-7:15	45.2	24.1	5.2	24.1	BDL(DL:5.0)	BDL(DL:1.0)	BDL(DL:1.14)
22.12.2022	7:00-7:00	44.0	22.0	5.2	21.3	BDL(DL:5.0)	BDL(DL:1.0)	BDL(DL:1.14)
23.12.2022	7:15-7:15	43.2	24.1	5.0	25.1	BDL(DL:5.0)	BDL(DL:1.0)	BDL(DL:1.14)
29.12.2022	7:00-7:00	44.1	21.0	6.8	25.5	BDL(DL:5.0)	BDL(DL:1.0)	BDL(DL:1.14)
30.12.2022	7:15-7:15	45.0	22.1	6.5	22.4	BDL(DL:5.0)	BDL(DL:1.0)	BDL(DL:1.14)
05.01.2023	7:00-7:00	44.3	22.3	8.8	22.0	BDL(DL:5.0)	BDL(DL:1.0)	BDL(DL:1.14)
06.01.2023	7:15-7:15	45.8	24.2	7.0	22.3	BDL(DL:5.0)	BDL(DL:1.0)	BDL(DL:1.14)
12.01.2023	7:00-7:00	46.2	23.1	6.2	24.0	BDL(DL:5.0)	BDL(DL:1.0)	BDL(DL:1.14)
13.01.2023	7:15-7:15	47.0	25.3	8.2	24.4	BDL(DL:5.0)	BDL(DL:1.0)	BDL(DL:1.14)
19.01.2023	7:00-7:00	46.2	23.1	6.3	22.5	BDL(DL:5.0)	BDL(DL:1.0)	BDL(DL:1.14)
20.01.2023	7:15-7:15	47.3	26.1	7.2	24.3	BDL(DL:5.0)	BDL(DL:1.0)	BDL(DL:1.14)
26.01.2023	7:00-7:00	45.1	22.2	8.3	24.8	BDL(DL:5.0)	BDL(DL:1.0)	BDL(DL:1.14)
27.01.2023	7:15-7:15	44.3	22.3	6.6	25.0	BDL(DL:5.0)	BDL(DL:1.0)	BDL(DL:1.14)
02.02.2023	7:00-7:00	45.3	21.1	7.3	25.3	BDL(DL:5.0)	BDL(DL:1.0)	BDL(DL:1.14)
03.02.2023	7:15-7:15	44.6	22.3	8.5	25.6	BDL(DL:5.0)	BDL(DL:1.0)	BDL(DL:1.14)
09.02.2023	7:00-7:00	45.8	22.4	8.3	24.3	BDL(DL:5.0)	BDL(DL:1.0)	BDL(DL:1.14)
10.02.2023	7:15-7:15	45.3	23.5	6.3	24.3	BDL(DL:5.0)	BDL(DL:1.0)	BDL(DL:1.14)
16.02.2023	7:00-7:00	43.2	22.1	7.0	24.6	BDL(DL:5.0)	BDL(DL:1.0)	BDL(DL:1.14)
17.02.2023	7:15-7:15	42.0	22.3	7.2	24.8	BDL(DL:5.0)	BDL(DL:1.0)	BDL(DL:1.14)
23.02.2023	7:00-7:00	44.6	22.4	6.4	24.0	BDL(DL:5.0)	BDL(DL:1.0)	BDL(DL:1.14)
24.02.2023	7:15-7:15	45.2	22.1	6.3	24.3	BDL(DL:5.0)	BDL(DL:1.0)	BDL(DL:1.14)
NAAQ* S	tandard	<100	<60	<80	<80	<100	<400	<4

Note: BDL: Below Detection Limit ;DL: Detection Limit

Remarks: The values observed for the pollutants given above are within the CPCB standards.

Verified by

Selyk

Page 1 of 4

Authorised Signatory

A-L

Name: Santhosh Kumar A

Designation: Quality Manager

Note: 1. The test results are only to the sample submitted for test. 2.Any correction of the test report in full or part shall invalidate the report.

3. Sample will be retained for 15 days from the date of reporting except in case of regulatory samples or specifically instructed by client.



- LABS

TEST REPORT

Report No. TE LIM	EHS360/TR/2022-23/001	Report Date	02.03.2023				
Site Location	Tvl. SRI RAJALAKSHMI SAMAPPA RO S.F.Nos. 1120/2 & 1121/2,Bilichi Villag						
	Coimbatore District. Cluster Extent: 7	7.23.0 ha					
Sampling Method	IS 5182	Sample Drawn by	Laboratory				
Sample Name	Air	Sample Code	EHS360/001				
Sample Description	Ambient Air Quality Monitoring Sample Condition Good						
Sampling Location AAQ 1 – CORE ZONE Project Area 11°12'0.51"N 76°59'39.01"E							

Date	Period. hrs	SPM (µg/m³)	As (ng/m³)	C6H6 (µg/m³)	BaP (ng/m³)	Pb (μg/m³)	Ni (ng/m³)
01.12.2022	7:00-7:00	67.5	BDL (DL:0.1)	BDL (DL:1.0)	BDL (DL:1.0)	BDL (DL:0.1)	BDL (DL:0.1)
02.12.2022	7:15-7:15	65.3	BDL (DL:0.1)	BDL (DL:1.0)	BDL (DL:1.0)	BDL (DL:0.1)	BDL (DL:0.1)
08.12.2022	7:00-7:00	68.3	BDL (DL:0.1)	BDL (DL:1.0)	BDL (DL:1.0)	BDL (DL:0.1)	BDL (DL:0.1)
09.12.2022	7:15-7:15	67.2	BDL (DL:0.1)	BDL (DL:1.0)	BDL (DL:1.0)	BDL (DL:0.1)	BDL (DL:0.1)
15.12.2022	7:00-7:00	65.3	BDL (DL:0.1)	BDL (DL:1.0)	BDL (DL:1.0)	BDL (DL:0.1)	BDL (DL:0.1)
16.12.2022	7:15-7:15	68.3	BDL (DL:0.1)	BDL (DL:1.0)	BDL (DL:1.0)	BDL (DL:0.1)	BDL (DL:0.1)
22.12.2022	7:00-7:00	64.2	BDL (DL:0.1)	BDL (DL:1.0)	BDL (DL:1.0)	BDL (DL:0.1)	BDL (DL:0.1)
23.12.2022	7:15-7:15	68.0	BDL (DL:0.1)	BDL (DL:1.0)	BDL (DL:1.0)	BDL (DL:0.1)	BDL (DL:0.1)
29.12.2022	7:00-7:00	66.8	BDL (DL:0.1)	BDL (DL:1.0)	BDL (DL:1.0)	BDL (DL:0.1)	BDL (DL:0.1)
30.12.2022	7:15-7:15	65.2	BDL (DL:0.1)	BDL (DL:1.0)	BDL (DL:1.0)	BDL (DL:0.1)	BDL (DL:0.1)
05.01.2023	7:00-7:00	64.1	BDL (DL:0.1)	BDL (DL:1.0)	BDL (DL:1.0)	BDL (DL:0.1)	BDL (DL:0.1)
06.01.2023	7:15-7:15	66.3	BDL (DL:0.1)	BDL (DL:1.0)	BDL (DL:1.0)	BDL (DL:0.1)	BDL (DL:0.1)
12.01.2023	7:00-7:00	68.2	BDL (DL:0.1)	BDL (DL:1.0)	BDL (DL:1.0)	BDL (DL:0.1)	BDL (DL:0.1)
13.01.2023	7:15-7:15	65.1	BDL (DL:0.1)	BDL (DL:1.0)	BDL (DL:1.0)	BDL (DL:0.1)	BDL (DL:0.1)
19.01.2023	7:00-7:00	66.3	BDL (DL:0.1)	BDL (DL:1.0)	BDL (DL:1.0)	BDL (DL:0.1)	BDL (DL:0.1)
20.01.2023	7:15-7:15	68.4	BDL (DL:0.1)	BDL (DL:1.0)	BDL (DL:1.0)	BDL (DL:0.1)	BDL (DL:0.1)
26.01.2023	7:00-7:00	65.2	BDL (DL:0.1)	BDL (DL:1.0)	BDL (DL:1.0)	BDL (DL:0.1)	BDL (DL:0.1)
27.01.2023	7:15-7:15	66.0	BDL (DL:0.1)	BDL (DL:1.0)	BDL (DL:1.0)	BDL (DL:0.1)	BDL (DL:0.1)
02.02.2023	7:00-7:00	66.4	BDL (DL:0.1)	BDL (DL:1.0)	BDL (DL:1.0)	BDL (DL:0.1)	BDL (DL:0.1)
03.02.2023	7:15-7:15	65.8	BDL (DL:0.1)	BDL (DL:1.0)	BDL (DL:1.0)	BDL (DL:0.1)	BDL (DL:0.1)
09.02.2023	7:00-7:00	64.7	BDL (DL:0.1)	BDL (DL:1.0)	BDL (DL:1.0)	BDL (DL:0.1)	BDL (DL:0.1)
10.02.2023	7:15-7:15	68.3	BDL (DL:0.1)	BDL (DL:1.0)	BDL (DL:1.0)	BDL (DL:0.1)	BDL (DL:0.1)
16.02.2023	7:00-7:00	69.4	BDL (DL:0.1)	BDL (DL:1.0)	BDL (DL:1.0)	BDL (DL:0.1)	BDL (DL:0.1)
17.02.2023	7:15-7:15	66.3	BDL (DL:0.1)	BDL (DL:1.0)	BDL (DL:1.0)	BDL (DL:0.1)	BDL (DL:0.1)
23.02.2023	7:00-7:00	67.2	BDL (DL:0.1)	BDL (DL:1.0)	BDL (DL:1.0)	BDL (DL:0.1)	BDL (DL:0.1)
24.02.2023	7:15-7:15	65.1	BDL (DL:0.1)	BDL (DL:1.0)	BDL (DL:1.0)	BDL (DL:0.1)	BDL (DL:0.1)
NAAQ* St		<200	6	5	1	1	20

Note: BDL: Below Detection Limit; DL: Detection Limit

Remarks: The values observed for the pollutants given above are within the CPCB standards

Verified by

Selyk



Authorised Signatory

Name: Santhosh Kumar A Designation: Quality Manager

Note: 1. The test results are only to the sample submitted for test. 2. Any correction of the test report in full or part shall invalidate the report.

3. Sample will be retained for 15 days from the date of reporting except in case of regulatory samples or specifically instructed by client.





TEST REPORT

Report No	EHS360/TR/2022-23/002	Report Date	02.03.2023			
Site Location	Tvl. SRI RAJALAKSHMI SAMAPPA ROUGH STONE & GRAVEL QUARRY S.F.Nos. 1120/2 & 1121/2,Bilichi Village, Coimbatore North Taluk, Coimbatore District. Cluster Extent: 7.23.0 ha					
Sampling Method	IS 5182	Sample Drawn by	Laboratory			
Sample Name	Air	Sample Code	EHS360/002			
Sample Description	Ambient Air Quality Monitoring Sample Condition Good					
Sampling Location AAQ 2 – Onnipalayam - 11°12'26.87"N 77°0'7.67"E						

Date	Period. hrs	PM10(μg/m³)	PM2.5(μg/m ³)	SO2 (μg/m ³)	NO2 (μg/m ³)	O3 (μg/m³)	NH3 (μg/m³)	CO (mg/ m ³)
01.12.2022	7:00-7:00	47.5	25.2	6.5	22.3	BDL(DL:5.0)	BDL(DL:1.0)	BDL(DL:1.14)
02.12.2022	7:15-7:15	46.3	24.4	6.2	23.0	BDL(DL:5.0)	BDL(DL:1.0)	BDL(DL:1.14)
08.12.2022	7:00-7:00	45.3	25.8	7.8	22.5	BDL(DL:5.0)	BDL(DL:1.0)	BDL(DL:1.14)
09.12.2022	7:15-7:15	48.2	26.0	6.5	21.5	BDL(DL:5.0)	BDL(DL:1.0)	BDL(DL:1.14)
15.12.2022	7:00-7:00	49.0	25.3	7.5	22.0	BDL(DL:5.0)	BDL(DL:1.0)	BDL(DL:1.14)
16.12.2022	7:15-7:15	45.2	26.2	6.8	23.5	BDL(DL:5.0)	BDL(DL:1.0)	BDL(DL:1.14)
22.12.2022	7:00-7:00	46.3	23.2	6.4	21.6	BDL(DL:5.0)	BDL(DL:1.0)	BDL(DL:1.14)
23.12.2022	7:15-7:15	47.1	24.3	6.1	22.3	BDL(DL:5.0)	BDL(DL:1.0)	BDL(DL:1.14)
29.12.2022	7:00-7:00	48.2	24.6	6.5	22.2	BDL(DL:5.0)	BDL(DL:1.0)	BDL(DL:1.14)
30.12.2022	7:15-7:15	49.3	25.3	7.3	21.0	BDL(DL:5.0)	BDL(DL:1.0)	BDL(DL:1.14)
05.01.2023	7:00-7:00	45.2	26.1	6.0	22.3	BDL(DL:5.0)	BDL(DL:1.0)	BDL(DL:1.14)
06.01.2023	7:15-7:15	45.1	27.0	7.5	23.5	BDL(DL:5.0)	BDL(DL:1.0)	BDL(DL:1.14)
12.01.2023	7:00-7:00	44.5	24.3	6.8	22.5	BDL(DL:5.0)	BDL(DL:1.0)	BDL(DL:1.14)
13.01.2023	7:15-7:15	45.6	25.0	6.2	23.1	BDL(DL:5.0)	BDL(DL:1.0)	BDL(DL:1.14)
19.01.2023	7:00-7:00	46.0	26.1	7.3	21.6	BDL(DL:5.0)	BDL(DL:1.0)	BDL(DL:1.14)
20.01.2023	7:15-7:15	47.3	27.3	6.4	23.4	BDL(DL:5.0)	BDL(DL:1.0)	BDL(DL:1.14)
26.01.2023	7:00-7:00	49.2	25.3	6.6	22.4	BDL(DL:5.0)	BDL(DL:1.0)	BDL(DL:1.14)
27.01.2023	7:15-7:15	48.3	26.5	7.2	21.5	BDL(DL:5.0)	BDL(DL:1.0)	BDL(DL:1.14)
02.02.2023	7:00-7:00	48.0	27.0	6.8	22.6	BDL(DL:5.0)	BDL(DL:1.0)	BDL(DL:1.14)
03.02.2023	7:15-7:15	47.2	25.3	7.5	23.8	BDL(DL:5.0)	BDL(DL:1.0)	BDL(DL:1.14)
09.02.2023	7:00-7:00	46.2	26.4	6.2	21.4	BDL(DL:5.0)	BDL(DL:1.0)	BDL(DL:1.14)
10.02.2023	7:15-7:15	45.0	27.1	7.3	22.6	BDL(DL:5.0)	BDL(DL:1.0)	BDL(DL:1.14)
16.02.2023	7:00-7:00	46.3	25.6	6.4	23.5	BDL(DL:5.0)	BDL(DL:1.0)	BDL(DL:1.14)
17.02.2023	7:15-7:15	47.2	26.1	7.3	22.4	BDL(DL:5.0)	BDL(DL:1.0)	BDL(DL:1.14)
23.02.2023	7:00-7:00	48.4	27.3	7.5	23.6	BDL(DL:5.0)	BDL(DL:1.0)	BDL(DL:1.14)
24.02.2023	7:15-7:15	49.0	26.6	6.8	22.5	BDL(DL:5.0)	BDL(DL:1.0)	BDL(DL:1.14)
NAAQ* S	tandard	<100	<60	<80	<80	<100	<400	<4

Note: BDL: Below Detection Limit ;DL: Detection Limit

Remarks: The values observed for the pollutants given above are within the CPCB standards.

Verified by





Authorised Signatory

Name: Santhosh Kumar A Designation: Quality Manager

Note: 1. The test results are only to the sample submitted for test. 2. Any correction of the test report in full or part shall invalidate the report. 3. Sample will be retained for 15 days from the date of reporting except in case of regulatory samples or specifically instructed by client.



TEST REPORT

Report No	EHS360/TR/2022-23/002	Report Date	02.03.2023			
Site Location	Tvl. SRI RAJALAKSHMI SAMAPPA ROUGH STONE & GRAVEL QUARRY S.F.Nos. 1120/2 & 1121/2,Bilichi Village, Coimbatore North Taluk,					
	Coimbatore District. Cluster Extent:	7.23.0 ha				
Sampling Method	IS 5182	Sample Drawn by	Laboratory			
Sample Name	Air	Sample Code	EHS360/002			
Sample Description	Ambient Air Quality Monitoring Sample Condition Good					
Sampling Location AAQ 2 – Onnipalayam - 11°12'26.87"N 77°0'7.67"E						

Date	Period. hrs	SPM (μg/m³)	As (ng/m³)	C6H6 (μg/m³)	Bap (ng/m³)	Pb (μg/m³)	Ni (ng/m³)
01.12.2022	7:00-7:00	60.3	BDL (DL:0.1)	BDL (DL:1.0)	BDL (DL:1.0)	BDL (DL:0.1)	BDL (DL:0.1)
02.12.2022	7:15-7:15	62.5	BDL (DL:0.1)	BDL (DL:1.0)	BDL (DL:1.0)	BDL (DL:0.1)	BDL (DL:0.1)
08.12.2022	7:00-7:00	63.5	BDL (DL:0.1)	BDL (DL:1.0)	BDL (DL:1.0)	BDL (DL:0.1)	BDL (DL:0.1)
09.12.2022	7:15-7:15	64.2	BDL (DL:0.1)	BDL (DL:1.0)	BDL (DL:1.0)	BDL (DL:0.1)	BDL (DL:0.1)
15.12.2022	7:00-7:00	65.2	BDL (DL:0.1)	BDL (DL:1.0)	BDL (DL:1.0)	BDL (DL:0.1)	BDL (DL:0.1)
16.12.2022	7:15-7:15	63.0	BDL (DL:0.1)	BDL (DL:1.0)	BDL (DL:1.0)	BDL (DL:0.1)	BDL (DL:0.1)
22.12.2022	7:00-7:00	62.5	BDL (DL:0.1)	BDL (DL:1.0)	BDL (DL:1.0)	BDL (DL:0.1)	BDL (DL:0.1)
23.12.2022	7:15-7:15	61.5	BDL (DL:0.1)	BDL (DL:1.0)	BDL (DL:1.0)	BDL (DL:0.1)	BDL (DL:0.1)
29.12.2022	7:00-7:00	62.5	BDL (DL:0.1)	BDL (DL:1.0)	BDL (DL:1.0)	BDL (DL:0.1)	BDL (DL:0.1)
30.12.2022	7:15-7:15	63.4	BDL (DL:0.1)	BDL (DL:1.0)	BDL (DL:1.0)	BDL (DL:0.1)	BDL (DL:0.1)
05.01.2023	7:00-7:00	61.0	BDL (DL:0.1)	BDL (DL:1.0)	BDL (DL:1.0)	BDL (DL:0.1)	BDL (DL:0.1)
06.01.2023	7:15-7:15	62.2	BDL (DL:0.1)	BDL (DL:1.0)	BDL (DL:1.0)	BDL (DL:0.1)	BDL (DL:0.1)
12.01.2023	7:00-7:00	64.3	BDL (DL:0.1)	BDL (DL:1.0)	BDL (DL:1.0)	BDL (DL:0.1)	BDL (DL:0.1)
13.01.2023	7:15-7:15	65.2	BDL (DL:0.1)	BDL (DL:1.0)	BDL (DL:1.0)	BDL (DL:0.1)	BDL (DL:0.1)
19.01.2023	7:00-7:00	64.8	BDL (DL:0.1)	BDL (DL:1.0)	BDL (DL:1.0)	BDL (DL:0.1)	BDL (DL:0.1)
20.01.2023	7:15-7:15	63.2	BDL (DL:0.1)	BDL (DL:1.0)	BDL (DL:1.0)	BDL (DL:0.1)	BDL (DL:0.1)
26.01.2023	7:00-7:00	62.5	BDL (DL:0.1)	BDL (DL:1.0)	BDL (DL:1.0)	BDL (DL:0.1)	BDL (DL:0.1)
27.01.2023	7:15-7:15	63.0	BDL (DL:0.1)	BDL (DL:1.0)	BDL (DL:1.0)	BDL (DL:0.1)	BDL (DL:0.1)
02.02.2023	7:00-7:00	64.5	BDL (DL:0.1)	BDL (DL:1.0)	BDL (DL:1.0)	BDL (DL:0.1)	BDL (DL:0.1)
03.02.2023	7:15-7:15	62.3	BDL (DL:0.1)	BDL (DL:1.0)	BDL (DL:1.0)	BDL (DL:0.1)	BDL (DL:0.1)
09.02.2023	7:00-7:00	63.4	BDL (DL:0.1)	BDL (DL:1.0)	BDL (DL:1.0)	BDL (DL:0.1)	BDL (DL:0.1)
10.02.2023	7:15-7:15	62.2	BDL (DL:0.1)	BDL (DL:1.0)	BDL (DL:1.0)	BDL (DL:0.1)	BDL (DL:0.1)
16.02.2023	7:00-7:00	63.3	BDL (DL:0.1)	BDL (DL:1.0)	BDL (DL:1.0)	BDL (DL:0.1)	BDL (DL:0.1)
17.02.2023	7:15-7:15	63.5	BDL (DL:0.1)	BDL (DL:1.0)	BDL (DL:1.0)	BDL (DL:0.1)	BDL (DL:0.1)
23.02.2023	7:00-7:00	64.2	BDL (DL:0.1)	BDL (DL:1.0)	BDL (DL:1.0)	BDL (DL:0.1)	BDL (DL:0.1)
24.02.2023	7:15-7:15	63.2	BDL (DL:0.1)	BDL (DL:1.0)	BDL (DL:1.0)	BDL (DL:0.1)	BDL (DL:0.1)
NAAQ* St		<200	6	5	1	1	20

Note: BDL: Below Detection Limit; DL: Detection Limit

Remarks: The values observed for the pollutants given above are within the CPCB standards.

Verified by

Selyk



Authorised Signatory

Name : Santhosh Kumar A
Designation : Quality Manager

Note: 1. The test results are only to the sample submitted for test. 2. Any correction of the test report in full or part shall invalidate the report.

3. Sample will be retained for 15 days from the date of reporting except in case of regulatory samples or specifically instructed by client.





Report No	EHS360/TR/2022-23/003	Report Date	02.03.2023				
	Tvi. SRI RAJALAKSHMI SAMAPPA R						
Site Location	S.F.Nos. 1120/2 & 1121/2,Bilichi Villa		k,				
	Coimbatore District. Cluster Extent: 7.23.0 ha						
Sampling Method	IS 5182	Sample Drawn by	Laboratory				
Sample Name	Air	Sample Code	EHS360/003				
Sample Description	Ambient Air Quality Monitoring	Ambient Air Quality Monitoring Sample Condition Good					
Sampling Location	n AAQ3 – Kallipalayam - 11°10'44.19"N 76°59'22.55"E						

Date	Period. hrs	PM10(μg/m ³)	$PM2.5(\mu g/m^3)$	SO2 (μg/m ³)	NO2 (μ g/m ³)	O3 (μg/m ³)	NH3 (μg/m³)	CO (mg/ m ³)
01.12.2022	7:00-7:00	44.2	23.5	6.2	20.5	BDL(DL:5.0)	BDL(DL:1.0)	BDL(DL:1.14)
02.12.2022	7:15-7:15	46.1	23.8	5.5	19.2	BDL(DL:5.0)	BDL(DL:1.0)	BDL(DL:1.14)
08.12.2022	7:00-7:00	45.2	24.2	6.3	21.3	BDL(DL:5.0)	BDL(DL:1.0)	BDL(DL:1.14)
09.12.2022	7:15-7:15	43.1	23.0	7.0	20.8	BDL(DL:5.0)	BDL(DL:1.0)	BDL(DL:1.14)
15.12.2022	7:00-7:00	47.2	25.4	5.8	21.3	BDL(DL:5.0)	BDL(DL:1.0)	BDL(DL:1.14)
16.12.2022	7:15-7:15	48.0	23.8	6.2	20.5	BDL(DL:5.0)	BDL(DL:1.0)	BDL(DL:1.14)
22.12.2022	7:00-7:00	46.2	24.2	7.2	19.5	BDL(DL:5.0)	BDL(DL:1.0)	BDL(DL:1.14)
23.12.2022	7:15-7:15	45.3	25.6	6.3	21.6	BDL(DL:5.0)	BDL(DL:1.0)	BDL(DL:1.14)
29.12.2022	7:00-7:00	43.1	23.1	5.5	21.3	BDL(DL:5.0)	BDL(DL:1.0)	BDL(DL:1.14)
30.12.2022	7:15-7:15	44.5	25.4	6.2	19.0	BDL(DL:5.0)	BDL(DL:1.0)	BDL(DL:1.14)
05.01.2023	7:00-7:00	46.3	23.2	7.2	20.3	BDL(DL:5.0)	BDL(DL:1.0)	BDL(DL:1.14)
06.01.2023	7:15-7:15	47.1	25.2	6.0	21.5	BDL(DL:5.0)	BDL(DL:1.0)	BDL(DL:1.14)
12.01.2023	7:00-7:00	48.3	24.6	5.8	20.6	BDL(DL:5.0)	BDL(DL:1.0)	BDL(DL:1.14)
13.01.2023	7:15-7:15	44.5	23.4	5.3	19.6	BDL(DL:5.0)	BDL(DL:1.0)	BDL(DL:1.14)
19.01.2023	7:00-7:00	45.1	25.5	6.4	21.4	BDL(DL:5.0)	BDL(DL:1.0)	BDL(DL:1.14)
20.01.2023	7:15-7:15	46.3	23.6	6.8	20.3	BDL(DL:5.0)	BDL(DL:1.0)	BDL(DL:1.14)
26.01.2023	7:00-7:00	44.0	24.1	7.0	21.6	BDL(DL:5.0)	BDL(DL:1.0)	BDL(DL:1.14)
27.01.2023	7:15-7:15	46.2	25.3	7.8	19.5	BDL(DL:5.0)	BDL(DL:1.0)	BDL(DL:1.14)
02.02.2023	7:00-7:00	45.3	24.1	6.3	20.6	BDL(DL:5.0)	BDL(DL:1.0)	BDL(DL:1.14)
03.02.2023	7:15-7:15	44.3	25.3	5.2	21.3	BDL(DL:5.0)	BDL(DL:1.0)	BDL(DL:1.14)
09.02.2023	7:00-7:00	48.0	23.2	6.3	19.6	BDL(DL:5.0)	BDL(DL:1.0)	BDL(DL:1.14)
10.02.2023	7:15-7:15	46.2	24.1	7.4	21.6	BDL(DL:5.0)	BDL(DL:1.0)	BDL(DL:1.14)
16.02.2023	7:00-7:00	47.2	25.3	6.8	19.0	BDL(DL:5.0)	BDL(DL:1.0)	BDL(DL:1.14)
17.02.2023	7:15-7:15	45.3	22.3	8.2	21.5	BDL(DL:5.0)	BDL(DL:1.0)	BDL(DL:1.14)
23.02.2023	7:00-7:00	44.1	24.1	7.9	20.5	BDL(DL:5.0)	BDL(DL:1.0)	BDL(DL:1.14)
24.02.2023	7:15-7:15	45.3	25.6	8.0	21.0	BDL(DL:5.0)	BDL(DL:1.0)	BDL(DL:1.14)
NAAQ* S	tandard	<100	<60	<80	<80	<100	<400	<4

Note: BDL: Below Detection Limit ;DL: Detection Limit

Remarks: The values observed for the pollutants given above are within the CPCB standards.

Verified by



Page 1 of 4 CHENNAI 600 083

Authorised Signatory

Name : Santhosh Kumar A Designation : Quality Manager

Note: 1. The test results are only to the sample submitted for test. 2. Any correction of the test report in full or part shall invalidate the report.

3. Sample will be retained for 15 days from the date of reporting except in case of regulatory samples or specifically instructed by client.



Report No	EHS360/TR/2022-23/003	Report Date	02.03.2023			
Site Location	Tvl. SRI RAJALAKSHMI SAMAPPA ROUGH STONE & GRAVEL QUARRY S.F.Nos. 1120/2 & 1121/2,Bilichi Village, Coimbatore North Taluk, Coimbatore District. Cluster Extent: 7.23.0 ha					
Sampling Method	IS 5182	Sample Drawn by	Laboratory			
Sample Name	Air	Sample Code	EHS360/003			
Sample Description	Ambient Air Quality Monitoring Sample Condition Good					
Sampling Location AAQ3 - Kallipalayam - 11°10'44.19"N 76°59'22.55"E						

Date	Period. hrs	SPM (µg/m³)	As (ng/m³)	C6H6 (μg/m³)	Bap (ng/m³)	Pb (μg/m³)	Ni (ng/m³)
01.12.2022	7:00-7:00	63.5	BDL (DL:0.1)	BDL (DL:1.0)	BDL (DL:1.0)	BDL (DL:0.1)	BDL (DL:0.1)
02.12.2022	7:15-7:15	65.5	BDL (DL:0.1)	BDL (DL:1.0)	BDL (DL:1.0)	BDL (DL:0.1)	BDL (DL:0.1)
08.12.2022	7:00-7:00	64.2	BDL (DL:0.1)	BDL (DL:1.0)	BDL (DL:1.0)	BDL (DL:0.1)	BDL (DL:0.1)
09.12.2022	7:15-7:15	61.3	BDL (DL:0.1)	BDL (DL:1.0)	BDL (DL:1.0)	BDL (DL:0.1)	BDL (DL:0.1)
15.12.2022	7:00-7:00	62.5	BDL (DL:0.1)	BDL (DL:1.0)	BDL (DL:1.0)	BDL (DL:0.1)	BDL (DL:0.1)
16.12.2022	7:15-7:15	64.3	BDL (DL:0.1)	BDL (DL:1.0)	BDL (DL:1.0)	BDL (DL:0.1)	BDL (DL:0.1)
22.12.2022	7:00-7:00	62.0	BDL (DL:0.1)	BDL (DL:1.0)	BDL (DL:1.0)	BDL (DL:0.1)	BDL (DL:0.1)
23.12.2022	7:15-7:15	63.4	BDL (DL:0.1)	BDL (DL:1.0)	BDL (DL:1.0)	BDL (DL:0.1)	BDL (DL:0.1)
29.12.2022	7:00-7:00	62.0	BDL (DL:0.1)	BDL (DL:1.0)	BDL (DL:1.0)	BDL (DL:0.1)	BDL (DL:0.1)
30.12.2022	7:15-7:15	61.0	BDL (DL:0.1)	BDL (DL:1.0)	BDL (DL:1.0)	BDL (DL:0.1)	BDL (DL:0.1)
05.01.2023	7:00-7:00	62.3	BDL (DL:0.1)	BDL (DL:1.0)	BDL (DL:1.0)	BDL (DL:0.1)	BDL (DL:0.1)
06.01.2023	7:15-7:15	64.1	BDL (DL:0.1)	BDL (DL:1.0)	BDL (DL:1.0)	BDL (DL:0.1)	BDL (DL:0.1)
12.01.2023	7:00-7:00	63.5	BDL (DL:0.1)	BDL (DL:1.0)	BDL (DL:1.0)	BDL (DL:0.1)	BDL (DL:0.1)
13.01.2023	7:15-7:15	61.2	BDL (DL:0.1)	BDL (DL:1.0)	BDL (DL:1.0)	BDL (DL:0.1)	BDL (DL:0.1)
19.01.2023	7:00-7:00	63.5	BDL (DL:0.1)	BDL (DL:1.0)	BDL (DL:1.0)	BDL (DL:0.1)	BDL (DL:0.1)
20.01.2023	7:15-7:15	62.5	BDL (DL:0.1)	BDL (DL:1.0)	BDL (DL:1.0)	BDL (DL:0.1)	BDL (DL:0.1)
26.01.2023	7:00-7:00	61.4	BDL (DL:0.1)	BDL (DL:1.0)	BDL (DL:1.0)	BDL (DL:0.1)	BDL (DL:0.1)
27.01.2023	7:15-7:15	62.5	BDL (DL:0.1)	BDL (DL:1.0)	BDL (DL:1.0)	BDL (DL:0.1)	BDL (DL:0.1)
02.02.2023	7:00-7:00	63.5	BDL (DL:0.1)	BDL (DL:1.0)	BDL (DL:1.0)	BDL (DL:0.1)	BDL (DL:0.1)
03.02.2023	7:15-7:15	64.2	BDL (DL:0.1)	BDL (DL:1.0)	BDL (DL:1.0)	BDL (DL:0.1)	BDL (DL:0.1)
09.02.2023	7:00-7:00	62.3	BDL (DL:0.1)	BDL (DL:1.0)	BDL (DL:1.0)	BDL (DL:0.1)	BDL (DL:0.1)
10.02.2023	7:15-7:15	63.5	BDL (DL:0.1)	BDL (DL:1.0)	BDL (DL:1.0)	BDL (DL:0.1)	BDL (DL:0.1)
16.02.2023	7:00-7:00	64.1	BDL (DL:0.1)	BDL (DL:1.0)	BDL (DL:1.0)	BDL (DL:0.1)	BDL (DL:0.1)
17.02.2023	7:15-7:15	62.3	BDL (DL:0.1)	BDL (DL:1.0)	BDL (DL:1.0)	BDL (DL:0.1)	BDL (DL:0.1)
23.02.2023	7:00-7:00	64.5	BDL (DL:0.1)	BDL (DL:1.0)	BDL (DL:1.0)	BDL (DL:0.1)	BDL (DL:0.1)
24.02.2023	7:15-7:15	63.2	BDL (DL:0.1)	BDL (DL:1.0)	BDL (DL:1.0)	BDL (DL:0.1)	BDL (DL:0.1)
NAAQ* St	andard	<200	6	5	1	1	20

Note: BDL: Below Detection Limit; DL: Detection Limit

Remarks: The values observed for the pollutants given above are within the CPCB standards.

**********End of Report*******

Verified by

Seligh

Authorised Signatory

Name: Santhosh Kumar A Designation: Quality Manager

Note: 1. The test results are only to the sample submitted for test. 2.Any correction of the test report in full or part shall invalidate the report.

3. Sample will be retained for 15 days from the date of reporting except in case of regulatory samples or specifically instructed by client.

CHENNAL

600 083





TEST REPORT

Report No	EHS360/TR/2022-23/004	Report Date	02.03.2023					
Site Location	S.F.Nos. 1120/2 & 1121/2,Bilichi Villa	vl. SRI RAJALAKSHMI SAMAPPA ROUGH STONE & GRAVEL QUARRY F.F.Nos. 1120/2 & 1121/2,Bilichi Village, Coimbatore North Taluk, Coimbatore District. Cluster Extent: 7.23.0 ha						
Sampling Method	IS 5182	Sample Drawn by	Laboratory					
Sample Name	Air	Sample Code	EHS360/004					
Sample Description	Ambient Air Quality Monitoring	Ambient Air Quality Monitoring Sample Condition Good						
Sampling Location	AAQ4 - Muthalipalayam - 11°10'19.43"N 77°2'38.39"E							

Date	Period. hrs	PM10(μg/m³)	PM2.5(μg/m ³)	SO2 (μg/m ³)	NO2 (μg/m ³)	O3 (μg/m³)	NH3 (μg/m³)	CO (mg/ m ³)
01.12.2022	7:00-7:00	43.2	22.3	5.5	22.5	BDL(DL:5.0)	BDL(DL:1.0)	BDL(DL:1.14)
02.12.2022	7:15-7:15	42.2	23.6	6.0	21.3	BDL(DL:5.0)	BDL(DL:1.0)	BDL(DL:1.14)
08.12.2022	7:00-7:00	43.0	26.3	5.2	20.2	BDL(DL:5.0)	BDL(DL:1.0)	BDL(DL:1.14)
09.12.2022	7:15-7:15	44.5	27.1	6.3	20.0	BDL(DL:5.0)	BDL(DL:1.0)	BDL(DL:1.14)
15.12.2022	7:00-7:00	45.5	22.5	5.2	21.5	BDL(DL:5.0)	BDL(DL:1.0)	BDL(DL:1.14)
16.12.2022	7:15-7:15	46.2	23.0	6.4	22.3	BDL(DL:5.0)	BDL(DL:1.0)	BDL(DL:1.14)
22.12.2022	7:00-7:00	44.2	24.5	5.8	23.4	BDL(DL:5.0)	BDL(DL:1.0)	BDL(DL:1.14)
23.12.2022	7:15-7:15	42.5	25.6	6.0	22.6	BDL(DL:5.0)	BDL(DL:1.0)	BDL(DL:1.14)
29.12.2022	7:00-7:00	43.6	24.3	5.2	22.8	BDL(DL:5.0)	BDL(DL:1.0)	BDL(DL:1.14)
30.12.2022	7:15-7:15	45.1	25.0	6.3	23.4	BDL(DL:5.0)	BDL(DL:1.0)	BDL(DL:1.14)
05.01.2023	7:00-7:00	46.2	22.3	5.1	22.1	BDL(DL:5.0)	BDL(DL:1.0)	BDL(DL:1.14)
06.01.2023	7:15-7:15	43.6	23.5	6.4	23.4	BDL(DL:5.0)	BDL(DL:1.0)	BDL(DL:1.14)
12.01.2023	7:00-7:00	44.2	24.3	6.0	22.0	BDL(DL:5.0)	BDL(DL:1.0)	BDL(DL:1.14)
13.01.2023	7:15-7:15	45.1	26.5	5.8	23.4	BDL(DL:5.0)	BDL(DL:1.0)	BDL(DL:1.14)
19.01.2023	7:00-7:00	46.3	27.1	6.4	22.6	BDL(DL:5.0)	BDL(DL:1.0)	BDL(DL:1.14)
20.01.2023	7:15-7:15	44.2	25.2	6.3	23.5	BDL(DL:5.0)	BDL(DL:1.0)	BDL(DL:1.14)
26.01.2023	7:00-7:00	46.3	26.3	6.2	24.5	BDL(DL:5.0)	BDL(DL:1.0)	BDL(DL:1.14)
27.01.2023	7:15-7:15	45.1	27.4	6.4	20.5	BDL(DL:5.0)	BDL(DL:1.0)	BDL(DL:1.14)
02.02.2023	7:00-7:00	44.2	26.3	6.1	22.3	BDL(DL:5.0)	BDL(DL:1.0)	BDL(DL:1.14)
03.02.2023	7:15-7:15	42.3	24.1	5.2	21.6	BDL(DL:5.0)	BDL(DL:1.0)	BDL(DL:1.14)
09.02.2023	7:00-7:00	43.1	22.3	5.3	23.4	BDL(DL:5.0)	BDL(DL:1.0)	BDL(DL:1.14)
10.02.2023	7:15-7:15	44.5	25.8	6.4	25.6	BDL(DL:5.0)	BDL(DL:1.0)	BDL(DL:1.14)
16.02.2023	7:00-7:00	45.6	26.5	5.8	20.5	BDL(DL:5.0)	BDL(DL:1.0)	BDL(DL:1.14)
17.02.2023	7:15-7:15	46.3	25.0	6.2	21.3	BDL(DL:5.0)	BDL(DL:1.0)	BDL(DL:1.14)
23.02.2023	7:00-7:00	42.3	24.6	6.4	22.5	BDL(DL:5.0)	BDL(DL:1.0)	BDL(DL:1.14)
24.02.2023	7:15-7:15	44.5	23.1	5.5	23.6	BDL(DL:5.0)	BDL(DL:1.0)	BDL(DL:1.14)
NAAQ* S	tandard	<100	<60	<80	<80	<100	<400	<4

Note: BDL: Below Detection Limit ;DL: Detection Limit

Remarks: The values observed for the pollutants given above are within the CPCB standards.

Verified by

Selyk



Designation : Quality Manager

Note: 1. The test results are only to the sample submitted for test. 2. Any correction of the test report in full or part shall invalidate the report.

3. Sample will be retained for 15 days from the date of reporting except in case of regulatory samples or specifically instructed by client.



Report No	EHS360/TR/2022-23/004	Report Date	02.03.2023				
014 - 1	Tvi. SRI RAJALAKSHMI SAMAPPA ROUGH STONE & GRAVEL QUARRY						
Site Location	S.F.Nos. 1120/2 & 1121/2, Bilichi Villag		,				
	Coimbatore District. Cluster Extent:	7.23.0 ha					
Sampling Method	IS 5182	Sample Drawn by	Laboratory				
Sample Name	Air	Sample Code	EHS360/004				
Sample Description	Ambient Air Quality Monitoring Sample Condition Good						
Sampling Location	Location AAQ4 Muthalipalayam - 11°10'19.43"N 77°2'38.39"E						

Date	Period. hrs	SPM (μg/m³)	As (ng/m³)	С6H6 (µg/m³)	BaP (ng/m³)	Pb (μg/m³)	Ni (ng/m³)
01.12.2022	7:00-7:00	65.5	BDL (DL:0.1)	BDL (DL:1.0)	BDL (DL:1.0)	BDL (DL:0.1)	BDL (DL:0.1)
02.12.2022	7:15-7:15	66.3	BDL (DL:0.1)	BDL (DL:1.0)	BDL (DL:1.0)	BDL (DL:0.1)	BDL (DL:0.1)
08.12.2022	7:00-7:00	67.2	BDL (DL:0.1)	BDL (DL:1.0)	BDL (DL:1.0)	BDL (DL:0.1)	BDL (DL:0.1)
09.12.2022	7:15-7:15	64.3	BDL (DL:0.1)	BDL (DL:1.0)	BDL (DL:1.0)	BDL (DL:0.1)	BDL (DL:0.1)
15.12.2022	7:00-7:00	66.3	BDL (DL:0.1)	BDL (DL:1.0)	BDL (DL:1.0)	BDL (DL:0.1)	BDL (DL:0.1)
16.12.2022	7:15-7:15	65.3	BDL (DL:0.1)	BDL (DL:1.0)	BDL (DL:1.0)	BDL (DL:0.1)	BDL (DL:0.1)
22.12.2022	7:00-7:00	66.4	BDL (DL:0.1)	BDL (DL:1.0)	BDL (DL:1.0)	BDL (DL:0.1)	BDL (DL:0.1)
23.12.2022	7:15-7:15	65.0	BDL (DL:0.1)	BDL (DL:1.0)	BDL (DL:1.0)	BDL (DL:0.1)	BDL (DL:0.1)
29.12.2022	7:00-7:00	64.3	BDL (DL:0.1)	BDL (DL:1.0)	BDL (DL:1.0)	BDL (DL:0.1)	BDL (DL:0.1)
30.12.2022	7:15-7:15	65.2	BDL (DL:0.1)	BDL (DL:1.0)	BDL (DL:1.0)	BDL (DL:0.1)	BDL (DL:0.1)
05.01.2023	7:00-7:00	65.0	BDL (DL:0.1)	BDL (DL:1.0)	BDL (DL:1.0)	BDL (DL:0.1)	BDL (DL:0.1)
06.01.2023	7:15-7:15	64.8	BDL (DL:0.1)	BDL (DL:1.0)	BDL (DL:1.0)	BDL (DL:0.1)	BDL (DL:0.1)
12.01.2023	7:00-7:00	66.2	BDL (DL:0.1)	BDL (DL:1.0)	BDL (DL:1.0)	BDL (DL:0.1)	BDL (DL:0.1)
13.01.2023	7:15-7:15	67.3	BDL (DL:0.1)	BDL (DL:1.0)	BDL (DL:1.0)	BDL (DL:0.1)	BDL (DL:0.1)
19.01.2023	7:00-7:00	66.3	BDL (DL:0.1)	BDL (DL:1.0)	BDL (DL:1.0)	BDL (DL:0.1)	BDL (DL:0.1)
20.01.2023	7:15-7:15	67.1	BDL (DL:0.1)	BDL (DL:1.0)	BDL (DL:1.0)	BDL (DL:0.1)	BDL (DL:0.1)
26.01.2023	7:00-7:00	67.8	BDL (DL:0.1)	BDL (DL:1.0)	BDL (DL:1.0)	BDL (DL:0.1)	BDL (DL:0.1)
27.01.2023	7:15-7:15	65.3	BDL (DL:0.1)	BDL (DL:1.0)	BDL (DL:1.0)	BDL (DL:0.1)	BDL (DL:0.1)
02.02.2023	7:00-7:00	66.4	BDL (DL:0.1)	BDL (DL:1.0)	BDL (DL:1.0)	BDL (DL:0.1)	BDL (DL:0.1)
03.02.2023	7:15-7:15	67.3	BDL (DL:0.1)	BDL (DL:1.0)	BDL (DL:1.0)	BDL (DL:0.1)	BDL (DL:0.1)
09.02.2023	7:00-7:00	64.2	BDL (DL:0.1)	BDL (DL:1.0)	BDL (DL:1.0)	BDL (DL:0.1)	BDL (DL:0.1)
10.02.2023	7:15-7:15	63.5	BDL (DL:0.1)	BDL (DL:1.0)	BDL (DL:1.0)	BDL (DL:0.1)	BDL (DL:0.1)
16.02.2023	7:00-7:00	66.4	BDL (DL:0.1)	BDL (DL:1.0)	BDL (DL:1.0)	BDL (DL:0.1)	BDL (DL:0.1)
17.02.2023	7:15-7:15	67.3	BDL (DL:0.1)	BDL (DL:1.0)	BDL (DL:1.0)	BDL (DL:0.1)	BDL (DL:0.1)
23.02.2023	7:00-7:00	66.3	BDL (DL:0.1)	BDL (DL:1.0)	BDL (DL:1.0)	BDL (DL:0.1)	BDL (DL:0.1)
24.02.2023	7:15-7:15	65.2	BDL (DL:0.1)	BDL (DL:1.0)	BDL (DL:1.0)	BDL (DL:0.1)	BDL (DL:0.1)
NAAQ* St		<200	6	5	1	1	20

Note: BDL: Below Detection Limit; DL: Detection Limit

Remarks: The values observed for the pollutants given above are within the CPCB standards.

Verified by

Skyk



Authorised Signatory

Name: Santhosh Kumar A
Designation: Quality Manager

Note: 1. The test results are only to the sample submitted for test. 2. Any correction of the test report in full or part shall invalidate the report.

3. Sample will be retained for 15 days from the date of reporting except in case of regulatory samples or specifically instructed by client.





	_							
Report No	EHS360/TR/2022-23/005	Report Date	02.03.2023					
	Tvi. SRI RAJALAKSHMI SAMAPPA	ROUGH STONE & GRAVEL	QUARRY					
Site Location	S.F.Nos. 1120/2 & 1121/2,Bilichi Vill	S.F.Nos. 1120/2 & 1121/2, Bilichi Village, Coimbatore North Taluk,						
	Coimbatore District. Cluster Extent: 7.23.0 ha							
Sampling Method	IS 5182	Sample Drawn by	Laboratory					
Sample Name	Air	Sample Code	EHS360/005					
Sample Description	Ambient Air Quality Monitoring	Ambient Air Quality Monitoring Sample Condition Good						
Sampling Location	ng Location							

Date	Period. hrs	PM10(μg/m³)	PM2.5(μg/m ³)	SO2 (μg/m ³)	NO2 (μg/m ³)	O3 (μg/m³)	NH3 (μg/m³)	CO (mg/ m ³)
01.12.2022	7:00-7:00	45.5	24.3	7.2	20.5	BDL(DL:5.0)	BDL(DL:1.0)	BDL(DL:1.14)
02.12.2022	7:15-7:15	46.3	23.1	6.0	22.3	BDL(DL:5.0)	BDL(DL:1.0)	BDL(DL:1.14)
08.12.2022	7:00-7:00	44.2	22.1	7.8	21.1	BDL(DL:5.0)	BDL(DL:1.0)	BDL(DL:1.14)
09.12.2022	7:15-7:15	42.3	21.0	6.2	19.5	BDL(DL:5.0)	BDL(DL:1.0)	BDL(DL:1.14)
15.12.2022	7:00-7:00	46.3	23.1	7.2	20.5	BDL(DL:5.0)	BDL(DL:1.0)	BDL(DL:1.14)
16.12.2022	7:15-7:15	44.5	22.5	6.0	22.3	BDL(DL:5.0)	BDL(DL:1.0)	BDL(DL:1.14)
22.12.2022	7:00-7:00	43.2	24.6	7.1	20.1	BDL(DL:5.0)	BDL(DL:1.0)	BDL(DL:1.14)
23.12.2022	7:15-7:15	46.5	25.0	7.5	18.3	BDL(DL:5.0)	BDL(DL:1.0)	BDL(DL:1.14)
29.12.2022	7:00-7:00	47.1	21.2	8.2	19.5	BDL(DL:5.0)	BDL(DL:1.0)	BDL(DL:1.14)
30.12.2022	7:15-7:15	45.3	22.5	6.2	20.3	BDL(DL:5.0)	BDL(DL:1.0)	BDL(DL:1.14)
05.01.2023	7:00-7:00	46.2	23.5	7.3	18.5	BDL(DL:5.0)	BDL(DL:1.0)	BDL(DL:1.14)
06.01.2023	7:15-7:15	43.2	24.3	8.1	19.3	BDL(DL:5.0)	BDL(DL:1.0)	BDL(DL:1.14)
12.01.2023	7:00-7:00	44.6	25.2	6.3	20.4	BDL(DL:5.0)	BDL(DL:1.0)	BDL(DL:1.14)
13.01.2023	7:15-7:15	45.3	22.3	8.1	19.5	BDL(DL:5.0)	BDL(DL:1.0)	BDL(DL:1.14)
19.01.2023	7:00-7:00	46.3	23.5	7.5	20.5	BDL(DL:5.0)	BDL(DL:1.0)	BDL(DL:1.14)
20.01.2023	7:15-7:15	47.2	24.1	8.3	18.6	BDL(DL:5.0)	BDL(DL:1.0)	BDL(DL:1.14)
26.01.2023	7:00-7:00	43.5	25.5	7.1	21.5	BDL(DL:5.0)	BDL(DL:1.0)	BDL(DL:1.14)
27.01.2023	7:15-7:15	44.5	24.6	7.3	22.0	BDL(DL:5.0)	BDL(DL:1.0)	BDL(DL:1.14)
02.02.2023	7:00-7:00	46.3	23.1	7.2	18.5	BDL(DL:5.0)	BDL(DL:1.0)	BDL(DL:1.14)
03.02.2023	7:15-7:15	47.2	22.5	6.3	19.2	BDL(DL:5.0)	BDL(DL:1.0)	BDL(DL:1.14)
09.02.2023	7:00-7:00	44.3	23.5	6.2	22.3	BDL(DL:5.0)	BDL(DL:1.0)	BDL(DL:1.14)
10.02.2023	7:15-7:15	45.2	24.2	8.1	21.4	BDL(DL:5.0)	BDL(DL:1.0)	BDL(DL:1.14)
16.02.2023	7:00-7:00	43.1	25.3	6.3	22.3	BDL(DL:5.0)	BDL(DL:1.0)	BDL(DL:1.14)
17.02.2023	7:15-7:15	44.6	24.2	7.4	20.5	BDL(DL:5.0)	BDL(DL:1.0)	BDL(DL:1.14)
23.02.2023	7:00-7:00	45.8	23.6	8.0	22.6	BDL(DL:5.0)	BDL(DL:1.0)	BDL(DL:1.14)
24.02.2023	7:15-7:15	46.1	22.1	7.5	24.3	BDL(DL:5.0)	BDL(DL:1.0)	BDL(DL:1.14)
NAAQ* S	Standard	<100	<60	<80	<80	<100	<400	<4

Note: BDL: Below Detection Limit ;DL: Detection Limit

Remarks: The values observed for the pollutants given above are within the CPCB standards.

Verified by





Authorised Signatory

Name: Santhosh Kumar A Designation: Quality Manager

Note: 1. The test results are only to the sample submitted for test. 2.Any correction of the test report in full or part shall invalidate the report. 3. Sample will be retained for 15 days from the date of reporting except in case of regulatory samples or specifically instructed by client.



TEST REPORT

Report No	EHS360/TR/2022-23/005	Report Date	02.03.2023				
	Tvi. SRI RAJALAKSHMI SAMAPPA R						
Site Location	S.F.Nos. 1120/2 & 1121/2,Bilichi Villag						
	Coimbatore District. Cluster Extent:	Coimbatore District. Cluster Extent: 7.23.0 ha					
Sampling Method	IS 5182	Sample Drawn by	Laboratory				
Sample Name	Air	Sample Code	EHS360/005				
Sample Description	Ambient Air Quality Monitoring Sample Condition Good						
Sampling Location AAQ5 – Bettadapuram -11°13'26.14"N 76°57'26.99"E							

Date	Period. hrs	SPM (μg/m³)	As (ng/m³)	С6H6 (µg/m³)	BaP (ng/m³)	Pb (μg/m³)	Ni (ng/m³)
01.12.2022	7:00-7:00	63.5	BDL (DL:0.1)	BDL (DL:1.0)	BDL (DL:1.0)	BDL (DL:0.1)	BDL (DL:0.1)
02.12.2022	7:15-7:15	66.2	BDL (DL:0.1)	BDL (DL:1.0)	BDL (DL:1.0)	BDL (DL:0.1)	BDL (DL:0.1)
08.12.2022	7:00-7:00	65.2	BDL (DL:0.1)	BDL (DL:1.0)	BDL (DL:1.0)	BDL (DL:0.1)	BDL (DL:0.1)
09.12.2022	7:15-7:15	64.2	BDL (DL:0.1)	BDL (DL:1.0)	BDL (DL:1.0)	BDL (DL:0.1)	BDL (DL:0.1)
15.12.2022	7:00-7:00	63.1	BDL (DL:0.1)	BDL (DL:1.0)	BDL (DL:1.0)	BDL (DL:0.1)	BDL (DL:0.1)
16.12.2022	7:15-7:15	62.1	BDL (DL:0.1)	BDL (DL:1.0)	BDL (DL:1.0)	BDL (DL:0.1)	BDL (DL:0.1)
22.12.2022	7:00-7:00	64.5	BDL (DL:0.1)	BDL (DL:1.0)	BDL (DL:1.0)	BDL (DL:0.1)	BDL (DL:0.1)
23.12.2022	7:15-7:15	63.0	BDL (DL:0.1)	BDL (DL:1.0)	BDL (DL:1.0)	BDL (DL:0.1)	BDL (DL:0.1)
29.12.2022	7:00-7:00	62.1	BDL (DL:0.1)	BDL (DL:1.0)	BDL (DL:1.0)	BDL (DL:0.1)	BDL (DL:0.1)
30.12.2022	7:15-7:15	63.1	BDL (DL:0.1)	BDL (DL:1.0)	BDL (DL:1.0)	BDL (DL:0.1)	BDL (DL:0.1)
05.01.2023	7:00-7:00	64.5	BDL (DL:0.1)	BDL (DL:1.0)	BDL (DL:1.0)	BDL (DL:0.1)	BDL (DL:0.1)
06.01.2023	7:15-7:15	65.3	BDL (DL:0.1)	BDL (DL:1.0)	BDL (DL:1.0)	BDL (DL:0.1)	BDL (DL:0.1)
12.01.2023	7:00-7:00	66.2	BDL (DL:0.1)	BDL (DL:1.0)	BDL (DL:1.0)	BDL (DL:0.1)	BDL (DL:0.1)
13.01.2023	7:15-7:15	62.0	BDL (DL:0.1)	BDL (DL:1.0)	BDL (DL:1.0)	BDL (DL:0.1)	BDL (DL:0.1)
19.01.2023	7:00-7:00	63.4	BDL (DL:0.1)	BDL (DL:1.0)	BDL (DL:1.0)	BDL (DL:0.1)	BDL (DL:0.1)
20.01.2023	7:15-7:15	65.3	BDL (DL:0.1)	BDL (DL:1.0)	BDL (DL:1.0)	BDL (DL:0.1)	BDL (DL:0.1)
26.01.2023	7:00-7:00	64.2	BDL (DL:0.1)	BDL (DL:1.0)	BDL (DL:1.0)	BDL (DL:0.1)	BDL (DL:0.1)
27.01.2023	7:15-7:15	62.3	BDL (DL:0.1)	BDL (DL:1.0)	BDL (DL:1.0)	BDL (DL:0.1)	BDL (DL:0.1)
02.02.2023	7:00-7:00	66.0	BDL (DL:0.1)	BDL (DL:1.0)	BDL (DL:1.0)	BDL (DL:0.1)	BDL (DL:0.1)
03.02.2023	7:15-7:15	62.3	BDL (DL:0.1)	BDL (DL:1.0)	BDL (DL:1.0)	BDL (DL:0.1)	BDL (DL:0.1)
09.02.2023	7:00-7:00	64.1	BDL (DL:0.1)	BDL (DL:1.0)	BDL (DL:1.0)	BDL (DL:0.1)	BDL (DL:0.1)
10.02.2023	7:15-7:15	64.0	BDL (DL:0.1)	BDL (DL:1.0)	BDL (DL:1.0)	BDL (DL:0.1)	BDL (DL:0.1)
16.02.2023	7:00-7:00	63.8	BDL (DL:0.1)	BDL (DL:1.0)	BDL (DL:1.0)	BDL (DL:0.1)	BDL (DL:0.1)
17.02.2023	7:15-7:15	62.2	BDL (DL:0.1)	BDL (DL:1.0)	BDL (DL:1.0)	BDL (DL:0.1)	BDL (DL:0.1)
23.02.2023	7:00-7:00	64.1	BDL (DL:0.1)	BDL (DL:1.0)	BDL (DL:1.0)	BDL (DL:0.1)	BDL (DL:0.1)
24.02.2023	7:15-7:15	64.0	BDL (DL:0.1)	BDL (DL:1.0)	BDL (DL:1.0)	BDL (DL:0.1)	BDL (DL:0.1)
NAAQ* St		<200	6	5	1	1	20

Note: BDL: Below Detection Limit; DL: Detection Limit

Remarks: The values observed for the pollutants given above are within the CPCB standards.

Verified by

Skyk



Authorised Signatory

Name: Santhosh Kumar A
Designation: Quality Manager

Note: 1. The test results are only to the sample submitted for test. 2.Any correction of the test report in full or part shall invalidate the report.

3. Sample will be retained for 15 days from the date of reporting except in case of regulatory samples or specifically instructed by client.





TEST REPORT

4. 15 1 W 4 5 5 5 50 50 1 1 1 1 1	10.00						
Report No	EHS360/TR/2022-23/006	Report Date	02.03.2023				
	Tvi. SRI RAJALAKSHMI SAMAPPA R		UARRY				
Site Location	S.F.Nos. 1120/2 & 1121/2,Bilichi Villag						
	Coimbatore District. Cluster Extent: 7.23.0 ha						
Sampling Method	IS 5182	Sample Drawn by	Laboratory				
Sample Name	Air	Sample Code	EHS360/006				
Sample Description	Ambient Air Quality Monitoring	Sample Condition	Good				
Sampling Location AAQ 6 - Periya Puthur - 11°13'38.24"N 77°1'43.30"E							

Date	Period. hrs	PM10(μg/m³)	PM2.5(μg/m ³)	SO2 (μg/m ³)	NO2 (μg/m ³)	O3 (μg/m³)	NH3 (μg/m³)	CO (mg/ m ³)
01.12.2022	7:00-7:00	44.0	22.5	6.2	18.2	BDL(DL:5.0)	BDL(DL:1.0)	BDL(DL:1.14)
02.12.2022	7:15-7:15	45.2	23.2	7.2	19.5	BDL(DL:5.0)	BDL(DL:1.0)	BDL(DL:1.14)
08.12.2022	7:00-7:00	46.3	24.3	6.8	20.5	BDL(DL:5.0)	BDL(DL:1.0)	BDL(DL:1.14)
09.12.2022	7:15-7:15	44.2	21.0	7.0	17.2	BDL(DL:5.0)	BDL(DL:1.0)	BDL(DL:1.14)
15.12.2022	7:00-7:00	43.2	22.1	7.4	19.3	BDL(DL:5.0)	BDL(DL:1.0)	BDL(DL:1.14)
16.12.2022	7:15-7:15	43.0	25.0	6.3	17.5	BDL(DL:5.0)	BDL(DL:1.0)	BDL(DL:1.14)
22.12.2022	7:00-7:00	45.2	26.1	7.2	18.5	BDL(DL:5.0)	BDL(DL:1.0)	BDL(DL:1.14)
23.12.2022	7:15-7:15	45.0	22.3	6.8	20.2	BDL(DL:5.0)	BDL(DL:1.0)	BDL(DL:1.14)
29.12.2022	7:00-7:00	45.2	26.1	6.9	22.3	BDL(DL:5.0)	BDL(DL:1.0)	BDL(DL:1.14)
30.12.2022	7:15-7:15	46.2	23.2	7.4	17.5	BDL(DL:5.0)	BDL(DL:1.0)	BDL(DL:1.14)
05.01.2023	7:00-7:00	44.2	25.1	7.3	18.2	BDL(DL:5.0)	BDL(DL:1.0)	BDL(DL:1.14)
06.01.2023	7:15-7:15	45.2	22.8	6.2	18.0	BDL(DL:5.0)	BDL(DL:1.0)	BDL(DL:1.14)
12.01.2023	7:00-7:00	46.3	23.1	6.3	21.0	BDL(DL:5.0)	BDL(DL:1.0)	BDL(DL:1.14)
13.01.2023	7:15-7:15	45.0	22.0	7.1	22.3	BDL(DL:5.0)	BDL(DL:1.0)	BDL(DL:1.14)
19.01.2023	7:00-7:00	46.1	23.6	7.5	17.5	BDL(DL:5.0)	BDL(DL:1.0)	BDL(DL:1.14)
20.01.2023	7:15-7:15	44.2	22.1	6.8	18.2	BDL(DL:5.0)	BDL(DL:1.0)	BDL(DL:1.14)
26.01.2023	7:00-7:00	46.5	23.4	7.3	17.0	BDL(DL:5.0)	BDL(DL:1.0)	BDL(DL:1.14)
27.01.2023	7:15-7:15	44.0	22.6	6.9	22.8	BDL(DL:5.0)	BDL(DL:1.0)	BDL(DL:1.14)
02.02.2023	7:00-7:00	45.0	26.1	7.2	21.6	BDL(DL:5.0)	BDL(DL:1.0)	BDL(DL:1.14)
03.02.2023	7:15-7:15	46.3	23.4	7.0	17.2	BDL(DL:5.0)	BDL(DL:1.0)	BDL(DL:1.14)
09.02.2023	7:00-7:00	44.1	26.0	6.8	18.6	BDL(DL:5.0)	BDL(DL:1.0)	BDL(DL:1.14)
10.02.2023	7:15-7:15	44.5	23.5	6.5	19.5	BDL(DL:5.0)	BDL(DL:1.0)	BDL(DL:1.14)
16.02.2023	7:00-7:00	43.8	22.4	7.4	20.3	BDL(DL:5.0)	BDL(DL:1.0)	BDL(DL:1.14)
17.02.2023	7:15-7:15	44.2	22.1	7.3	18.6	BDL(DL:5.0)	BDL(DL:1.0)	BDL(DL:1.14)
23.02.2023	7:00-7:00	44.6	22.3	6.4	19.4	BDL(DL:5.0)	BDL(DL:1.0)	BDL(DL:1.14)
24.02.2023	7:15-7:15	45.3	24.1	6.6	20.6	BDL(DL:5.0)	BDL(DL:1.0)	BDL(DL:1.14)
NAAQ* S	tandard	<100	<60	<80	<80	<100	<400	<4

Note: BDL: Below Detection Limit ;DL: Detection Limit

Remarks: The values observed for the pollutants given above are within the CPCB standards.

Verified by

End of Report******* CHENNAL 600 083

Authorised Signatory Name: Santhosh Kumar A

Designation: Quality Manager

Note: 1. The test results are only to the sample submitted for test. 2.Any correction of the test report in full or part shall invalidate the report. 3. Sample will be retained for 15 days from the date of reporting except in case of regulatory samples or specifically instructed by client.



Report No	EHS360/TR/2022-23/006	Report Date	02.03.2023				
Site Leastion	TVI. SRI RAJALAKSHMI SAMAPPA ROUGH STONE & GRAVEL QUARRY						
Site Location	S.F.Nos. 1120/2 & 1121/2,Bilichi Village, Coimbatore North Taluk, Coimbatore District. Cluster Extent: 7.23.0 ha						
Sampling Method	IS 5182	Sample Drawn by	Laboratory				
Sample Name	Air	Sample Code	EHS360/006				
Sample Description	Ambient Air Quality Monitoring Sample Condition Good						
Sampling Location	ampling Location AAQ 6 - Periya Puthur - 11°13'38.24"N 77°1'43.30"E						

Date	Period. hrs	SPM (μg/m³)	As (ng/m³)	С6H6 (µg/m³)	Bap (ng/m³)	Pb (μg/m³)	Ni (ng/m³)
01.12.2022	7:00-7:00	62.5	BDL (DL:0.1)	BDL (DL:1.0)	BDL (DL:1.0)	BDL (DL:0.1)	BDL (DL:0.1)
02.12.2022	7:15-7:15	61.3	BDL (DL:0.1)	BDL (DL:1.0)	BDL (DL:1.0)	BDL (DL:0.1)	BDL (DL:0.1)
08.12.2022	7:00-7:00	60.2	BDL (DL:0.1)	BDL (DL:1.0)	BDL (DL:1.0)	BDL (DL:0.1)	BDL (DL:0.1)
09.12.2022	7:15-7:15	63.5	BDL (DL:0.1)	BDL (DL:1.0)	BDL (DL:1.0)	BDL (DL:0.1)	BDL (DL:0.1)
15.12.2022	7:00-7:00	63.0	BDL (DL:0.1)	BDL (DL:1.0)	BDL (DL:1.0)	BDL (DL:0.1)	BDL (DL:0.1)
16.12.2022	7:15-7:15	62.1	BDL (DL:0.1)	BDL (DL:1.0)	BDL (DL:1.0)	BDL (DL:0.1)	BDL (DL:0.1)
22.12.2022	7:00-7:00	64.5	BDL (DL:0.1)	BDL (DL:1.0)	BDL (DL:1.0)	BDL (DL:0.1)	BDL (DL:0.1)
23.12.2022	7:15-7:15	65.0	BDL (DL:0.1)	BDL (DL:1.0)	BDL (DL:1.0)	BDL (DL:0.1)	BDL (DL:0.1)
29.12.2022	7:00-7:00	62.3	BDL (DL:0.1)	BDL (DL:1.0)	BDL (DL:1.0)	BDL (DL:0.1)	BDL (DL:0.1)
30.12.2022	7:15-7:15	64.1	BDL (DL:0.1)	BDL (DL:1.0)	BDL (DL:1.0)	BDL (DL:0.1)	BDL (DL:0.1)
05.01.2023	7:00-7:00	65.3	BDL (DL:0.1)	BDL (DL:1.0)	BDL (DL:1.0)	BDL (DL:0.1)	BDL (DL:0.1)
06.01.2023	7:15-7:15	60.4	BDL (DL:0.1)	BDL (DL:1.0)	BDL (DL:1.0)	BDL (DL:0.1)	BDL (DL:0.1)
12.01.2023	7:00-7:00	62.3	BDL (DL:0.1)	BDL (DL:1.0)	BDL (DL:1.0)	BDL (DL:0.1)	BDL (DL:0.1)
13.01.2023	7:15-7:15	63.1	BDL (DL:0.1)	BDL (DL:1.0)	BDL (DL:1.0)	BDL (DL:0.1)	BDL (DL:0.1)
19.01.2023	7:00-7:00	64.1	BDL (DL:0.1)	BDL (DL:1.0)	BDL (DL:1.0)	BDL (DL:0.1)	BDL (DL:0.1)
20.01.2023	7:15-7:15	65.3	BDL (DL:0.1)	BDL (DL:1.0)	BDL (DL:1.0)	BDL (DL:0.1)	BDL (DL:0.1)
26.01.2023	7:00-7:00	63.5	BDL (DL:0.1)	BDL (DL:1.0)	BDL (DL:1.0)	BDL (DL:0.1)	BDL (DL:0.1)
27.01.2023	7:15-7:15	62.1	BDL (DL:0.1)	BDL (DL:1.0)	BDL (DL:1.0)	BDL (DL:0.1)	BDL (DL:0.1)
02.02.2023	7:00-7:00	64.3	BDL (DL:0.1)	BDL (DL:1.0)	BDL (DL:1.0)	BDL (DL:0.1)	BDL (DL:0.1)
03.02.2023	7:15-7:15	65.2	BDL (DL:0.1)	BDL (DL:1.0)	BDL (DL:1.0)	BDL (DL:0.1)	BDL (DL:0.1)
09.02.2023	7:00-7:00	62.3	BDL (DL:0.1)	BDL (DL:1.0)	BDL (DL:1.0)	BDL (DL:0.1)	BDL (DL:0.1)
10.02.2023	7:15-7:15	64.0	BDL (DL:0.1)	BDL (DL:1.0)	BDL (DL:1.0)	BDL (DL:0.1)	BDL (DL:0.1)
16.02.2023	7:00-7:00	65.1	BDL (DL:0.1)	BDL (DL:1.0)	BDL (DL:1.0)	BDL (DL:0.1)	BDL (DL:0.1)
17.02.2023	7:15-7:15	64.0	BDL (DL:0.1)	BDL (DL:1.0)	BDL (DL:1.0)	BDL (DL:0.1)	BDL (DL:0.1)
23.02.2023	7:00-7:00	62.3	BDL (DL:0.1)	BDL (DL:1.0)	BDL (DL:1.0)	BDL (DL:0.1)	BDL (DL:0.1)
24.02.2023	7:15-7:15	62.4	BDL (DL:0.1)	BDL (DL:1.0)	BDL (DL:1.0)	BDL (DL:0.1)	BDL (DL:0.1)
NAAQ* St	andard	<200	6	5	1	1	20

Note: BDL: Below Detection Limit; DL: Detection Limit

Remarks: The values observed for the pollutants given above are within the CPCB standards.

Verified by

Skyk



Authorised Signatory

Name: Santhosh Kumar A
Designation: Quality Manager

Note: 1. The test results are only to the sample submitted for test. 2. Any correction of the test report in full or part shall invalidate the report.

3. Sample will be retained for 15 days from the date of reporting except in case of regulatory samples or specifically instructed by client.





TEST REPORT

5. 0 T. 0	The state of the s						
Report No	EHS360/TR/2022-23/007	Report Date	02.03.2023				
Site Location	Tvl. SRI RAJALAKSHMI SAMAPPA ROUGH STONE & GRAVEL QUARRY S.F.Nos. 1120/2 & 1121/2,Bilichi Village, Coimbatore North Taluk,						
Oite Location	Coimbatore District. Cluster Extent: 7.23.0 ha						
Sampling Method	IS 5182	Sample Drawn by	Laboratory				
Sample Name	Air	Sample Code	EHS360/007				
Sample Description	Ambient Air Quality Monitoring Sample Condition Good						
Sampling Location	ation AAQ7 – Mathampalayam -11°11'53.08"N 76°57'22.51"E						

Date	Period. hrs	PM10(μg/m ³)	PM2.5(μg/m ³)	SO2 (μg/m ³)	NO2 (μg/m ³)	O3 (μg/m³)	NH3 (μg/m³)	CO (mg/ m ³)
01.12.2022	7:00-7:00	44.1	22.0	6.2	16.5	BDL(DL:5.0)	BDL(DL:1.0)	BDL(DL:1.14)
02.12.2022	7:15-7:15	43.5	22.3	6.0	17.2	BDL(DL:5.0)	BDL(DL:1.0)	BDL(DL:1.14)
08.12.2022	7:00-7:00	42.1	21.5	7.1	18.5	BDL(DL:5.0)	BDL(DL:1.0)	BDL(DL:1.14)
09.12.2022	7:15-7:15	45.3	23.2	7.2	19.3	BDL(DL:5.0)	BDL(DL:1.0)	BDL(DL:1.14)
15.12.2022	7:00-7:00	46.1	24.1	6.8	20.1	BDL(DL:5.0)	BDL(DL:1.0)	BDL(DL:1.14)
16.12.2022	7:15-7:15	47.2	22.3	7.1	22.2	BDL(DL:5.0)	BDL(DL:1.0)	BDL(DL:1.14)
22.12.2022	7:00-7:00	43.1	24.1	6.2	23.5	BDL(DL:5.0)	BDL(DL:1.0)	BDL(DL:1.14)
23.12.2022	7:15-7:15	44.6	25.3	7.4	18.5	BDL(DL:5.0)	BDL(DL:1.0)	BDL(DL:1.14)
29.12.2022	7:00-7:00	45.2	24.6	6.3	17.5	BDL(DL:5.0)	BDL(DL:1.0)	BDL(DL:1.14)
30.12.2022	7:15-7:15	46.3	26.5	7.3	16.3	BDL(DL:5.0)	BDL(DL:1.0)	BDL(DL:1.14)
05.01.2023	7:00-7:00	47.0	23.0	6.4	20.2	BDL(DL:5.0)	BDL(DL:1.0)	BDL(DL:1.14)
06.01.2023	7:15-7:15	44.5	22.4	6.5	22.5	BDL(DL:5.0)	BDL(DL:1.0)	BDL(DL:1.14)
12.01.2023	7:00-7:00	45.3	23.4	7.1	23.6	BDL(DL:5.0)	BDL(DL:1.0)	BDL(DL:1.14)
13.01.2023	7:15-7:15	43.5	22.1	7.6	19.2	BDL(DL:5.0)	BDL(DL:1.0)	BDL(DL:1.14)
19.01.2023	7:00-7:00	43.0	23.0	6.4	20.5	BDL(DL:5.0)	BDL(DL:1.0)	BDL(DL:1.14)
20.01.2023	7:15-7:15	44.2	22.1	7.3	22.4	BDL(DL:5.0)	BDL(DL:1.0)	BDL(DL:1.14)
26.01.2023	7:00-7:00	45.3	20.5	6.0	23.6	BDL(DL:5.0)	BDL(DL:1.0)	BDL(DL:1.14)
27.01.2023	7:15-7:15	46.5	23.5	7.4	22.2	BDL(DL:5.0)	BDL(DL:1.0)	BDL(DL:1.14)
02.02.2023	7:00-7:00	47.2	22.4	7.2	23.5	BDL(DL:5.0)	BDL(DL:1.0)	BDL(DL:1.14)
03.02.2023	7:15-7:15	45.0	23.2	6.5	20.3	BDL(DL:5.0)	BDL(DL:1.0)	BDL(DL:1.14)
09.02.2023	7:00-7:00	46.3	23.6	7.0	21.2	BDL(DL:5.0)	BDL(DL:1.0)	BDL(DL:1.14)
10.02.2023	7:15-7:15	47.2	24.1	7.3	22.3	BDL(DL:5.0)	BDL(DL:1.0)	BDL(DL:1.14)
16.02.2023	7:00-7:00	45.2	22.3	7.4	18.3	BDL(DL:5.0)	BDL(DL:1.0)	BDL(DL:1.14)
17.02.2023	7:15-7:15	44.2	25.1	6.2	22.1	BDL(DL:5.0)	BDL(DL:1.0)	BDL(DL:1.14)
23.02.2023	7:00-7:00	46.3	26.3	7.8	21.8	BDL(DL:5.0)	BDL(DL:1.0)	BDL(DL:1.14)
24.02.2023	7:15-7:15	47.1	22.0	6.6	22.6	BDL(DL:5.0)	BDL(DL:1.0)	BDL(DL:1.14)
NAAQ* S	tandard	<100	<60	<80	<80	<100	<400	<4

Note: BDL: Below Detection Limit ;DL: Detection Limit

Remarks: The values observed for the pollutants given above are within the CPCB standards.

Verified by

Selyk

Page 1 of CHENNAI 600 083

Authorised Signatory

A-L

Name: Santhosh Kumar A

Designation: Quality Manager

Note: 1. The test results are only to the sample submitted for test. 2.Any correction of the test report in full or part shall invalidate the report.

3. Sample will be retained for 15 days from the date of reporting except in case of regulatory samples or specifically instructed by client.



Report No	EHS360/TR/2022-23/007	Report Date	02.03.2023				
Tvi. SRI RAJALAKSHMI SAMAPPA ROUGH STONE & GRAVEL QUARRY							
Site Location	S.F.Nos. 1120/2 & 1121/2, Bilichi Village, Coimbatore North Taluk,						
	Coimbatore District. Cluster Extent: 7.23.0 ha						
Sampling Method	IS 5182	Sample Drawn by	Laboratory				
Sample Name	Air	Sample Code	EHS360/007				
Sample Description	Ambient Air Quality Monitoring	Sample Condition	Good				
Sampling Location	Sampling Location AAQ7 – Mathampalayam -11°11'53.08"N 76°57'22.51"E						

Date	Period. hrs	SPM (µg/m³)	As (ng/m³)	C6H6 (µg/m³)	Bap (ng/m³)	Pb (μg/m³)	Ni (ng/m³)
01.12.2022	7:00-7:00	64.5	BDL (DL:0.1)	BDL (DL:1.0)	BDL (DL:1.0)	BDL (DL:0.1)	BDL (DL:0.1)
02.12.2022	7:15-7:15	63.2	BDL (DL:0.1)	BDL (DL:1.0)	BDL (DL:1.0)	BDL (DL:0.1)	BDL (DL:0.1)
08.12.2022	7:00-7:00	62.0	BDL (DL:0.1)	BDL (DL:1.0)	BDL (DL:1.0)	BDL (DL:0.1)	BDL (DL:0.1)
09.12.2022	7:15-7:15	64.3	BDL (DL:0.1)	BDL (DL:1.0)	BDL (DL:1.0)	BDL (DL:0.1)	BDL (DL:0.1)
15.12.2022	7:00-7:00	66.5	BDL (DL:0.1)	BDL (DL:1.0)	BDL (DL:1.0)	BDL (DL:0.1)	BDL (DL:0.1)
16.12.2022	7:15-7:15	67.2	BDL (DL:0.1)	BDL (DL:1.0)	BDL (DL:1.0)	BDL (DL:0.1)	BDL (DL:0.1)
22.12.2022	7:00-7:00	66.3	BDL (DL:0.1)	BDL (DL:1.0)	BDL (DL:1.0)	BDL (DL:0.1)	BDL (DL:0.1)
23.12.2022	7:15-7:15	62.1	BDL (DL:0.1)	BDL (DL:1.0)	BDL (DL:1.0)	BDL (DL:0.1)	BDL (DL:0.1)
29.12.2022	7:00-7:00	63.4	BDL (DL:0.1)	BDL (DL:1.0)	BDL (DL:1.0)	BDL (DL:0.1)	BDL (DL:0.1)
30.12.2022	7:15-7:15	65.2	BDL (DL:0.1)	BDL (DL:1.0)	BDL (DL:1.0)	BDL (DL:0.1)	BDL (DL:0.1)
05.01.2023	7:00-7:00	67.3	BDL (DL:0.1)	BDL (DL:1.0)	BDL (DL:1.0)	BDL (DL:0.1)	BDL (DL:0.1)
06.01.2023	7:15-7:15	64.0	BDL (DL:0.1)	BDL (DL:1.0)	BDL (DL:1.0)	BDL (DL:0.1)	BDL (DL:0.1)
12.01.2023	7:00-7:00	66.2	BDL (DL:0.1)	BDL (DL:1.0)	BDL (DL:1.0)	BDL (DL:0.1)	BDL (DL:0.1)
13.01.2023	7:15-7:15	65.0	BDL (DL:0.1)	BDL (DL:1.0)	BDL (DL:1.0)	BDL (DL:0.1)	BDL (DL:0.1)
19.01.2023	7:00-7:00	66.4	BDL (DL:0.1)	BDL (DL:1.0)	BDL (DL:1.0)	BDL (DL:0.1)	BDL (DL:0.1)
20.01.2023	7:15-7:15	64.0	BDL (DL:0.1)	BDL (DL:1.0)	BDL (DL:1.0)	BDL (DL:0.1)	BDL (DL:0.1)
26.01.2023	7:00-7:00	63.8	BDL (DL:0.1)	BDL (DL:1.0)	BDL (DL:1.0)	BDL (DL:0.1)	BDL (DL:0.1)
27.01.2023	7:15-7:15	63.5	BDL (DL:0.1)	BDL (DL:1.0)	BDL (DL:1.0)	BDL (DL:0.1)	BDL (DL:0.1)
02.02.2023	7:00-7:00	62.0	BDL (DL:0.1)	BDL (DL:1.0)	BDL (DL:1.0)	BDL (DL:0.1)	BDL (DL:0.1)
03.02.2023	7:15-7:15	66.0	BDL (DL:0.1)	BDL (DL:1.0)	BDL (DL:1.0)	BDL (DL:0.1)	BDL (DL:0.1)
09.02.2023	7:00-7:00	67.1	BDL (DL:0.1)	BDL (DL:1.0)	BDL (DL:1.0)	BDL (DL:0.1)	BDL (DL:0.1)
10.02.2023	7:15-7:15	63.1	BDL (DL:0.1)	BDL (DL:1.0)	BDL (DL:1.0)	BDL (DL:0.1)	BDL (DL:0.1)
16.02.2023	7:00-7:00	62.5	BDL (DL:0.1)	BDL (DL:1.0)	BDL (DL:1.0)	BDL (DL:0.1)	BDL (DL:0.1)
17.02.2023	7:15-7:15	63.5	BDL (DL:0.1)	BDL (DL:1.0)	BDL (DL:1.0)	BDL (DL:0.1)	BDL (DL:0.1)
23.02.2023	7:00-7:00	64.2	BDL (DL:0.1)	BDL (DL:1.0)	BDL (DL:1.0)	BDL (DL:0.1)	BDL (DL:0.1)
24.02.2023	7:15-7:15	66.4	BDL (DL:0.1)	BDL (DL:1.0)	BDL (DL:1.0)	BDL (DL:0.1)	BDL (DL:0.1)
NAAQ* St	andard	<200	6	5	1	1	20

Note: BDL: Below Detection Limit; DL: Detection Limit

Remarks: The values observed for the pollutants given above are within the CPCB standards.

Verified by

Skyk

Page 1 of 1

Authorised Signatory

Name: Santhosh Kumar A
Designation: Quality Manager

Note: 1. The test results are only to the sample submitted for test. 2. Any correction of the test report in full or part shall invalidate the report.

3. Sample will be retained for 15 days from the date of reporting except in case of regulatory samples or specifically instructed by client.





TEST REPORT

5. 10-1 H 2 3 5 5 50 50 1 1 1 1 1	A. A. Sec. 100	 •					
Report No	EHS360/TR/2022-23/008	Report Date	02.03.2023				
	Tvi. SRI RAJALAKSHMI SAMAPPA ROUGH STONE & GRAVEL QUARRY						
Site Location	S.F.Nos. 1120/2 & 1121/2,Bilichi Village, Coimbatore North Taluk,						
	Coimbatore District. Cluster Extent: 7.23.0 ha						
Sampling Method	IS 5182	Sample Drawn by	Laboratory				
Sample Name	Air	Sample Code	EHS360/008				
Sample Description	Ambient Air Quality Monitoring	Sample Condition	Good				
Sampling Location AAQ8 – Sengalipalayam - 11°11'46.02"N 77°1'18.17"E							

Date	Period. hrs	PM10(μg/m³)	PM2.5(μg/m ³)	SO2 (µg/m³)	NO2 (μ g/m ³)	O3 (μg/m³)	NH3 (μg/m³)	CO (mg/ m ³)
01.12.2022	7:00-7:00	44.3	22.3	5.2	22.5	BDL(DL:5.0)	BDL(DL:1.0)	BDL(DL:1.14)
02.12.2022	7:15-7:15	42.1	21.5	5.5	23.1	BDL(DL:5.0)	BDL(DL:1.0)	BDL(DL:1.14)
08.12.2022	7:00-7:00	43.5	22.6	5.3	23.0	BDL(DL:5.0)	BDL(DL:1.0)	BDL(DL:1.14)
09.12.2022	7:15-7:15	45.1	25.1	5.0	22.8	BDL(DL:5.0)	BDL(DL:1.0)	BDL(DL:1.14)
15.12.2022	7:00-7:00	46.1	26.3	6.2	21.3	BDL(DL:5.0)	BDL(DL:1.0)	BDL(DL:1.14)
16.12.2022	7:15-7:15	47.2	27.4	6.5	24.3	BDL(DL:5.0)	BDL(DL:1.0)	BDL(DL:1.14)
22.12.2022	7:00-7:00	44.0	28.0	6.1	23.4	BDL(DL:5.0)	BDL(DL:1.0)	BDL(DL:1.14)
23.12.2022	7:15-7:15	45.3	24.1	6.4	22.6	BDL(DL:5.0)	BDL(DL:1.0)	BDL(DL:1.14)
29.12.2022	7:00-7:00	46.3	25.3	6.3	21.0	BDL(DL:5.0)	BDL(DL:1.0)	BDL(DL:1.14)
30.12.2022	7:15-7:15	47.0	26.5	6.6	22.5	BDL(DL:5.0)	BDL(DL:1.0)	BDL(DL:1.14)
05.01.2023	7:00-7:00	44.1	27.4	7.2	23.6	BDL(DL:5.0)	BDL(DL:1.0)	BDL(DL:1.14)
06.01.2023	7:15-7:15	46.3	26.0	6.8	24.1	BDL(DL:5.0)	BDL(DL:1.0)	BDL(DL:1.14)
12.01.2023	7:00-7:00	47.2	28.3	7.0	22.3	BDL(DL:5.0)	BDL(DL:1.0)	BDL(DL:1.14)
13.01.2023	7:15-7:15	45.2	24.2	6.9	20.5	BDL(DL:5.0)	BDL(DL:1.0)	BDL(DL:1.14)
19.01.2023	7:00-7:00	46.3	26.3	6.5	22.6	BDL(DL:5.0)	BDL(DL:1.0)	BDL(DL:1.14)
20.01.2023	7:15-7:15	43.0	28.1	6.2	23.5	BDL(DL:5.0)	BDL(DL:1.0)	BDL(DL:1.14)
26.01.2023	7:00-7:00	42.1	27.1	6.3	21.3	BDL(DL:5.0)	BDL(DL:1.0)	BDL(DL:1.14)
27.01.2023	7:15-7:15	44.3	22.3	6.6	21.0	BDL(DL:5.0)	BDL(DL:1.0)	BDL(DL:1.14)
02.02.2023	7:00-7:00	45.1	24.1	6.4	22.4	BDL(DL:5.0)	BDL(DL:1.0)	BDL(DL:1.14)
03.02.2023	7:15-7:15	46.2	23.1	6.3	23.6	BDL(DL:5.0)	BDL(DL:1.0)	BDL(DL:1.14)
09.02.2023	7:00-7:00	47.2	22.2	6.8	24.5	BDL(DL:5.0)	BDL(DL:1.0)	BDL(DL:1.14)
10.02.2023	7:15-7:15	43.1	22.4	7.0	23.0	BDL(DL:5.0)	BDL(DL:1.0)	BDL(DL:1.14)
16.02.2023	7:00-7:00	44.2	22.1	6.4	24.2	BDL(DL:5.0)	BDL(DL:1.0)	BDL(DL:1.14)
17.02.2023	7:15-7:15	45.2	25.3	6.3	23.1	BDL(DL:5.0)	BDL(DL:1.0)	BDL(DL:1.14)
23.02.2023	7:00-7:00	44.0	22.0	7.5	23.5	BDL(DL:5.0)	BDL(DL:1.0)	BDL(DL:1.14)
24.02.2023	7:15-7:15	46.3	23.1	7.3	22.1	BDL(DL:5.0)	BDL(DL:1.0)	BDL(DL:1.14)
NAAQ* S	tandard	<100	<60	<80	<80	<100	<400	<4

Note: BDL: Below Detection Limit ;DL: Detection Limit

Remarks: The values observed for the pollutants given above are within the CPCB standards.

Verified by

Selyk

Page 1 of 1

Authorised Signatory

Name : Santhosh Kumar A Designation : Quality Manager

Note: 1. The test results are only to the sample submitted for test. 2. Any correction of the test report in full or part shall invalidate the report.

3. Sample will be retained for 15 days from the date of reporting except in case of regulatory samples or specifically instructed by client.



Report No	EHS360/TR/2022-23/008	Report Date	02.03.2023				
	Tvi. SRI RAJALAKSHMI SAMAPPA ROUGH STONE & GRAVEL QUARRY						
Site Location		S.F.Nos. 1120/2 & 1121/2, Bilichi Village, Coimbatore North Taluk,					
	Coimbatore District. Cluster Extent: 7.23.0 ha						
Sampling Method	IS 5182	Sample Drawn by	Laboratory				
Sample Name	Air	Sample Code	EHS360/008				
Sample Description	Ambient Air Quality Monitoring	Sample Condition	Good				
Sampling Location	AAQ8 – Sengalipalayam - 11°11'46.02"N 77°1'18.17"E						

Date	Period. hrs	SPM (μg/m³)	As (ng/m³)	С6H6 (µg/m³)	Bap (ng/m³)	Pb (μg/m³)	Ni (ng/m³)
01.12.2022	7:00-7:00	65.5	BDL (DL:0.1)	BDL (DL:1.0)	BDL (DL:1.0)	BDL (DL:0.1)	BDL (DL:0.1)
02.12.2022	7:15-7:15	64.2	BDL (DL:0.1)	BDL (DL:1.0)	BDL (DL:1.0)	BDL (DL:0.1)	BDL (DL:0.1)
08.12.2022	7:00-7:00	67.2	BDL (DL:0.1)	BDL (DL:1.0)	BDL (DL:1.0)	BDL (DL:0.1)	BDL (DL:0.1)
09.12.2022	7:15-7:15	66.3	BDL (DL:0.1)	BDL (DL:1.0)	BDL (DL:1.0)	BDL (DL:0.1)	BDL (DL:0.1)
15.12.2022	7:00-7:00	67.2	BDL (DL:0.1)	BDL (DL:1.0)	BDL (DL:1.0)	BDL (DL:0.1)	BDL (DL:0.1)
16.12.2022	7:15-7:15	68.1	BDL (DL:0.1)	BDL (DL:1.0)	BDL (DL:1.0)	BDL (DL:0.1)	BDL (DL:0.1)
22.12.2022	7:00-7:00	66.0	BDL (DL:0.1)	BDL (DL:1.0)	BDL (DL:1.0)	BDL (DL:0.1)	BDL (DL:0.1)
23.12.2022	7:15-7:15	65.3	BDL (DL:0.1)	BDL (DL:1.0)	BDL (DL:1.0)	BDL (DL:0.1)	BDL (DL:0.1)
29.12.2022	7:00-7:00	64.1	BDL (DL:0.1)	BDL (DL:1.0)	BDL (DL:1.0)	BDL (DL:0.1)	BDL (DL:0.1)
30.12.2022	7:15-7:15	68.3	BDL (DL:0.1)	BDL (DL:1.0)	BDL (DL:1.0)	BDL (DL:0.1)	BDL (DL:0.1)
05.01.2023	7:00-7:00	65.2	BDL (DL:0.1)	BDL (DL:1.0)	BDL (DL:1.0)	BDL (DL:0.1)	BDL (DL:0.1)
06.01.2023	7:15-7:15	64.3	BDL (DL:0.1)	BDL (DL:1.0)	BDL (DL:1.0)	BDL (DL:0.1)	BDL (DL:0.1)
12.01.2023	7:00-7:00	64.0	BDL (DL:0.1)	BDL (DL:1.0)	BDL (DL:1.0)	BDL (DL:0.1)	BDL (DL:0.1)
13.01.2023	7:15-7:15	65.5	BDL (DL:0.1)	BDL (DL:1.0)	BDL (DL:1.0)	BDL (DL:0.1)	BDL (DL:0.1)
19.01.2023	7:00-7:00	66.4	BDL (DL:0.1)	BDL (DL:1.0)	BDL (DL:1.0)	BDL (DL:0.1)	BDL (DL:0.1)
20.01.2023	7:15-7:15	67.2	BDL (DL:0.1)	BDL (DL:1.0)	BDL (DL:1.0)	BDL (DL:0.1)	BDL (DL:0.1)
26.01.2023	7:00-7:00	68.2	BDL (DL:0.1)	BDL (DL:1.0)	BDL (DL:1.0)	BDL (DL:0.1)	BDL (DL:0.1)
27.01.2023	7:15-7:15	67.0	BDL (DL:0.1)	BDL (DL:1.0)	BDL (DL:1.0)	BDL (DL:0.1)	BDL (DL:0.1)
02.02.2023	7:00-7:00	66.1	BDL (DL:0.1)	BDL (DL:1.0)	BDL (DL:1.0)	BDL (DL:0.1)	BDL (DL:0.1)
03.02.2023	7:15-7:15	65.4	BDL (DL:0.1)	BDL (DL:1.0)	BDL (DL:1.0)	BDL (DL:0.1)	BDL (DL:0.1)
09.02.2023	7:00-7:00	64.3	BDL (DL:0.1)	BDL (DL:1.0)	BDL (DL:1.0)	BDL (DL:0.1)	BDL (DL:0.1)
10.02.2023	7:15-7:15	63.3	BDL (DL:0.1)	BDL (DL:1.0)	BDL (DL:1.0)	BDL (DL:0.1)	BDL (DL:0.1)
16.02.2023	7:00-7:00	65.0	BDL (DL:0.1)	BDL (DL:1.0)	BDL (DL:1.0)	BDL (DL:0.1)	BDL (DL:0.1)
17.02.2023	7:15-7:15	66.2	BDL (DL:0.1)	BDL (DL:1.0)	BDL (DL:1.0)	BDL (DL:0.1)	BDL (DL:0.1)
23.02.2023	7:00-7:00	67.2	BDL (DL:0.1)	BDL (DL:1.0)	BDL (DL:1.0)	BDL (DL:0.1)	BDL (DL:0.1)
24.02.2023	7:15-7:15	68.2	BDL (DL:0.1)	BDL (DL:1.0)	BDL (DL:1.0)	BDL (DL:0.1)	BDL (DL:0.1)
NAAQ* St	andard	<200	6	5	1	1	20

Note: BDL: Below Detection Limit; DL: Detection Limit

Remarks: The values observed for the pollutants given above are within the CPCB standards.

Verified by

Skyk



Authorised Signatory

Name : Santhosh Kumar A
Designation : Quality Manager

Note: 1. The test results are only to the sample submitted for test. 2. Any correction of the test report in full or part shall invalidate the report.

3. Sample will be retained for 15 days from the date of reporting except in case of regulatory samples or specifically instructed by client.





TEST REPORT

31 - T (H. P. P. H. 1.39) - 14- (H. P. H. 1.4)						
Report No	EHS360/TR/2022-23/ 001	Report Date	02.03.2023			
	Tvi. SRI RAJALAKSHMI SAM	Tvi. SRI RAJALAKSHMI SAMAPPA ROUGH STONE & GRAVEL QUARRY				
Site Location	S.F.Nos. 1120/2 & 1121/2,Bilio	S.F.Nos. 1120/2 & 1121/2,Bilichi Village, Coimbatore North Taluk,				
	Coimbatore District. Cluster E	xtent: 7.23.0 ha				
Sampling Method	IS 9989	Sample Drawn by	Laboratory			
Sample Name	Noise Level Monitoring	Sample Code	EHS360/ 001			
Sample Description	Ambient Noise	Sample Collected Date	24.02.2023			

Location	N1 – Core Zone - 11°11′54.54″N 76°59′40.76″E		N2 – Onnipalayam - 11°12'27.14"N 77° 0'7.93"E			
Parameter	Min	Max	Result	Min	Max	Result
Time	dB(A)	dB(A)	dB(A)	dB(A)	dB(A)	dB(A)
06:00-07:00	42.2	47.1	45.3	41.2	44.2	43.0
07:00-08:00	42.3	45.2	44.0	40.3	43.2	42.0
08:00-09:00	44.3	43.2	43.8	41.2	45.1	43.6
09:00-10:00	41.3	47.2	45.2	42.1	46.2	44.6
10:00-11:00	40.2	45.3	43.5	40.6	45.2	43.5
11:00-12:00	41.2	44.3	43.0	40.2	47.2	45.0
12:00-13:00	42.1	47.6	45.7	41.2	46.2	44.4
13:00-14:00	43.2	47.3	45.7	40.2	46.3	44.2
14:00-15:00	41.2	44.5	43.2	42.1	45.2	43.9
15:00-16:00	43.2	46.3	45.0	42.3	47.2	45.4
16:00-17:00	41.8	48.2	46.1	42.1	46.3	44.7
17:00-18:00	42.6	46.3	44.8	40.3	48.2	45.8
18:00-19:00	40.2	46.3	44.2	41.3	44.2	43.0
19:00-20:00	42.1	45.2	43.9	37.2	43.2	41.2
20:00-21:00	40.3	43.2	42.0	35.2	42.1	39.9
21:00-22:00	38.2	40.2	39.3	36.1	39.2	37.9
22:00-23:00	36.2	42.1	40.1	36.5	38.2	37.4
23:00-00:00	37.5	39.1	38.4	34.2	36.2	35.3
00:00-01:00	35.6	37.2	36.5	33.5	34.1	33.8
01:00-02:00	34.2	36.1	35.3	32.1	36.2	34.6
02:00-03:00	32.1	35.2	33.9	34.6	36.5	35.7
03:00-04:00	34.5	36.1	35.4	35.2	37.1	36.3
04:00-05:00	36.5	38.2	37.4	34.1	36.5	35.5
05:00-06:00	34.2	36.4	35.4	33.6	37.1	35.7
	Day	Means	43.8	Day I	Means	42.9
Result	Nigh	t Means	36.0	Night	Means	35.3

Note: CPCB Norms Industrial Area Day Time:75 dB(A); Night Time:70 dB(A) The Noise level in the above location exists within the permissible limits of CPCB.

Verified by

Shyk



Authorised Signatory

Name : Santhosh Kumar A Designation : Quality Manager

Note: 1. The test results are only to the sample submitted for test. 2. Any correction of the test report in full or part shall invalidate the report.

3. Sample will be retained for 15 days from the date of reporting except in case of regulatory samples or specifically instructed by client.





TEST REPORT

-	۰,	_	n	-	n	
- 1	ч		ы	а	н	ı,

5. 17.11.17.7.15.15.50. 50.1.1.16.16.	1 1 me 1 mm					
Report No	EHS360/TR/2022-23/ 002	Report Date	02.03.2023			
	APPA ROUGH STONE & GRAVE	L QUARRY				
Site Location	S.F.Nos. 1120/2 & 1121/2,Bilio	chi Village, Coimbatore North Ta	lluk,			
	Coimbatore District. Cluster I	Extent: 7.23.0 ha				
Sampling Method	IS 9989	Sample Drawn by	Laboratory			
Sample Name	Noise Level Monitoring	Noise Level Monitoring Sample Code EHS360/ 002				
Sample Description	Ambient Noise	Sample Collected Date	24.02.2023			

Location	N3 – Ka	llipalayam - 11° 76°59'24.02"E	10'43.86"N	N4 – Muthalipa	alayam - 11°10'20.	38"N 77° 2'38.46"E
Parameter	Min	Max	Result	Min	Max	Result
Time	dB(A)	dB(A)	dB(A)	dB(A)	dB(A)	dB(A)
06:00-07:00	38.2	40.2	39.3	38.2	40.2	39.3
07:00-08:00	39.2	42.1	40.9	37.1	40.1	38.9
08:00-09:00	40.2	42.3	41.4	36.2	39.8	38.4
09:00-10:00	42.1	44.2	43.3	35.2	39.4	37.8
10:00-11:00	39.5	41.2	40.4	40.1	42.1	41.2
11:00-12:00	38.2	44.2	42.2	34.2	38.2	36.6
12:00-13:00	37.2	40.2	39.0	33.1	36.1	34.9
13:00-14:00	44.2	46.3	45.4	32.2	35.1	33.9
14:00-15:00	42.1	44.2	43.3	42.1	44.3	43.3
15:00-16:00	41.2	45.3	43.7	40.1	42.1	41.2
16:00-17:00	40.3	42.3	41.4	38.2	40.3	39.4
17:00-18:00	37.2	40.2	39.0	39.2	42.1	40.9
18:00-19:00	36.6	42.1	40.2	42.1	44.3	43.3
19:00-20:00	35.2	40.2	38.4	44.3	46.1	45.3
20:00-21:00	34.2	36.1	35.3	36.5	38.6	37.7
21:00-22:00	33.2	34.2	33.7	38.1	40.2	39.3
22:00-23:00	32.1	35.2	33.9	36.5	38.2	37.4
23:00-00:00	33.2	36.1	34.9	35.2	37.6	36.6
00:00-01:00	32.1	35.2	33.9	34.2	37.2	36.0
01:00-02:00	31.4	34.1	33.0	33.2	36.1	34.9
02:00-03:00	33.6	35.2	34.5	32.1	37.6	35.7
03:00-04:00	34.2	36.3	35.4	33.4	35.6	34.6
04:00-05:00	35.2	37.2	36.3	31.2	33.5	32.5
05:00-06:00	36.4	38.2	37.4	34.6	36.4	35.6
	Day	Means	40.0	Day I	Means	39.3
Result	Nigh	t Means	35.0	Night	Means	35.1

Note: CPCB Norms Industrial Area Day Time:75 dB(A); Night Time:70 dB(A) The Noise level in the above location exists within the permissible limits of CPCB.

CHENNAL

600 083

Verified by

Selyk

Authorised Signatory

Name : Santhosh Kumar A
Designation : Quality Manager

Note: 1. The test results are only to the sample submitted for test. 2.Any correction of the test report in full or part shall invalidate the report.

3. Sample will be retained for 15 days from the date of reporting except in case of regulatory samples or specifically instructed by client.





TEST REPORT

5. 5. 5. 5. 1 N. 5. 5. 5. 5. 5. 5. 5. 5. 5. 5. 5. 5. 5.	1,56,500	1121 0111				
Report No	EHS360/TR/2022-23/ 003	Report Date	02.03.2023			
		Tvi. SRI RAJALAKSHMI SAMAPPA ROUGH STONE & GRAVEL QUARRY				
Site Location		S.F.Nos. 1120/2 & 1121/2,Bilichi Village, Coimbatore North Taluk,				
	Coimbatore District. Cluster E	xtent: 7.23.0 ha				
Sampling Method	IS 9989	Sample Drawn by	Laboratory			
Sample Name	Noise Level Monitoring	Sample Code	EHS360/ 003			
Sample Description	Ambient Noise	Sample Collected Date	24.02.2023			

Location	N5 – Bettadapuram - 11°13'26.18"N 76°57'26.45"E		N6 – Periya P	uthur - 11°13'37.4	10"N 77° 1'42.33"E	
Parameter	Min	Max	Result	Min	Max	Result
Time	dB(A)	dB(A)	dB(A)	dB(A)	dB(A)	dB(A)
06:00-07:00	36.3	38.6	37.6	36.5	38.2	37.4
07:00-08:00	34.2	36.8	35.7	35.5	38.9	37.5
08:00-09:00	36.2	38.2	37.3	34.2	36.5	35.5
09:00-10:00	31.2	38.2	36.0	33.2	38.2	36.4
10:00-11:00	32.6	33.4	33.0	31.2	36.4	34.5
11:00-12:00	33.4	35.2	34.4	33.6	36.2	35.1
12:00-13:00	35.6	38.6	37.4	34.2	38.2	36.6
13:00-14:00	38.2	39.1	38.7	33.6	39.2	37.2
14:00-15:00	38.6	39.9	39.3	34.1	40.2	38.1
15:00-16:00	36.8	38.2	37.6	36.5	42.3	40.3
16:00-17:00	37.2	39.2	38.3	38.2	43.1	41.3
17:00-18:00	38.1	39.2	38.7	40.2	44.2	42.6
18:00-19:00	35.2	39.7	38.0	42.1	46.3	44.7
19:00-20:00	33.5	42.3	39.8	44.3	46.2	45.4
20:00-21:00	32.2	44.2	41.5	40.2	44.2	42.6
21:00-22:00	33.6	45.3	42.6	38.1	40.2	39.3
22:00-23:00	34.2	36.2	35.3	32.2	42.3	39.7
23:00-00:00	32.1	37.2	35.4	36.2	41.2	39.4
00:00-01:00	31.8	33.6	32.8	34.2	38.6	36.9
01:00-02:00	31.1	33.4	32.4	36.1	40.3	38.7
02:00-03:00	31.6	39.2	36.9	34.2	38.6	36.9
03:00-04:00	35.2	39.5	37.9	33.6	36.5	35.3
04:00-05:00	34.2	41.2	39.0	35.1	38.9	37.4
05:00-06:00	33.1	40.1	37.9	34.2	39.2	37.4
	Day	Means	37.7	Day	Means	39.1
Result	Nigh	t Means	36.0	Night	Means	37.4

Note: CPCB Norms Industrial Area Day Time:75 dB(A); Night Time:70 dB(A) The Noise level in the above location exists within the permissible limits of CPCB.

CHENNAL

600 083

Verified by

Selyk

Authorised Signatory

Name : Santhosh Kumar A Designation : Quality Manager

Note: 1. The test results are only to the sample submitted for test. 2.Any correction of the test report in full or part shall invalidate the report.

3. Sample will be retained for 15 days from the date of reporting except in case of regulatory samples or specifically instructed by client.





TEST REPORT

Report No	EHS360/TR/2022-23/ 004	Report Date	02.03.2023		
Olta I a anti a m	Tvi. SRI RAJALAKSHMI SAMAPPA ROUGH STONE & GRAVEL QUARRY				
Site Location	S.F.Nos. 1120/2 & 1121/2,Bilichi Village, Coimbatore North Taluk, Coimbatore District. Cluster Extent: 7.23.0 ha				
Sampling Method	IS 9989	Sample Drawn by	Laboratory		
Sample Name	Noise Level Monitoring	Sample Code	EHS360/ 004		
Sample Description	Ambient Noise	Sample Collected Date	24.02.2023		

Location	N7 - Math	nampalayam - 11 76°57'21.12"E	l°11'53.10"N	N8 – Sengalip	alayam - 11°11'46.	34"N 77° 1'18.16"E
Parameter	Min	Max	Result	Min	Max	Result
Time	dB(A)	dB(A)	dB(A)	dB(A)	dB(A)	dB(A)
06:00-07:00	38.2	40.2	39.3	36.2	38.2	37.3
07:00-08:00	35.6	39.2	37.8	38.2	40.2	39.3
08:00-09:00	34.2	36.5	35.5	34.2	38.2	36.6
09:00-10:00	35.6	38.2	37.1	33.2	39.2	37.2
10:00-11:00	36.4	38.6	37.6	34.6	38.2	36.8
11:00-12:00	35.1	40.2	38.4	33.1	35.6	34.5
12:00-13:00	36.5	38.2	37.4	32.1	36.4	34.8
13:00-14:00	38.6	42.3	40.8	35.2	38.6	37.2
14:00-15:00	37.2	41.3	39.7	36.2	40.2	38.6
15:00-16:00	31.2	33.2	32.3	32.5	42.3	39.7
16:00-17:00	34.2	36.4	35.4	34.2	43.1	40.6
17:00-18:00	35.6	38.6	37.4	34.1	38.2	36.6
18:00-19:00	36.1	38.1	37.2	33.2	37.2	35.6
19:00-20:00	38.2	40.2	39.3	32.6	38.2	36.2
20:00-21:00	37.2	39.2	38.3	31.2	34.2	33.0
21:00-22:00	33.5	36.5	35.3	32.6	38.2	36.2
22:00-23:00	32.4	36.5	34.9	33.2	36.2	35.0
23:00-00:00	31.2	35.4	33.8	31.2	34.1	32.9
00:00-01:00	32.6	36.5	35.0	30.2	33.2	32.0
01:00-02:00	33.5	34.2	33.9	32.6	35.6	34.4
02:00-03:00	34.2	36.5	35.5	32.5	38.2	36.2
03:00-04:00	35.6	38.2	37.1	31.6	36.9	35.0
04:00-05:00	34.2	36.5	35.5	32.5	37.8	35.9
05:00-06:00	33.5	38.2	36.5	30.2	36.9	34.7
	Day	Means	37.3	Day I	Means	36.8
Result	Nigh	t Means	35.3	Night	Means	34.4

Note: CPCB Norms Industrial Area Day Time:75 dB(A); Night Time:70 dB(A) The Noise level in the above location exists within the permissible limits of CPCB.

Verified by

Selyk

Page 1 of 42 CHENNAI 600 083

Authorised Signatory

Name : Santhosh Kumar A Designation : Quality Manager

Note: 1. The test results are only to the sample submitted for test. 2. Any correction of the test report in full or part shall invalidate the report. 3. Sample will be retained for 15 days from the date of reporting except in case of regulatory samples or specifically instructed by client.



TEST REPORT

Report No	EHS360/TR/2022-23/ 001	Report Date	02.03.2023				
	Tvi. SRI RAJALAKSHMI SAMAF	Tvl. SRI RAJALAKSHMI SAMAPPA ROUGH STONE & GRAVEL QUARRY S.F.Nos. 1120/2 & 1121/2,Bilichi Village, Coimbatore North Taluk,					
Site Location							
	Coimbatore District. Cluster Extent: 7.23.0 ha						
Sampling Method	SOP Method	Sample Drawn by	Laboratory				
Sample Name	Soil	Sample Code	EHS360/ 001				
Sample Description	Soil 1	Sample Collected Date	24.02.2023				
Qty. of Sample Received	2 KG	Sample Received On	25.02.2023				
Sample Condition	Good	Test Commenced On	25.02.2023				
Sampling Location	Core Zone						

S. No	Test Parameters	Protocols	Results
01	pH @ 25°C	IS 2720 Part 26 - 1987 (Reaff:2016)	8.04
02	Conductivity @ 25°C	IS 14767 - 2000 (Reaff : 2016)	410 µmhos/cm
03	Water Holding Capacity	By Gravimetric Method	47.6 %
04	Bulk Density	By Cylindrical Method	1.2 g/cm ³
05	Porosity	By Gravimetric Method	42.8 %
06	Calcium as Ca		125.5 mg/kg
07	Magnesium as Mg		67.8 mg/kg
08	Chloride as Cl	Food and Agriculture organization of the united Nation Rome 2007 : 2018	110 mg/kg
09	Soluble Sulphate as SO ₄		0.011 %
10	Total Phosphorus as P		2.1 mg/kg
11	Total Nitrogen as N	IS 14684 : 1999 (Reaff:2019)	300 mg/kg
12	Organic Matter	IS : 2720 Part 22: 1972 (Reaff: 2015)	1.93 %
13	Organic Carbon	IS : 2720 Part 22: 1972 (Reaff: 2015)	1.12 %

Verified by

Selyk

Page 1 of 4 CHENNAI 600 083

Authorised Signatory

Name: Santhosh Kumar A
Designation: Quality Manager

Note: 1. The test results are only to the sample submitted for test. 2. Any correction of the test report in full or part shall invalidate the report.

3. Sample will be retained for 15 days from the date of reporting except in case of regulatory samples or specifically instructed by client.



Report No	EHS360/TR/2022-23/ 001	Report Date	02.03.2023
Site Location	Tvl. SRI RAJALAKSHMI SAMAPPA ROUGH STONE & GRAVEL QUARRY S.F.Nos. 1120/2 & 1121/2,Bilichi Village, Coimbatore North Taluk, Coimbatore District. Cluster Extent: 7.23.0 ha		
Sampling Method	SOP Method	Sample Drawn by	Laboratory
Sample Name	Soil	Sample Code	EHS360/ 001
Sample Description	Soil 1	Sample Collected Date	24.02.2023
Qty. of Sample Received	2 KG	Sample Received On	25.02.2023
Sample Condition	Good	Test Commenced On	25.02.2023
Sampling Location Core Zone			

S. No	Test Parameters	Protocols	Results		
14	Texture :				
	Clay		35.5 %		
	Sand	Gravimetric Method	31.9 %		
	Silt		32.6 %		
15	Manganese as Mn		25 mg/kg		
16	Zinc as Zn		1.62 mg/kg		
17	Boron as B		3.3 mg/kg		
18	Potassium as K		32 mg/kg		
19	Cadmium as Cd	USEPA 3050 B – 1996 & USEPA 6010 C - 2000	BDL (DL : 1.0 mg/kg)		
20	Total Chromium as Cr	002.7100.10 0 2000	BDL (DL : 1.0 mg/kg)		
21	Copper as Cu		BDL (DL : 1.0 mg/kg)		
22	Lead as Pb		0.81 mg/kg		
23	Iron as Fe		2.35 mg/kg		
24	Cation Exchange Capacity	USEPA - 1986	44.5 meq/100g of soil		

Verified by



Authorised Signatory

Name: Santhosh Kumar A Designation: Quality Manager

Note: 1. The test results are only to the sample submitted for test. 2.Any correction of the test report in full or part shall invalidate the report. 3. Sample will be retained for 15 days from the date of reporting except in case of regulatory samples or specifically instructed by client.





Report No	EHS360/TR/2022-23/ 002	Report Date	02.03.2023	
	Tvi. SRI RAJALAKSHMI SAMAPPA ROUGH STONE & GRAVEL QUARRY			
Site Location	S.F.Nos. 1120/2 & 1121/2,Bilichi Village, Coimbatore North Taluk,			
	Coimbatore District. Cluster Extent: 7.23.0 ha			
Sampling Method	SOP Method	Sample Drawn by	Laboratory	
Sample Name	Soil	Sample Code	EHS360/ 002	
Sample Description	Soil 2	Sample Collected Date	24.02.2023	
Qty. of Sample Received	2 KG	Sample Received On	25.02.2023	
Sample Condition	Good	Test Commenced On	25.02.2023	
Sampling Location	Onnipalayam			

S. No	Test Parameters	Protocols	Results
01	pH @ 25°C	IS 2720 Part 26 - 1987 (Reaff:2016)	8.10
02	Conductivity @ 25°C	IS 14767 - 2000 (Reaff : 2016)	523 µmhos/cm
03	Water Holding Capacity	By Gravimetric Method	48.7 %
04	Bulk Density	By Cylindrical Method	1.25 g/cm ³
05	Porosity	By Gravimetric Method	42.5 %
06	Calcium as Ca		158 mg/kg
07	Magnesium as Mg		88.4 mg/kg
08	Chloride as Cl	Food and Agriculture organization of the united Nation Rome 2007 : 2018	120 mg/kg
09	Soluble Sulphate as SO ₄		0.0011 %
10	Total Phosphorus as P		1.3 mg/kg
11	Total Nitrogen as N	IS 14684 : 1999 (Reaff:2019)	270 mg/kg
12	Organic Matter	IS : 2720 Part 22: 1972 (Reaff: 2015)	0.90 %
13	Organic Carbon	IS : 2720 Part 22: 1972 (Reaff: 2015)	0.52 %

Verified by



Authorised Signatory

Name: Santhosh Kumar A Designation : Quality Manager

Note: 1. The test results are only to the sample submitted for test. 2.Any correction of the test report in full or part shall invalidate the report. 3. Sample will be retained for 15 days from the date of reporting except in case of regulatory samples or specifically instructed by client.



Report No	EHS360/TR/2022-23/ 002	Report Date	02.03.2023
Site Location	Tvl. SRI RAJALAKSHMI SAMAPPA ROUGH STONE & GRAVEL QUARRY S.F.Nos. 1120/2 & 1121/2,Bilichi Village, Coimbatore North Taluk, Coimbatore District. Cluster Extent: 7.23.0 ha		
Sampling Method	SOP Method	Sample Drawn by	Laboratory
Sample Name	Soil	Sample Code	EHS360/ 002
Sample Description	Soil 2	Sample Collected Date	24.02.2023
Qty. of Sample Received	2 KG	Sample Received On	25.02.2023
Sample Condition	Good	Test Commenced On	25.02.2023
Sampling Location	Onnipalayam		

S. No	Test Parameters	Protocols	Results		
14	Texture:				
	Clay		35.5 %		
	Sand	Gravimetric Method	36.9 %		
	Silt		27.6 %		
15	Manganese as Mn		30.8 mg/kg		
16	Zinc as Zn		2.6 mg/kg		
17	Boron as B		1.9 mg/kg		
18	Potassium as K		40.1 mg/kg		
19	Cadmium as Cd	USEPA 3050 B - 1996 & USEPA 6010 C - 2000	BDL (DL : 1.0 mg/kg)		
20	Total Chromium as Cr		BDL (DL : 1.0 mg/kg)		
21	Copper as Cu		BDL (DL : 1.0 mg/kg)		
22	Lead as Pb]	0.59 mg/kg		
23	Iron as Fe]	1.22 mg/kg		
24	Cation Exchange Capacity	USEPA - 1986	38.8 meq/100g of soil		

Verified by

End of Report******* CHENNAL 600 083

Authorised Signatory

Name: Santhosh Kumar A Designation: Quality Manager

Note: 1. The test results are only to the sample submitted for test. 2.Any correction of the test report in full or part shall invalidate the report. 3. Sample will be retained for 15 days from the date of reporting except in case of regulatory samples or specifically instructed by client.





Report No	EHS360/TR/2022-23/ 003	Report Date	02.03.2023
Site Location	Tvl. SRI RAJALAKSHMI SAMAPPA ROUGH STONE & GRAVEL QUARRY S.F.Nos. 1120/2 & 1121/2,Bilichi Village, Coimbatore North Taluk, Coimbatore District. Cluster Extent: 7.23.0 ha		
Sampling Method	SOP Method	Sample Drawn by	Laboratory
Sample Name	Soil	Sample Code	EHS360/ 003
Sample Description	Soil 3	Sample Collected Date	24.02.2023
Qty. of Sample Received	2 KG	Sample Received On	25.02.2023
Sample Condition	Good	Test Commenced On	25.02.2023
Sampling Location	Kallipalayam		

S. No	Test Parameters	Protocols	Results
01	pH @ 25°C	IS 2720 Part 26 - 1987 (Reaff:2016)	8.75
02	Conductivity @ 25°C	IS 14767 - 2000 (Reaff : 2016)	520 μmhos/cm
03	Water Holding Capacity	By Gravimetric Method	47.9 %
04	Bulk Density	By Cylindrical Method	1.21 g/cm ³
05	Porosity	By Gravimetric Method	46.1 %
06	Calcium as Ca		91.8 mg/kg
07	Magnesium as Mg		82 mg/kg
08	Chloride as Cl	Food and Agriculture organization of the united Nation Rome 2007 : 2018	130 mg/kg
09	Soluble Sulphate as SO ₄		0.009 %
10	Total Phosphorus as P		1.10 mg/kg
11	Total Nitrogen as N	IS 14684 : 1999 (Reaff:2019)	355 mg/kg
12	Organic Matter	IS : 2720 Part 22: 1972 (Reaff: 2015)	2.03 %
13	Organic Carbon	IS : 2720 Part 22: 1972 (Reaff: 2015)	1.18 %

Verified by



*******End of Report******* CHENNAL 600 083

Authorised Signatory Name: Santhosh Kumar A

Designation : Quality Manager

Note: 1. The test results are only to the sample submitted for test. 2.Any correction of the test report in full or part shall invalidate the report. 3. Sample will be retained for 15 days from the date of reporting except in case of regulatory samples or specifically instructed by client.



Report No	EHS360/TR/2022-23/ 003	Report Date	02.03.2023
Site Location	Tvl. SRI RAJALAKSHMI SAMAF S.F.Nos. 1120/2 & 1121/2,Bilichi Coimbatore District. Cluster Ex	i Village, Coimbatore North T	*
Sampling Method	SOP Method	Sample Drawn by	Laboratory
Sample Name	Soil	Sample Code	EHS360/ 003
Sample Description	Soil 3	Sample Collected Date	24.02.2023
Qty. of Sample Received	2 KG	Sample Received On	25.02.2023
Sample Condition	Good	Test Commenced On	25.02.2023
Sampling Location Kallipalayam			

S. No	Test Parameters	Protocols	Results		
14	Texture:				
	Clay		37.2 %		
	Sand	Gravimetric Method	35.9 %		
	Silt		26.9 %		
15	Manganese as Mn		25 mg/kg		
16	Zinc as Zn		1.3 mg/kg		
17	Boron as B		2.5 mg/kg		
18	Potassium as K		34.5 mg/kg		
19	Cadmium as Cd	USEPA 3050 B - 1996 & USEPA 6010 C - 2000	BDL (DL : 1.0 mg/kg)		
20	Total Chromium as Cr	002.7(0010 0 2000	BDL (DL : 1.0 mg/kg)		
21	Copper as Cu		BDL (DL : 1.0 mg/kg)		
22	Lead as Pb		0.7 mg/kg		
23	Iron as Fe		1.10 mg/kg		
24	Cation Exchange Capacity	USEPA - 1986	37.1 meq/100g of soil		

Verified by

End of Report******** CHENNAL 600 083

Authorised Signatory

Name: Santhosh Kumar A Designation: Quality Manager

Note: 1. The test results are only to the sample submitted for test. 2.Any correction of the test report in full or part shall invalidate the report. 3. Sample will be retained for 15 days from the date of reporting except in case of regulatory samples or specifically instructed by client.





Damast Na	ELICOCO/TD/0000 00/ 004	Davis and Davis	00.00.0000	
Report No	EHS360/TR/2022-23/ 004	Report Date	02.03.2023	
	Tvi. SRI RAJALAKSHMI SAMAF	PPA ROUGH STONE & GRAV	EL QUARRY	
Site Location	S.F.Nos. 1120/2 & 1121/2, Bilichi Village, Coimbatore North Taluk,			
	Coimbatore District. Cluster Extent: 7.23.0 ha			
Sampling Method	SOP Method	Sample Drawn by	Laboratory	
Sample Name	Soil	Sample Code	EHS360/ 004	
Sample Description	Soil 4	Sample Collected Date	24.02.2023	
Qty. of Sample Received	2 KG	Sample Received On	25.02.2023	
Sample Condition	Good	Test Commenced On	25.02.2023	
Sampling Location	Periya Puthur			

S. No	Test Parameters	Test Parameters Protocols	
01	pH @ 25°C	IS 2720 Part 26 - 1987 (Reaff:2016)	8.60
02	Conductivity @ 25°C	IS 14767 - 2000 (Reaff : 2016)	409 µmhos/cm
03	Water Holding Capacity	By Gravimetric Method	47.2. %
04	Bulk Density	By Cylindrical Method	1.1 g/cm ³
05	Porosity	By Gravimetric Method	45.3 %
06	Calcium as Ca		200 mg/kg
07	Magnesium as Mg		69.1 mg/kg
08	Chloride as Cl	Food and Agriculture organization of the united Nation Rome 2007 : 2018	86.5 mg/kg
09	Soluble Sulphate as SO ₄		0.005 %
10	Total Phosphorus as P		1.6 mg/kg
11	Total Nitrogen as N	IS 14684 : 1999 (Reaff:2019)	410 mg/kg
12	Organic Matter	IS : 2720 Part 22: 1972 (Reaff: 2015)	1.93 %
13	Organic Carbon	IS: 2720 Part 22: 1972 (Reaff: 2015)	1.12 %

Verified by

******End of Report***** CHENNAL 600 083

Authorised Signatory

Name: Santhosh Kumar A Designation: Quality Manager

Note: 1. The test results are only to the sample submitted for test. 2.Any correction of the test report in full or part shall invalidate the report. 3. Sample will be retained for 15 days from the date of reporting except in case of regulatory samples or specifically instructed by client.



	<u> </u>			
Report No	EHS360/TR/2022-23/ 004	Report Date	02.03.2023	
	Tvi. SRI RAJALAKSHMI SAMAF		*	
Site Location	S.F.Nos. 1120/2 & 1121/2, Bilichi Village, Coimbatore North Taluk,			
	Coimbatore District. Cluster Extent: 7.23.0 ha			
Sampling Method	SOP Method	Sample Drawn by	Laboratory	
Sample Name	Soil	Sample Code	EHS360/ 004	
Sample Description	Soil 4	Sample Collected Date	24.02.2023	
Qty. of Sample Received	2 KG	Sample Received On	25.02.2023	
Sample Condition	Good	Test Commenced On	25.02.2023	
Sampling Location	Periya Puthur			

S. No	Test Parameters	Protocols	Results		
14	Texture:				
	Clay		37.9 %		
	Sand	Gravimetric Method	35.5 %		
	Silt		26.6 %		
15	Manganese as Mn		26.7 mg/kg		
16	Zinc as Zn		1.3 mg/kg		
17	Boron as B		1.5 mg/kg		
18	Potassium as K		47.3 mg/kg		
19	Cadmium as Cd	USEPA 3050 B - 1996 & USEPA 6010 C - 2000	BDL (DL : 1.0 mg/kg)		
20	Total Chromium as Cr		BDL (DL : 1.0 mg/kg)		
21	Copper as Cu		BDL (DL : 1.0 mg/kg)		
22	Lead as Pb		0.71 mg/kg		
23	Iron as Fe		2.38 mg/kg		
24	Cation Exchange Capacity	USEPA - 1986	36.2 meq/100g of soil		

Verified by

******End of Report****** CHENNAL 600 083

Authorised Signatory

Name: Santhosh Kumar A Designation: Quality Manager

Note: 1. The test results are only to the sample submitted for test. 2.Any correction of the test report in full or part shall invalidate the report. 3. Sample will be retained for 15 days from the date of reporting except in case of regulatory samples or specifically instructed by client.





Report No	EHS360/TR/2022-23/ 005	Report Date	02.03.2023	
	Tvi. SRI RAJALAKSHMI SAMAPPA ROUGH STONE & GRAVEL QUARRY			
Site Location	S.F.Nos. 1120/2 & 1121/2,Bilichi Village, Coimbatore North Taluk, Coimbatore District. Cluster Extent: 7.23.0 ha			
Sampling Method	SOP Method	Sample Drawn by	Laboratory	
Sample Name	Soil	Sample Code	EHS360/ 005	
Sample Description	Soil 5	Sample Collected Date	24.02.2023	
Qty. of Sample Received	2 KG	Sample Received On	25.02.2023	
Sample Condition	Good	Test Commenced On	25.02.2023	
Sampling Location Mathampalayam				

S. No	Test Parameters	Test Parameters Protocols	
01	pH @ 25°C	IS 2720 Part 26 - 1987 (Reaff:2016)	7.55
02	Conductivity @ 25°C	IS 14767 - 2000 (Reaff : 2016)	480 μmhos/cm
03	Water Holding Capacity	By Gravimetric Method	46.9 %
04	Bulk Density	By Cylindrical Method	0.95 g/cm ³
05	Porosity	By Gravimetric Method	42.4 %
06	Calcium as Ca		120 mg/kg
07	Magnesium as Mg		77 mg/kg
08	Chloride as Cl	Food and Agriculture organization of the united Nation Rome 2007 : 2018	96.7 mg/kg
09	Soluble Sulphate as SO ₄		0.0031 %
10	Total Phosphorus as P		2.55 mg/kg
11	Total Nitrogen as N	IS 14684 : 1999 (Reaff:2019)	308 mg/kg
12	Organic Matter	IS : 2720 Part 22: 1972 (Reaff: 2015)	1.76 %
13	Organic Carbon	IS: 2720 Part 22: 1972 (Reaff: 2015)	1.02 %

Verified by





Authorised Signatory Name: Santhosh Kumar A

Designation : Quality Manager

Note: 1. The test results are only to the sample submitted for test. 2.Any correction of the test report in full or part shall invalidate the report. 3. Sample will be retained for 15 days from the date of reporting except in case of regulatory samples or specifically instructed by client.



Report No	EHS360/TR/2022-23/ 005	Report Date	02.03.2023
Site Location	Tvl. SRI RAJALAKSHMI SAMAPPA ROUGH STONE & GRAVEL QUARRY S.F.Nos. 1120/2 & 1121/2,Bilichi Village, Coimbatore North Taluk, Coimbatore District. Cluster Extent: 7.23.0 ha		
Sampling Method	SOP Method	Sample Drawn by	Laboratory
Sample Name	Soil	Sample Code	EHS360/ 005
Sample Description	Soil 55	Sample Collected Date	24.02.2023
Qty. of Sample Received	2 KG	Sample Received On	25.02.2023
Sample Condition	Good	Test Commenced On	25.02.2023
Sampling Location Mathampalayam			

S. No	Test Parameters	Protocols	Results		
14	Texture:				
	Clay		34.4 %		
	Sand	Gravimetric Method	37.5 %		
	Silt		28.1 %		
15	Manganese as Mn		23.5 mg/kg		
16	Zinc as Zn		1.01 mg/kg		
17	Boron as B		1.3 mg/kg		
18	Potassium as K		30.8 mg/kg		
19	Cadmium as Cd	USEPA 3050 B – 1996 & USEPA 6010 C - 2000	BDL (DL : 1.0 mg/kg)		
20	Total Chromium as Cr	002.7100.10 0 2000	BDL (DL : 1.0 mg/kg)		
21	Copper as Cu		BDL (DL : 1.0 mg/kg)		
22	Lead as Pb		0.6 mg/kg		
23	Iron as Fe		2.22 mg/kg		
24	Cation Exchange Capacity	USEPA - 1986	33.3 meq/100g of soil		

Verified by

End of Report******** CHENNAL 600 083

Authorised Signatory

Name: Santhosh Kumar A Designation: Quality Manager

Note: 1. The test results are only to the sample submitted for test. 2.Any correction of the test report in full or part shall invalidate the report. 3. Sample will be retained for 15 days from the date of reporting except in case of regulatory samples or specifically instructed by client.





Report No	EHS360/TR/2022-23/ 006	Report Date	02.03.2023
Site Location	Tvl. SRI RAJALAKSHMI SAMAPPA ROUGH STONE & GRAVEL QUARRY S.F.Nos. 1120/2 & 1121/2,Bilichi Village, Coimbatore North Taluk, Coimbatore District. Cluster Extent: 7.23.0 ha		
Sampling Method	SOP Method	Sample Drawn by	Laboratory
Sample Name	Soil	Sample Code	EHS360/ 006
Sample Description	Soil 6	Sample Collected Date	24.02.2023
Qty. of Sample Received	2 KG	Sample Received On	25.02.2023
Sample Condition	Good	Test Commenced On	25.02.2023
Sampling Location	Beerjepalli		

S. No	Test Parameters	Test Parameters Protocols	
01	pH @ 25°C	IS 2720 Part 26 - 1987 (Reaff:2016)	7.55
02	Conductivity @ 25°C	IS 14767 - 2000 (Reaff : 2016)	485 µmhos/cm
03	Water Holding Capacity	By Gravimetric Method	48.4 %
04	Bulk Density	By Cylindrical Method	0.94 g/cm ³
05	Porosity	By Gravimetric Method	43.1 %
06	Calcium as Ca		138 mg/kg
07	Magnesium as Mg		88 mg/kg
08	Chloride as Cl	Food and Agriculture organization of the united Nation Rome 2007 : 2018	100 mg/kg
09	Soluble Sulphate as SO ₄		0.0011 %
10	Total Phosphorus as P		3.7 mg/kg
11	Total Nitrogen as N	IS 14684 : 1999 (Reaff:2019)	390 mg/kg
12	Organic Matter	IS : 2720 Part 22: 1972 (Reaff: 2015)	1.93 %
13	Organic Carbon	IS: 2720 Part 22: 1972 (Reaff: 2015)	1.12 %

Verified by



Authorised Signatory

Name: Santhosh Kumar A Designation : Quality Manager

Note: 1. The test results are only to the sample submitted for test. 2.Any correction of the test report in full or part shall invalidate the report. 3. Sample will be retained for 15 days from the date of reporting except in case of regulatory samples or specifically instructed by client.



	I	ı	1	
Report No	EHS360/TR/2022-23/ 006	Report Date	02.03.2023	
	Tvi. SRI RAJALAKSHMI SAMAPPA ROUGH STONE & GRAVEL QUARRY			
Site Location	S.F.Nos. 1120/2 & 1121/2,Bilichi Village, Coimbatore North Taluk,			
	Coimbatore District. Cluster Extent: 7.23.0 ha			
Sampling Method	SOP Method	Sample Drawn by	Laboratory	
Sample Name	Soil	Sample Code	EHS360/ 006	
Sample Description	Soil 6	Sample Collected Date	24.02.2023	
Qty. of Sample Received	2 KG	Sample Received On	25.02.2023	
Sample Condition	Good	Test Commenced On	25.02.2023	
Sampling Location Beerjepalli				

S. No	Test Parameters	Protocols	Results
14	Texture :		
	Clay		34.8 %
	Sand	Gravimetric Method	37.9 %
	Silt		27.3 %
15	Manganese as Mn		23.8 mg/kg
16	Zinc as Zn		1.10 mg/kg
17	Boron as B		1.06 mg/kg
18	Potassium as K		25.1 mg/kg
19	Cadmium as Cd	USEPA 3050 B – 1996 & USEPA 6010 C - 2000	BDL (DL : 1.0 mg/kg)
20	Total Chromium as Cr	0021710010 0 2000	BDL (DL: 1.0 mg/kg)
21	Copper as Cu		BDL (DL: 1.0 mg/kg)
22	Lead as Pb		0.77 mg/kg
23	Iron as Fe		2.01 mg/kg
24	Cation Exchange Capacity	USEPA - 1986	39.08 meq/100g of soil

Verified by



Authorised Signatory

Name: Santhosh Kumar A Designation : Quality Manager

Note: 1. The test results are only to the sample submitted for test. 2.Any correction of the test report in full or part shall invalidate the report. 3. Sample will be retained for 15 days from the date of reporting except in case of regulatory samples or specifically instructed by client.





Report No	EHS360/TR/2022-23/00	1 Report Date	02.03.2023
Site Location		SAMAPPA ROUGH STONE & Gl Bilichi Village, Coimbatore Nor Ster Extent: 7.23.0 ha	· · · · · · · · · · · · · · · · · · ·
Sampling Method	SOP Method	Sample Drawn by	Laboratory
Sample Name	Water	Sample Code	EHS360/001
Sample Description	Surface Water (SW-1)	Sample Collected Date	24.02.2023
Qty. of Sample Received	2 Litres	Sample Received On	25.02.2023
Sample Condition	Fit for Analysis	Test Commenced On	25.02.2023
Sampling Location	Belladhi Lake		

S.No.	Parameters	Test Method	RESULTS		
	Discipline: Chemical				
1	Colour	IS 3025 Part 4:1983	10 Hazen		
2	Odour	IS 3025 Part 5:2018	Agreeable		
3	pH at 25°C	IS 3025 Part 11:1983	7.10		
4	Conductivity @ 25°C	IS 3025 Part 14:2013	1202 µmhos/cm		
5	Turbidity	IS 3025 Part 10:1984	4.5 NTU		
6	Total Dissolved Solids	IS 3025 Part 16:1984	710 mg/l		
7	Total Hardness as CaCO ₃	IS 3025 Part 21:2009	197.76 mg/l		
8	Calcium as Ca	IS 3025 Part 40:1991	35.1 mg/l		
9	Magnesium as Mg	IS 3025 Part 46:1994	26.8 mg/l		
10	Total Alkalinity as CaCO₃	IS 3025 Part 23:1986	257.1 mg/l		
11	Chloride as Cl	IS 3025 Part 32:1988	200 mg/l		
12	Sulphate as SO ₄	IS 3025 Part 24:1986	71.7 mg/l		
13	Iron as Fe	IS 3025 Part 53:2003	0.14 mg/l		
14	Residual Free Chlorine	IS 3025 Part 26:1986	BDL (DL:0.1 mg/l)		
15	Fluoride as F	APHA 23 rd Edn. 2017:4500 F,D	0.25 mg/l		
16	Nitrate as NO₃	IS 3025 Part 34:1988	8.8 mg/l		

Verified by

*******End of Report******* CHENNAL 600 083

Authorised Signatory

Name: Santhosh Kumar A Designation : Quality Manager

Note: 1. The test results are only to the sample submitted for test. 2.Any correction of the test report in full or part shall invalidate the report. 3. Sample will be retained for 15 days from the date of reporting except in case of regulatory samples or specifically instructed by client.



TEST REPORT

Report No	EHS360/TR/2022-23/001	Report Date 02.03.202	23
Site Location	Tvl. SRI RAJALAKSHMI SAMAP S.F.Nos. 1120/2 & 1121/2,Bilichi Coimbatore District. Cluster Ext	Village, Coimbatore North 1	
Sampling Method	SOP Method	Sample Drawn by	Laboratory
Sample Name	Water	Sample Code	EHS360/001
Sample Description	Surface Water (SW-1)	Sample Collected Date	24.02.2023
Qty. of Sample Received	2 Litres	Sample Received On	25.02.2023
Sample Condition	Fit for Analysis	Test Commenced On	25.02.2023
Sampling Location Belladhi Lake			

S.No.	Parameters	Test Method	RESULTS
17	Copper as Cu	IS 3025 Part 65:2014	BDL (DL:0.01 mg/l)
18	Manganese as Mn	IS 3025 Part 65:2014	BDL (DL:0.02 mg/l)
19	Mercury as Hg	USEPA 200.8	BDL (DL:0.0005 mg/l)
20	Cadmium as Cd	IS 3025 Part 65:2014	BDL (DL:0.001 mg/l)
21	Selenium as Se	IS 3025 Part 65:2014	BDL (DL:0.005 mg/l)
22	Aluminium as Al	IS 3025 Part 65:2014 (Reaff:2019)	BDL (DL:0.005 mg/l)
23	Lead as Pb	IS 3025 Part 65:2014 (Reaff:2019)	BDL (DL:0.005 mg/l)
24	Zinc as Zn	IS 3025 Part 65:2014 (Reaff:2019)	BDL(DL : 0.05 mg/l)
25	Total Chromium as Cr	IS 3025 Part 65:2014 (Reaff:2019)	BDL(DL: 0.02 mg/l)
26	Boron as B	IS 3025 Part 65:2014 (Reaff:2019)	BDL(DL: 0.05 mg/l)
27	Mineral Oil	IS 3025 Part 39-1991 (Reaff. 2019)	BDL(DL : 0.01 mg/l)
28	Phenolic compounds as C ₆ H ₅ OH	IS 3025 Part 43-1992(Reaff: 2019)	BDL (DL:0.0005 mg/l)
29	Anionic Detergents (as MBAS)	IS 13428 – 2005 (Reaff:2019)(Annex K)	BDL (DL:0.01 mg/l)
30	Cyanide as CN	IS 3025 Part 27-1986 (Reaff. 2019)	BDL (DL:0.01 mg/l)
31	BOD @ 27°C for 3 days	IS 3025 Part 44:1993 (Reaff:2019)	6.8 mg/l
32	Chemical Oxygen Demand	IS 3025 Part 58:2006 (Reaff:2017)	40 mg/l
33	Dissolved Oxygen	IS 3025 Part 38:1989 (Reaff:2019)	5.5 mg/l
34	Barium as Ba	IS 3025 Part 65:2014 (Reaff:2019)	BDL(DL:0.05 mg/l)
35	Ammonia (as total ammonia-N)	IS 3025 Part 34-1988 (Reaff. 2019)	2.2 mg/l
36	Sulphide as H₂S	IS 3025 Part 29-1986 (Reaff: 2019)	BDL (DL:0.01 mg/l)
37	Molybdenum as Mo	IS 3025 Part 65:2014 (Reaff:2019)	BDL (DL:0.02 mg/l)
38	Total Arsenic as As	IS 3025 Part 65:2014 (Reaff:2019)	BDL (DL:0.005 mg/l)
39	Total Suspended Solids	IS 3025 Part 17 -1984 (Reaff:2017)	20.2 mg/l
	Discipline: Biological Group: Water		
40	Total Coliform	APHA 23 rd Edn. 2017:9221B	850 MPN/100ml
41	Escherichia coli	APHA 23 rd Edn. 2017:9221F	140 MPN/100ml

Verified by

Selyk

Page 1 of 4

Authorised Signatory

Name: Santhosh Kumar A Designation: Quality Manager

Note: 1. The test results are only to the sample submitted for test. 2.Any correction of the test report in full or part shall invalidate the report.

3. Sample will be retained for 15 days from the date of reporting except in case of regulatory samples or specifically instructed by client.





Report No	EHS360/TR/2022-23/002	2 Report Date	02.03.2023
Site Location		SAMAPPA ROUGH STONE & GI Bilichi Village, Coimbatore Nor ter Extent: 7.23.0 ha	
Sampling Method	SOP Method	Sample Drawn by	Laboratory
Sample Name	Water	Sample Code	EHS360/002
Sample Description	Surface Water (SW-2)	Sample Collected Date	24.02.2023
Qty. of Sample Received	2 Litres	Sample Received On	25.02.2023
Sample Condition	Fit for Analysis	Test Commenced On	25.02.2023
Sampling Location Agraharasamakulam Lake			

S.No.	Parameters	Test Method	RESULTS
	Discipline: Chemical		
1	Colour	IS 3025 Part 4:1983	5 Hazen
2	Odour	IS 3025 Part 5:2018	Agreeable
3	pH at 25°C	IS 3025 Part 11:1983	7.29
4	Conductivity @ 25°C	IS 3025 Part 14:2013	933 µmhos/cm
5	Turbidity	IS 3025 Part 10:1984	2.9 NTU
6	Total Dissolved Solids	IS 3025 Part 16:1984	550 mg/l
7	Total Hardness as CaCO ₃	IS 3025 Part 21:2009	152.17 mg/l
8	Calcium as Ca	IS 3025 Part 40:1991	27.7 mg/l
9	Magnesium as Mg	IS 3025 Part 46:1994	20.2 mg/l
10	Total Alkalinity as CaCO ₃	IS 3025 Part 23:1986	184 mg/l
11	Chloride as Cl	IS 3025 Part 32:1988	140 mg/l
12	Sulphate as SO ₄	IS 3025 Part 24:1986	65.6 mg/l
13	Iron as Fe	IS 3025 Part 53:2003	0.22 mg/l
14	Residual Free Chlorine	IS 3025 Part 26:1986	BDL (DL:0.1 mg/l)
15	Fluoride as F	APHA 23 rd Edn. 2017:4500 F,D	0.19 mg/l
16	Nitrate as NO ₃	IS 3025 Part 34:1988	7.7 mg/l

Verified by



End of Report******** CHENNAL 600 083

Authorised Signatory

Name: Santhosh Kumar A Designation : Quality Manager

Note: 1. The test results are only to the sample submitted for test. 2.Any correction of the test report in full or part shall invalidate the report. 3. Sample will be retained for 15 days from the date of reporting except in case of regulatory samples or specifically instructed by client.



Report No	EHS360/TR/2022-23/002	Report Date 02.03.2	023	
	Tvi. SRI RAJALAKSHMI SAMAPPA ROUGH STONE & GRAVEL QUARRY			
Site Location	S.F.Nos. 1120/2 & 1121/2,Bilichi Village, Coimbatore North Taluk,			
	Coimbatore District. Cluster Extent: 7.23.0 ha			
Sampling Method	SOP Method	Sample Drawn by	Laboratory	
Sample Name	Water	Sample Code	EHS360/002	
Sample Description	Surface Water (SW-2)	Sample Collected Date	24.02.2023	
Qty. of Sample Received	2 Litres	Sample Received On	25.02.2023	
Sample Condition	Fit for Analysis	Test Commenced On	25.02.2023	
Sampling Location Agraharasamakulam Lake				

S.No.	Parameters	Test Method	RESULTS
17	Copper as Cu	IS 3025 Part 65:2014	BDL (DL:0.01 mg/l)
18	Manganese as Mn	IS 3025 Part 65:2014	BDL (DL:0.02 mg/l)
19	Mercury as Hg	USEPA 200.8	BDL (DL:0.0005 mg/l)
20	Cadmium as Cd	IS 3025 Part 65:2014	BDL (DL:0.001 mg/l)
21	Selenium as Se	IS 3025 Part 65:2014	BDL (DL:0.005 mg/l)
22	Aluminium as Al	IS 3025 Part 65:2014 (Reaff:2019)	BDL (DL:0.005 mg/l)
23	Lead as Pb	IS 3025 Part 65:2014 (Reaff:2019)	BDL (DL:0.005 mg/l)
24	Zinc as Zn	IS 3025 Part 65:2014 (Reaff:2019)	BDL(DL: 0.05 mg/l)
25	Total Chromium as Cr	IS 3025 Part 65:2014 (Reaff:2019)	BDL(DL: 0.02 mg/l)
26	Boron as B	IS 3025 Part 65:2014 (Reaff:2019)	BDL(DL: 0.05 mg/l)
27	Mineral Oil	IS 3025 Part 39-1991 (Reaff. 2019)	BDL(DL : 0.01 mg/l)
28	Phenolic compounds as C ₆ H ₅ OH	IS 3025 Part 43-1992(Reaff: 2019)	BDL (DL:0.0005 mg/l)
29	Anionic Detergents (as MBAS)	IS 13428 – 2005 (Reaff:2019)(Annex K)	BDL (DL:0.01 mg/l)
30	Cyanide as CN	IS 3025 Part 27-1986 (Reaff. 2019)	BDL (DL:0.01 mg/l)
31	BOD @ 27°C for 3 days	IS 3025 Part 44:1993 (Reaff:2019)	5.1 mg/l
32	Chemical Oxygen Demand	IS 3025 Part 58:2006 (Reaff:2017)	28 mg/l
33	Dissolved Oxygen	IS 3025 Part 38:1989 (Reaff:2019)	5.5 mg/l
34	Barium as Ba	IS 3025 Part 65:2014 (Reaff:2019)	BDL(DL:0.05 mg/l)
35	Ammonia (as total ammonia-N)	IS 3025 Part 34-1988 (Reaff. 2019)	2.6 mg/l
36	Sulphide as H₂S	IS 3025 Part 29-1986 (Reaff: 2019)	BDL (DL:0.01 mg/l)
37	Molybdenum as Mo	IS 3025 Part 65:2014 (Reaff:2019)	BDL (DL:0.02 mg/l)
38	Total Arsenic as As	IS 3025 Part 65:2014 (Reaff:2019)	BDL (DL:0.005 mg/l)
39	Total Suspended Solids	IS 3025 Part 17 -1984 (Reaff:2017)	17.3 mg/l
	Discipline: Biological Group: Wate		
40	Total Coliform	APHA 23 rd Edn. 2017:9221B	800 MPN/100ml
41	Escherichia coli	APHA 23 rd Edn. 2017:9221F	90 MPN/100ml

Verified by

Authorised Signatory

Name: Santhosh Kumar A Designation: Quality Manager

Note: 1. The test results are only to the sample submitted for test. 2.Any correction of the test report in full or part shall invalidate the report. 3. Sample will be retained for 15 days from the date of reporting except in case of regulatory samples or specifically instructed by client.

*******End of Report*******

CHENNAL

600 083





Report No	EHS360/TR/2022-23/001	Report Date	02.03.2023	
	Tvi. SRI RAJALAKSHMI SAMAF		*	
Site Location	S.F.Nos. 1120/2 & 1121/2,Bilichi Village, Coimbatore North Taluk,			
	Coimbatore District. Cluster Extent: 7.23.0 ha			
Sampling Method	SOP Method	Sample Drawn by	Laboratory	
Sample Name	Water	Sample Code	EHS360/001	
Sample Description	Ground Water (WW-1)	Sample Collected Date	24.02.2023	
Qty. of Sample Received	2 Litres	Sample Received On	25.02.2023	
Sample Condition	Fit for Analysis	Test Commenced On	25.02.2023	
Sampling Location	Near Project Area		•	

S.No.	Parameters	Test Method	RESULTS
	Discipline: Chemical	Group: Water	
1	Colour	IS 3025 Part 4:1983 (Reaff:2017)	5
2	Odour	IS 3025 Part 5:2018	Agreeable
3	pH at 25°C	IS 3025 Part 11:1983 (Reaff:2017)	7.10
4	Conductivity @ 25°C	IS 3025 Part 14:2013 (Reaff:2019)	746 µmhos/cm
5	Turbidity	IS 3025 Part 10:1984 (Reaff:2017)	1.5 NTU
6	Total Dissolved Solids	IS 3025 Part 16:1984 (Reaff:2017)	440 mg/l
7	Total Hardness as CaCO ₃	IS 3025 Part 21:2009 (Reaff:2019)	136.18 mg/l
8	Calcium as Ca	IS 3025 Part 40:1991 (Reaff:2019)	24.1 mg/l
9	Magnesium as Mg	IS 3025 Part 46:1994 (Reaff:2019)	18.5 mg/l
10	Total Alkalinity as CaCO ₃	IS 3025 Part 23:1986 (Reaff:2019)	124 mg/l
11	Chloride as Cl	IS 3025 Part 32:1988 (Reaff:2019)	97.5 mg/l
12	Sulphate as SO ₄	IS 3025 Part 24:1986 (Reaff:2019)	57.2 mg/l
13	Iron as Fe	IS 3025 Part 53:2003 (Reaff:2019)	0.29 mg/l
14	Residual Free Chlorine	IS 3025 Part 26:1986 (Reaff:2019)	BDL (DL:0.1 mg/l)
15	Fluoride as F	APHA 23 rd Edn. 2017:4500 F,D	0.21 mg/l
16	Nitrate as NO ₃	IS 3025 Part 34:1988 (Reaff:2019)	8.1 mg/l

Verified by



*******End of Report******* CHENNAL 600 083

Authorised Signatory Name: Santhosh Kumar A

Designation : Quality Manager

Note: 1. The test results are only to the sample submitted for test. 2.Any correction of the test report in full or part shall invalidate the report. 3. Sample will be retained for 15 days from the date of reporting except in case of regulatory samples or specifically instructed by client.

^{4.} Perishable samples will be discarded immediately after reporting. 5. Under no circumstance's lab accepts any liability or loss/damage caused by use or misuse of test report after invoicing or issued of test report.



TEST REPORT

Report No	EHS360/TR/2022-23/001	Report Date	02.03.2023
Site Location	Tvl. SRI RAJALAKSHMI SAMAPPA ROUGH STONE & GRAVEL QUARRY S.F.Nos. 1120/2 & 1121/2,Bilichi Village, Coimbatore North Taluk, Coimbatore District. Cluster Extent: 7.23.0 ha		
Sampling Method	SOP Method	Sample Drawn by	Laboratory
Sample Name	Water	Sample Code	EHS360/001
Sample Description	Ground Water (WW-1)	Sample Collected Date	24.02.2023
Qty. of Sample Received	2 Litres	Sample Received On	25.02.2023
Sample Condition	Fit for Analysis	Test Commenced On	25.02.2023
Sampling Location	Near Project Area		

S.No.	Parameters	Test Method	RESULTS
17	Copper as Cu	IS 3025 Part 65:2014 (Reaff:2019)	BDL (DL:0.01 mg/l)
18	Manganese as Mn	IS 3025 Part 65:2014 (Reaff:2019)	BDL (DL:0.02 mg/l)
19	Mercury as Hg	USEPA 200.8	BDL (DL:0.0005 mg/l)
20	Cadmium as Cd	IS 3025 Part 65:2014 (Reaff:2019)	BDL (DL:0.001 mg/l)
21	Selenium as Se	IS 3025 Part 65:2014 (Reaff:2019)	BDL (DL:0.005 mg/l)
22	Aluminium as Al	IS 3025 Part 65:2014 (Reaff:2019)	BDL (DL:0.005 mg/l)
23	Lead as Pb	IS 3025 Part 65:2014 (Reaff:2019)	BDL (DL:0.005 mg/l)
24	Zinc as Zn	IS 3025 Part 65:2014 (Reaff:2019)	BDL(DL : 0.05 mg/l)
25	Total Chromium as Cr	IS 3025 Part 65:2014 (Reaff:2019)	BDL(DL: 0.02 mg/l)
26	Boron as B	IS 3025 Part 65:2014 (Reaff:2019)	BDL(DL : 0.05 mg/l)
27	Mineral Oil	IS 3025 Part 39-1991 (Reaff. 2019)	BDL(DL: 0.01 mg/l)
28	Phenolic compounds as C ₆ H ₅ OH	IS 3025 Part 43-1992(Reaff: 2019)	BDL (DL:0.0005 mg/l)
29	Anionic Detergents (as MBAS)	IS 13428 – 2005 (Reaff:2019) (Annex K)	BDL (DL:0.01 mg/l)
30	Cyanide as CN	IS 3025 Part 27-1986 (Reaff. 2019)	BDL (DL:0.01 mg/l)
31	Barium as Ba	IS 3025 Part 44:1993 (Reaff:2019)	BDL(DL:0.05 mg/l)
32	Ammonia (as total ammonia-N)	IS 3025 Part 58:2006 (Reaff:2017)	BDL (DL:0.01 mg/l)
33	Sulphide as H ₂ S	IS 3025 Part 38:1989 (Reaff:2019)	BDL (DL:0.01 mg/l)
34	Molybdenum as Mo	IS 3025 Part 65:2014 (Reaff:2019)	BDL (DL:0.02 mg/l)
35	Total Arsenic as As	IS 3025 Part 34-1988 (Reaff. 2019)	BDL (DL:0.005 mg/l)
36	Total Suspended Solids	IS 3025 Part 29-1986 (Reaff: 2019)	BDL (DL:1.0 mg/l)
	Discipline: Biological		
37	Total Coliform	APHA 23 rd Edn. 2017:9221B	190 MPN/100ml
38	Escherichia coli	APHA 23 rd Edn. 2017:9221F	< 1.8 MPN/100ml

Verified by

Selyk

Authorised Signatory

Name: Santhosh Kumar A
Designation: Quality Manager

Note: 1. The test results are only to the sample submitted for test. 2. Any correction of the test report in full or part shall invalidate the report.

3. Sample will be retained for 15 days from the date of reporting except in case of regulatory samples or specifically instructed by client.

CHENNAL

600 083

*******End of Report******





Report No	EHS360/TR/2022-23/002	Report Date	02.03.2023	
Site Location	Tvl. SRI RAJALAKSHMI SAMAPPA ROUGH STONE & GRAVEL QUARRY S.F.Nos. 1120/2 & 1121/2,Bilichi Village, Coimbatore North Taluk, Coimbatore District. Cluster Extent: 7.23.0 ha			
Sampling Method	SOP Method	Sample Drawn by	Laboratory	
Sample Name	Water	Sample Code	EHS360/002	
Sample Description	Ground Water (WW-2)	Sample Collected Date	24.02.2023	
Qty. of Sample Received	2 Litres	Sample Received On	25.02.2023	
Sample Condition	Fit for Analysis	Test Commenced On	25.02.2023	
Sampling Location	Krishnapuram		•	

S.No.	Parameters	Test Method	RESULTS
	Discipline: Chemical	Group: Water	
1	Colour	IS 3025 Part 4:1983 (Reaff:2017)	5
2	Odour	IS 3025 Part 5:2018	Agreeable
3	pH at 25°C	IS 3025 Part 11:1983 (Reaff:2017)	7.73
4	Conductivity @ 25°C	IS 3025 Part 14:2013 (Reaff:2019)	934 µmhos/cm
5	Turbidity	IS 3025 Part 10:1984 (Reaff:2017)	2.2 NTU
6	Total Dissolved Solids	IS 3025 Part 16:1984 (Reaff:2017)	550 mg/l
7	Total Hardness as CaCO ₃	IS 3025 Part 21:2009 (Reaff:2019)	203.05 mg/l
8	Calcium as Ca	IS 3025 Part 40:1991 (Reaff:2019)	35.9 mg/l
9	Magnesium as Mg	IS 3025 Part 46:1994 (Reaff:2019)	27.6 mg/l
10	Total Alkalinity as CaCO ₃	IS 3025 Part 23:1986 (Reaff:2019)	165 mg/l
11	Chloride as Cl	IS 3025 Part 32:1988 (Reaff:2019)	130 mg/l
12	Sulphate as SO ₄	IS 3025 Part 24:1986 (Reaff:2019)	75 mg/l
13	Iron as Fe	IS 3025 Part 53:2003 (Reaff:2019)	0.23 mg/l
14	Residual Free Chlorine	IS 3025 Part 26:1986 (Reaff:2019)	BDL (DL:0.1 mg/l)
15	Fluoride as F	APHA 23 rd Edn. 2017:4500 F,D	0.21 mg/l
16	Nitrate as NO ₃	IS 3025 Part 34:1988 (Reaff:2019)	5.8 mg/l

Verified by



*******End of Report******* CHENNAL 600 083

Authorised Signatory Name: Santhosh Kumar A

Designation : Quality Manager

Note: 1. The test results are only to the sample submitted for test. 2.Any correction of the test report in full or part shall invalidate the report. 3. Sample will be retained for 15 days from the date of reporting except in case of regulatory samples or specifically instructed by client.



Report No	EHS360/TR/2022-23/002	Report Date	02.03.2023		
O'() I was the		Tvi. SRI RAJALAKSHMI SAMAPPA ROUGH STONE & GRAVEL QUARRY			
Site Location	S.F.Nos. 1120/2 & 1121/2, Bilichi Village, Coimbatore North Taluk, Coimbatore District. Cluster Extent: 7.23.0 ha				
Sampling Method	SOP Method	Sample Drawn by	Laboratory		
Sample Name	Water	Sample Code	EHS360/002		
Sample Description	Ground Water (WW-2)	Sample Collected Date	24.02.2023		
Qty. of Sample Received	2 Litres	Sample Received On	25.02.2023		
Sample Condition	Fit for Analysis	Test Commenced On	25.02.2023		
Sampling Location	Krishnapuram				

S.No.	Parameters	Test Method	RESULTS
17	Copper as Cu	IS 3025 Part 65:2014 (Reaff:2019)	BDL (DL:0.01 mg/l)
18	Manganese as Mn	IS 3025 Part 65:2014 (Reaff:2019)	BDL (DL:0.02 mg/l)
19	Mercury as Hg	USEPA 200.8	BDL (DL:0.0005 mg/l)
20	Cadmium as Cd	IS 3025 Part 65:2014 (Reaff:2019)	BDL (DL:0.001 mg/l)
21	Selenium as Se	IS 3025 Part 65:2014 (Reaff:2019)	BDL (DL:0.005 mg/l)
22	Aluminium as Al	IS 3025 Part 65:2014 (Reaff:2019)	BDL (DL:0.005 mg/l)
23	Lead as Pb	IS 3025 Part 65:2014 (Reaff:2019)	BDL (DL:0.005 mg/l)
24	Zinc as Zn	IS 3025 Part 65:2014 (Reaff:2019)	BDL(DL: 0.05 mg/l)
25	Total Chromium as Cr	IS 3025 Part 65:2014 (Reaff:2019)	BDL(DL: 0.02 mg/l)
26	Boron as B	IS 3025 Part 65:2014 (Reaff:2019)	BDL(DL: 0.05 mg/l)
27	Mineral Oil	IS 3025 Part 39-1991 (Reaff. 2019)	BDL(DL: 0.01 mg/l)
28	Phenolic compounds as C ₆ H ₅ OH	IS 3025 Part 43-1992(Reaff: 2019)	BDL (DL:0.0005 mg/l)
29	Anionic Detergents (as MBAS)	IS 13428 – 2005 (Reaff:2019) (Annex K)	BDL (DL:0.01 mg/l)
30	Cyanide as CN	IS 3025 Part 27-1986 (Reaff. 2019)	BDL (DL:0.01 mg/l)
31	Barium as Ba	IS 3025 Part 44:1993 (Reaff:2019)	BDL(DL:0.05 mg/l)
32	Ammonia (as total ammonia-N)	IS 3025 Part 58:2006 (Reaff:2017)	BDL (DL:0.01 mg/l)
33	Sulphide as H ₂ S	IS 3025 Part 38:1989 (Reaff:2019)	BDL (DL:0.01 mg/l)
34	Molybdenum as Mo	IS 3025 Part 65:2014 (Reaff:2019)	BDL (DL:0.02 mg/l)
35	Total Arsenic as As	IS 3025 Part 34-1988 (Reaff. 2019)	BDL (DL:0.005 mg/l)
36	Total Suspended Solids	IS 3025 Part 29-1986 (Reaff: 2019)	BDL (DL:1.0 mg/l)
	Discipline: Biological Group: Water		
37	Total Coliform	APHA 23 rd Edn. 2017:9221B	140 MPN/100ml
38	Escherichia coli	APHA 23 rd Edn. 2017:9221F	< 1.8 MPN/100ml

Verified by

******End of Report CHENNAL 600 083

Authorised Signatory

Name: Santhosh Kumar A Designation : Quality Manager

Note: 1. The test results are only to the sample submitted for test. 2.Any correction of the test report in full or part shall invalidate the report. 3. Sample will be retained for 15 days from the date of reporting except in case of regulatory samples or specifically instructed by client.





Report No	EHS360/TR/2022-23/001	Report Date	02.03.2023	
	Tvi. SRI RAJALAKSHMI SAMAPPA ROUGH STONE & GRAVEL QUARRY			
Site Location	S.F.Nos. 1120/2 & 1121/2,Bilichi Village, Coimbatore North Taluk,			
	Coimbatore District. Cluster Extent: 7.23.0 ha			
Sampling Method	SOP Method	Sample Drawn by	Laboratory	
Sample Name	Water	Sample Code	EHS360/001	
Sample Description	Ground Water (BW -1)	Sample Collected Date	24.02.2023	
Qty. of Sample Received	2 Litres	Sample Received On	25.02.2023	
Sample Condition	Fit for Analysis	Test Commenced On	25.02.2023	
Sampling Location	Near Project Area	•		

S.No.	Parameters	Test Method	RESULTS
	Discipline: Chemical	Group: Water	
1	Colour	IS 3025 Part 4:1983 (Reaff:2017)	5
2	Odour	IS 3025 Part 5:2018	Agreeable
3	pH at 25°C	IS 3025 Part 11:1983 (Reaff:2017)	8.03
4	Conductivity @ 25°C	IS 3025 Part 14:2013 (Reaff:2019)	785 µmhos/cm
5	Turbidity	IS 3025 Part 10:1984 (Reaff:2017)	1.1 NTU
6	Total Dissolved Solids	IS 3025 Part 16:1984 (Reaff:2017)	463 mg/l
7	Total Hardness as CaCO ₃	IS 3025 Part 21:2009 (Reaff:2019)	156.82 mg/l
8	Calcium as Ca	IS 3025 Part 40:1991 (Reaff:2019)	26.6 mg/l
9	Magnesium as Mg	IS 3025 Part 46:1994 (Reaff:2019)	22 mg/l
10	Total Alkalinity as CaCO ₃	IS 3025 Part 23:1986 (Reaff:2019)	138 mg/l
11	Chloride as Cl	IS 3025 Part 32:1988 (Reaff:2019)	114 mg/l
12	Sulphate as SO ₄	IS 3025 Part 24:1986 (Reaff:2019)	65.4 mg/l
13	Iron as Fe	IS 3025 Part 53:2003 (Reaff:2019)	0.22 mg/l
14	Residual Free Chlorine	IS 3025 Part 26:1986 (Reaff:2019)	BDL (DL:0.1 mg/l)
15	Fluoride as F	APHA 23 rd Edn. 2017:4500 F,D	0.15 mg/l
16	Nitrate as NO ₃	IS 3025 Part 34:1988 (Reaff:2019)	3.2 mg/l

Verified by





Authorised Signatory

Name: Santhosh Kumar A Designation : Quality Manager

Note: 1. The test results are only to the sample submitted for test. 2.Any correction of the test report in full or part shall invalidate the report. 3. Sample will be retained for 15 days from the date of reporting except in case of regulatory samples or specifically instructed by client.



Report No	EHS360/TR/2022-23/001	Report Date	02.03.2023	
Site Location	Tvl. SRI RAJALAKSHMI SAMAPPA ROUGH STONE & GRAVEL QUARRY S.F.Nos. 1120/2 & 1121/2,Bilichi Village, Coimbatore North Taluk, Coimbatore District. Cluster Extent: 7.23.0 ha			
Sampling Method	SOP Method	Sample Drawn by	Laboratory	
Sample Name	Water	Sample Code	EHS360/001	
Sample Description	Ground Water (BW -1)	Sample Collected Date	24.02.2023	
Qty. of Sample Received	2 Litres	Sample Received On	25.02.2023	
Sample Condition	Fit for Analysis	Test Commenced On	25.02.2023	
Sampling Location	Near Project Area			

S.No.	Parameters	Test Method	RESULTS
17	Copper as Cu	IS 3025 Part 65:2014 (Reaff:2019)	BDL (DL:0.01 mg/l)
18	Manganese as Mn	IS 3025 Part 65:2014 (Reaff:2019)	BDL (DL:0.02 mg/l)
19	Mercury as Hg	USEPA 200.8	BDL (DL:0.0005 mg/l)
20	Cadmium as Cd	IS 3025 Part 65:2014 (Reaff:2019)	BDL (DL:0.001 mg/l)
21	Selenium as Se	IS 3025 Part 65:2014 (Reaff:2019)	BDL (DL:0.005 mg/l)
22	Aluminium as Al	IS 3025 Part 65:2014 (Reaff:2019)	BDL (DL:0.005 mg/l)
23	Lead as Pb	IS 3025 Part 65:2014 (Reaff:2019)	BDL (DL:0.005 mg/l)
24	Zinc as Zn	IS 3025 Part 65:2014 (Reaff:2019)	BDL(DL : 0.05 mg/l)
25	Total Chromium as Cr	IS 3025 Part 65:2014 (Reaff:2019)	BDL(DL: 0.02 mg/l)
26	Boron as B	IS 3025 Part 65:2014 (Reaff:2019)	BDL(DL : 0.05 mg/l)
27	Mineral Oil	IS 3025 Part 39-1991 (Reaff. 2019)	BDL(DL: 0.01 mg/l)
28	Phenolic compounds as C ₆ H ₅ OH	IS 3025 Part 43-1992(Reaff: 2019)	BDL (DL:0.0005 mg/l)
29	Anionic Detergents (as MBAS)	IS 13428 – 2005 (Reaff:2019) (Annex K)	BDL (DL:0.01 mg/l)
30	Cyanide as CN	IS 3025 Part 27-1986 (Reaff. 2019)	BDL (DL:0.01 mg/l)
31	Barium as Ba	IS 3025 Part 44:1993 (Reaff:2019)	BDL(DL:0.05 mg/l)
32	Ammonia (as total ammonia-N)	IS 3025 Part 58:2006 (Reaff:2017)	BDL (DL:0.01 mg/l)
33	Sulphide as H₂S	IS 3025 Part 38:1989 (Reaff:2019)	BDL (DL:0.01 mg/l)
34	Molybdenum as Mo	IS 3025 Part 65:2014 (Reaff:2019)	BDL (DL:0.02 mg/l)
35	Total Arsenic as As	IS 3025 Part 34-1988 (Reaff. 2019)	BDL (DL:0.005 mg/l)
36	Total Suspended Solids	IS 3025 Part 29-1986 (Reaff: 2019)	BDL (DL:1.0 mg/l)
	Discipline: Biological Group: Water		
37	Total Coliform	APHA 23 rd Edn. 2017:9221B	90 MPN/100ml
38	Escherichia coli	APHA 23 rd Edn. 2017:9221F	< 1.8 MPN/100ml

Verified by

Selyk

Authorised Signatory

Name: Santhosh Kumar A Designation: Quality Manager

Note: 1. The test results are only to the sample submitted for test. 2. Any correction of the test report in full or part shall invalidate the report.

3. Sample will be retained for 15 days from the date of reporting except in case of regulatory samples or specifically instructed by client.

CHENNAL

600 083

*******End of Report******





Report No	EHS360/TR/2022-23/002	Report Date	02.03.2023	
Site Location	Tvl. SRI RAJALAKSHMI SAMAPPA ROUGH STONE & GRAVEL QUARRY S.F.Nos. 1120/2 & 1121/2,Bilichi Village, Coimbatore North Taluk, Coimbatore District. Cluster Extent: 7.23.0 ha			
Sampling Method	SOP Method	Sample Drawn by	Laboratory	
Sample Name	Water	Sample Code	EHS360/002	
Sample Description	Ground Water (BW -2)	Sample Collected Date	24.02.2023	
Qty. of Sample Received	2 Litres	Sample Received On	25.02.2023	
Sample Condition	Fit for Analysis	Test Commenced On	25.02.2023	
Sampling Location	Periya Puthur			

S.No.	Parameters	Test Method	RESULTS
	Discipline: Chemical	Group: Water	
1	Colour	IS 3025 Part 4:1983 (Reaff:2017)	5
2	Odour	IS 3025 Part 5:2018	Agreeable
3	pH at 25°C	IS 3025 Part 11:1983 (Reaff:2017)	7.99
4	Conductivity @ 25°C	IS 3025 Part 14:2013 (Reaff:2019)	813 µmhos/cm
5	Turbidity	IS 3025 Part 10:1984 (Reaff:2017)	1.5 NTU
6	Total Dissolved Solids	IS 3025 Part 16:1984 (Reaff:2017)	480 mg/l
7	Total Hardness as CaCO ₃	IS 3025 Part 21:2009 (Reaff:2019)	168.18 mg/l
8	Calcium as Ca	IS 3025 Part 40:1991 (Reaff:2019)	30 mg/l
9	Magnesium as Mg	IS 3025 Part 46:1994 (Reaff:2019)	22.7 mg/l
10	Total Alkalinity as CaCO ₃	IS 3025 Part 23:1986 (Reaff:2019)	140 mg/l
11	Chloride as Cl	IS 3025 Part 32:1988 (Reaff:2019)	112 mg/l
12	Sulphate as SO ₄	IS 3025 Part 24:1986 (Reaff:2019)	55 mg/l
13	Iron as Fe	IS 3025 Part 53:2003 (Reaff:2019)	0.22 mg/l
14	Residual Free Chlorine	IS 3025 Part 26:1986 (Reaff:2019)	BDL (DL:0.1 mg/l)
15	Fluoride as F	APHA 23 rd Edn. 2017:4500 F,D	0.19 mg/l
16	Nitrate as NO ₃	IS 3025 Part 34:1988 (Reaff:2019)	4.9 mg/l

Verified by



*******End of Report******* CHENNAL 600 083

Authorised Signatory

Name: Santhosh Kumar A Designation : Quality Manager

Note: 1. The test results are only to the sample submitted for test. 2.Any correction of the test report in full or part shall invalidate the report. 3. Sample will be retained for 15 days from the date of reporting except in case of regulatory samples or specifically instructed by client.



Report No	EHS360/TR/2022-23/002	Report Date	02.03.2023	
Site Location	Tvl. SRI RAJALAKSHMI SAMAPPA ROUGH STONE & GRAVEL QUARRY S.F.Nos. 1120/2 & 1121/2,Bilichi Village, Coimbatore North Taluk, Coimbatore District. Cluster Extent: 7.23.0 ha			
Sampling Method	SOP Method	Sample Drawn by	Laboratory	
Sample Name	Water	Sample Code	EHS360/002	
Sample Description	Ground Water (BW -2)	Sample Collected Date	24.02.2023	
Qty. of Sample Received	2 Litres	Sample Received On	25.02.2023	
Sample Condition	Fit for Analysis	Test Commenced On	25.02.2023	
Sampling Location	Periya Puthur			

S.No.	Parameters	Test Method	RESULTS	
17	Copper as Cu	IS 3025 Part 65:2014 (Reaff:2019)	BDL (DL:0.01 mg/l)	
18	Manganese as Mn	IS 3025 Part 65:2014 (Reaff:2019)	BDL (DL:0.02 mg/l)	
19	Mercury as Hg	USEPA 200.8	BDL (DL:0.0005 mg/l)	
20	Cadmium as Cd	IS 3025 Part 65:2014 (Reaff:2019)	BDL (DL:0.001 mg/l)	
21	Selenium as Se	IS 3025 Part 65:2014 (Reaff:2019)	BDL (DL:0.005 mg/l)	
22	Aluminium as Al	IS 3025 Part 65:2014 (Reaff:2019)	BDL (DL:0.005 mg/l)	
23	Lead as Pb	IS 3025 Part 65:2014 (Reaff:2019)	BDL (DL:0.005 mg/l)	
24	Zinc as Zn	IS 3025 Part 65:2014 (Reaff:2019)	BDL(DL : 0.05 mg/l)	
25	Total Chromium as Cr	IS 3025 Part 65:2014 (Reaff:2019)	BDL(DL : 0.02 mg/l)	
26	Boron as B	IS 3025 Part 65:2014 (Reaff:2019)	BDL(DL: 0.05 mg/l)	
27	Mineral Oil	IS 3025 Part 39-1991 (Reaff. 2019)	BDL(DL : 0.01 mg/l)	
28	Phenolic compounds as C ₆ H ₅ OH	IS 3025 Part 43-1992(Reaff: 2019)	BDL (DL:0.0005 mg/l)	
29	Anionic Detergents (as MBAS)	IS 13428 – 2005 (Reaff:2019) (Annex K)	BDL (DL:0.01 mg/l)	
30	Cyanide as CN	IS 3025 Part 27-1986 (Reaff. 2019)	BDL (DL:0.01 mg/l)	
31	Barium as Ba	IS 3025 Part 44:1993 (Reaff:2019)	BDL(DL:0.05 mg/l)	
32	Ammonia (as total ammonia-N)	IS 3025 Part 58:2006 (Reaff:2017)	BDL (DL:0.01 mg/l)	
33	Sulphide as H₂S	IS 3025 Part 38:1989 (Reaff:2019)	BDL (DL:0.01 mg/l)	
34	Molybdenum as Mo	IS 3025 Part 65:2014 (Reaff:2019)	BDL (DL:0.02 mg/l)	
35	Total Arsenic as As	IS 3025 Part 34-1988 (Reaff. 2019)	BDL (DL:0.005 mg/l)	
36	Total Suspended Solids	IS 3025 Part 29-1986 (Reaff: 2019)	BDL (DL:1.0 mg/l)	
	Discipline: Biological Group: Water			
37	Total Coliform	APHA 23 rd Edn. 2017:9221B	220 MPN/100ml	
38	Escherichia coli	APHA 23 rd Edn. 2017:9221F	< 1.8 MPN/100ml	

Verified by

Authorised Signatory

Name: Santhosh Kumar A Designation: Quality Manager

Note: 1. The test results are only to the sample submitted for test. 2.Any correction of the test report in full or part shall invalidate the report. 3. Sample will be retained for 15 days from the date of reporting except in case of regulatory samples or specifically instructed by client.

******End of Report

CHENNAL

600 083







National Accreditation Board for Education and Training



Certificate of Accreditation

Geo Exploration & Mining Solutions, Salem

95/1, Brindavan Road, 4th Cross East, Fairlands, Salem – 636 016 Tamil Nadu

The organization is accredited as **Category-A** under the QCI-NABET Scheme for Accreditation of EIA Consultant Organization, Version 3: for preparing EIA-EMP reports in the following Sectors –

S.No	Sector Description		Sector (as per)	
			MoEFCC	Cat.
1	Mining of minerals opencast only	1	1 (a) (i)	Α
2	Industrial estates/ parks/ complexes/areas, export processing Zones (EPZs), Special Economic Zones (SEZs), Biotech Parks, Leather Complexes	31	7 (c)	В
3	Building and construction projects	38	8(a)	В

Note: Names of approved EIA Coordinators and Functional Area Experts are mentioned in RAAC minutes dated Jan 06, 2023 and posted on QCI-NABET website.

The Accreditation shall remain in force subject to continued compliance to the terms and conditions mentioned in QCI-NABET's letter of accreditation bearing no QCI/NABET/ENV/ACO/23/2684 dated Feb 20, 2023. The accreditation needs to be renewed before the expiry date by Geo Exploration & Mining Solutions, Salem following due process of assessment.

Saint.

Sr. Director, NABET Dated: Feb 20, 2023

Certificate No.
NABET/EIA/2225/RA 0276

Valid up to August 06, 2025

For the updated List of Accredited EIA Consultant Organizations with approved Sectors please refer to the QCI-NABET website.

